# SITE DEVELOPMENT PLANS

FOR

# DATABANK ORANGEBURG PHASE 2 (LGA-4)

2000 CORPORATE DRIVE ORANGEBURG, NY 10962

DESIGN TEAM

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PROPERTY INFORMATION

OWNER AND APPLICANT
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CONTACT: TONY QORRI

RECORD OWNER

TAX MAP SECTION: 73.15
BLOCK: 1
LOT: 19

DISTRICTS

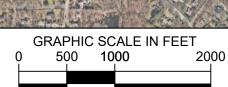
ZONING: LIO - LIGHT INDUSTRIAL-OFFICE DISTRICT
SCHOOL: PEARL RIVER
FIRE: PEARL RIVER

WATER: VEOLIA NEW YORK
LIGHTING: TOWN OF ORANGETOWN
SEWER: TOWN OF ORANGETOWN



SITE LOCATION MAP





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C-0.0	COVER SHEET	
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	SURVEY - JANUARY 4, 2023	
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C-2.1	OVERALL SITE REMOVALS PLAN	
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C-7.1	SITE DETAILS	
C-7.2	SITE DETAILS	
C-7.3	SITE DETAILS	
C-7.4	SITE DETAILS	
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LA-1.0	OVERALL LANDSCAPE PLAN	
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LA-1.2	LANDSCAPE NOTES AND DETAILS	
LT-1.0	OVERALL LIGHTING PLAN	
LT-1.1	LIGHTING PLAN	
LT-1.2	LIGHTING DETAILS	

SHEET LIST TABLE

THIS SITE PLAN HAS BEEN APPRO ORANGETOWN PLANNING BOARD, NEW YORK.	
	DATE
BOARD CHAIRMAN	
THIS SITE PLAN HAS BEEN APPRO ORANGETOWN PLANNING BOARD, NEW YORK	
	DATE
BOARD SECRETARY	
THIS SITE PLAN HAS BEEN APPRO ORANGETOWN PLANNING BOARD, NEW YORK.	

**BOARD ENGINEER** 

TITLE

DATE

THIS SITE PLAN HAS BEEN APPROYOWNER.	VED BY THE PROPERTY
	DATE
PROPERTY OWNER TITLE	



Know what's BELOW.

CALL before you dig.

CALL AT LEAST TWO WORKING DAYS BEFORE YOU DIG

THE EXACT LOCATION OF UTILITIES SHOWN IN THIS PLAN SET ARE UNKNOWN.
THE CONTRACTOR SHALL FIELD VERIFY ALL LOCATIONS AND DEPTHS OF
EXISTING UTILITIES (IN CONFLICT WITH PROPOSED IMPROVEMENTS) BY
CALLING 811 AT LEAST 2 WORKING DAYS PRIOR TO STARTING ANY EXCAVATION.

SHEET NUMBER

C-0.0

WARNING - NO ALTERATION LEGAL NOTICE: IT IS A VIOLATION OF ARTICLE 145 OF THE NEW YORK, P.C. AND IS INTENDED ONLY FOR THE SPECIFIC PURPOSE AND CLIENT FOR WHICH IT WAS PREPARED. REUSE OF AND IMPROPER RELIANCE ON THIS DOCUMENT WITHOUT WRITTEN AUTHORIZATION AND ADAPTATION BY KIMLEY-HORN ENGINEERING AND LANDSCAPE ARCHITECTURE OF NEW YORK, P.C.



### **GENERAL CONSTRUCTION NOTES**

- NO WORK CAN BEGIN WITHOUT PERMIT IN HAND. PERMIT ISSUED UPON MEETING CONDITIONS OF PLANNING BOARD APPROVALS OBTAINED, FINAL SITE PLAN IS STAMPED, AND CONSTRUCTION PLANS ARE APPROVED BY BUILDING INSPECTOR. THE CONTRACTOR AND SUBCONTRACTORS SHOULD BE FAMILIAR WITH ALL STATE AND LOCAL REQUIREMENTS RELATED TO SITE CONSTRUCTION ACTIVITIES PRIOR TO COMMENCING WORK. ALL WORK SHALL CONFORM AS APPLICABLE TO THESE GOVERNING STANDARDS AND SPECIFICATIONS.
- 3. THE CONTRACTOR SHALL BE RESPONSIBLE FOR FURNISHING ALL MATERIAL AND LABOR TO CONSTRUCT THE FACILITY AS SHOWN AND DESCRIBED IN THE CONSTRUCTION DOCUMENTS IN ACCORDANCE WITH THE APPROPRIATE APPROVING AUTHORITIES, SPECIFICATIONS AND REQUIREMENTS, CONTRACTOR SHALL CLEAR AND GRUB ALL AREAS UNLESS OTHERWISE INDICATED, REMOVING TREES, STUMPS, ROOTS, MUCK, EXISTING PAVEMENT AND ALL OTHER DELETERIOUS MATERIAL.
- EXISTING UTILITIES SHOWN ARE LOCATED ACCORDING TO THE INFORMATION AVAILABLE TO THE ENGINEER AT THE TIME OF THE TOPOGRAPHIC SURVEY AND HAVE NOT BEEN INDEPENDENTLY VERIFIED BY THE OWNER OR THE ENGINEER. GUARANTEE IS NOT MADE THAT ALL EXISTING UNDERGROUND UTILITIES ARE SHOWN OR THAT THE LOCATION OF THOSE SHOWN ARE ENTIRELY ACCURATE, FINDING THE ACTUAL LOCATION OF ANY EXISTING UTILITIES IS THE CONTRACTOR'S RESPONSIBILITY AND SHALL BE DONE BEFORE COMMENCING ANY WORK IN THE VICINITY. FURTHERMORE, THE CONTRACTOR SHALL BE FULLY RESPONSIBLE FOR ANY AND ALL DAMAGES DUE TO THE CONTRACTOR'S FAILURE TO EXACTLY LOCATE AND PRESERVE ANY AND ALL UNDERGROUND UTILITIES. THE OWNER OR ENGINEER WILL ASSUME NO LIABILITY FOR ANY DAMAGES SUSTAINED OR COST INCURRED BECAUSE OF THE OPERATIONS IN THE VICINITY OF EXISTING UTILITIES OR STRUCTURES. NOR FOR TEMPORARY BRACING AND SHORING OF SAME. IF IT IS NECESSARY TO SHORE, BRACE, SWING OR RELOCATE A UTILITY, THE UTILITY COMPANY OR DEPARTMENT AFFECTED SHALL BE CONTACTED AND THEIR PERMISSION OBTAINED REGARDING THE METHOD TO USE FOR SUCH WORK.
- 5. THE TOWN OF ORANGETOWN SEWER INSPECTOR SHALL BE NOTIFIED AT LEAST 48 HOURS IN ADVANCE OF ANY AND ALL CONSTRUCTION ON OR NEAR EXISTING AND PROPOSED SANITARY SEWER FACILITIES.

6. ALL UTILITIES, INCLUDING ELECTRIC AND TELEPHONE SERVICE, SHALL BE INSTALLED UNDERGROUND.

- 7. IT IS THE CONTRACTOR'S RESPONSIBILITY TO CONTACT THE VARIOUS UTILITY COMPANIES WHICH MAY HAVE BURIED OR AERIAL UTILITIES WITHIN OR NEAR THE CONSTRUCTION AREA BEFORE COMMENCING WORK. THE CONTRACTOR SHALL PROVIDE 72 HOURS MINIMUM NOTICE TO ALL UTILITY COMPANIES PRIOR TO BEGINNING CONSTRUCTION. AN APPROXIMATE LIST OF THE UTILITY COMPANIES WHICH THE CONTRACTOR MUST CALL BEFORE COMMENCING WORK IS PROVIDED ON THE COVER SHEET OF THESE CONSTRUCTION PLANS. THIS LIST SERVES AS A GUIDE ONLY AND IS NOT INTENDED TO LIMIT THE UTILITY COMPANIES WHICH THE CONTRACTOR MAY WISH TO NOTIFY.
- 8. THE OWNER SHALL BE RESPONSIBLE FOR OBTAINING ALL REQUIRED CONSTRUCTION PERMITS PRIOR TO CONSTRUCTION. THE CONTRACTOR SHALL HAVE AVAILABLE AT THE JOB SITE AT ALL TIMES ONE COPY OF THE CONSTRUCTION DOCUMENTS
- INCLUDING PLANS, SPECIFICATIONS, GEOTECHNICAL REPORT AND SPECIAL CONDITIONS AND COPIES OF ANY REQUIRED 10. ANY DISCREPANCIES ON THE DRAWINGS SHALL BE IMMEDIATELY BROUGHT TO THE ATTENTION OF THE OWNER AND
- ENGINEER BEFORE COMMENCING WORK. NO FIELD CHANGES OR DEVIATIONS FROM DESIGN ARE TO BE MADE WITHOUT PRIOR APPROVAL OF THE OWNER AND NOTIFICATION TO THE ENGINEER.
- 11. DURING THE COURSE OF THE WORK, THE CONTRACTOR SHALL MAINTAIN AN ACCURATE RECORD OF ANY AND ALL CHANGES RELATED TO FIELD CONDITIONS, INCLUDING AREAS OF ROCK EXCAVATION. UPON COMPLETION OF THE WORK, THE CONTRACTOR SHALL FILE WITH THE OWNER A COMPLETE SET OF "AS CONSTRUCTED" DRAWINGS PREPARED BY A NYS LICENSED LAND SURVEYOR SHOWING AND LOCATING ALL FEATURES OF THE WORK AS INSTALLED.
- 12. THE CONTRACTOR SHALL BE RESPONSIBLE FOR SUBMITTING TO THE ENGINEER A CERTIFIED RECORD SURVEY SIGNED AND SEALED BY A PROFESSIONAL LAND SURVEYOR REGISTERED IN THE STATE OF NEW YORK DEPICTING THE ACTUAL FIELD LOCATION OF ALL CONSTRUCTED IMPROVEMENTS THAT ARE REQUIRED BY THE JURISDICTIONAL AGENCIES FOR THE CERTIFICATION PROCESS. ALL SURVEY COSTS WILL BE THE CONTRACTORS RESPONSIBILITY.
- 13. THE CONTRACTOR SHALL BE RESPONSIBLE FOR DOCUMENTING AND MAINTAINING AS-BUILT INFORMATION WHICH SHALL BE RECORDED AS CONSTRUCTION PROGRESSES OR AT THE COMPLETION OF APPROPRIATE CONSTRUCTION INTERVALS AND SHALL BE RESPONSIBLE FOR PROVIDING AS-BUILT DRAWINGS TO THE OWNER FOR THE PURPOSE OF CERTIFICATION TO JURISDICTIONAL AGENCIES AS REQUIRED. ALL AS-BUILT DATA SHALL BE COLLECTED BY A STATE OF NEW YORK PROFESSIONAL LAND SURVEYOR WHOSE SERVICES ARE ENGAGED BY THE CONTRACTOR.
- 14. ANY WELL DISCOVERED DURING EARTH MOVING OR EXCAVATION SHALL BE REPORTED TO THE OWNER WITHIN 24 HOURS AFTER DISCOVERY IS MADE.
- 15. THE CONTRACTOR SHALL BE RESPONSIBLE FOR VERIFYING THAT THE PROPOSED IMPROVEMENTS SHOWN ON THE PLANS DO NOT CONFLICT WITH ANY KNOWN EXISTING OR OTHER PROPOSED IMPROVEMENTS. IF ANY CONFLICTS ARE DISCOVERED. THE CONTRACTOR SHALL NOTIFY THE OWNER PRIOR TO INSTALLATION OF ANY PORTION OF THE SITE WORK THAT WOULD BE AFFECTED. FAILURE TO NOTIFY OWNER OF AN IDENTIFIABLE CONFLICT PRIOR TO PROCEEDING WITH INSTALLATION RELIEVES OWNER OF ANY OBLIGATION TO PAY FOR A RELATED CHANGE ORDER.
- 16. ANY EXISTING UTILITY, WHICH IS TO BE EXTENDED, WHICH IS THE CONNECTION POINT FOR NEW UNDERGROUND UTILITIES, OR WHICH NEW FACILITIES CROSS. SHALL BE EXPOSED BY THE CONTRACTOR PRIOR TO PLACEMENT OF THE NEW UTILITIES. COST OF SUCH EXCAVATION AND SUBSEQUENT BACKFILL SHALL BE INCLUDED IN THE PRICES. PAID. FOR THE VARIOUS ITEMS OF WORK. THE ELEVATIONS AND LOCATIONS OF THE EXISTING FACILITIES WILL BE CHECKED BY THE PUBLIC WORKS INSPECTOR AND THE ENGINEER IF IN THE OPINION OF THE INSPECTOR A CONFLICT EXISTS. THEN THE ENGINEER SHALL MAK ANY NEEDED GRADE AND/ OR ALIGNMENT ADJUSTMENTS AND REVISE THE PLANS ACCORDINGLY. ALL GRAVITY FLOW PIPELINES TO BE LAID UPGRADE FROM THE LOWEST POINT STARTING AT THE END OF EXISTING IMPROVEMENTS. THE CONTRACTOR SHALL NOTIFY THE ENGINEER AT LEAST 24 HOURS PRIOR TO BACKFILLING OF ANY PIPE WHICH STUBS TO A FUTURE PHASE OF CONSTRUCTION FOR INVERT VERIFICATION. TOLERANCE SHALL BE IN ACCORDANCE WITH CITY STANDARD
- 17. WORK OF THIS CONTRACT IS TO INCLUDE, BUT NOT LIMITED TO, DEMOLITION OF EXISTING BUILDING FOUNDATIONS AND OLD UTILITY SYSTEMS, SITE IMPROVEMENTS INCLUDING, BUT NOT LIMITED TO, UTILITIES, UTILITY STRUCTURES, ASPHALT AND CONCRETE PAVEMENT. CONCRETE PAVERS. CONCRETE AND GRANITE CURBING, DRIVEWAY APRONS, CONCRETE AND ASPHALT RAMPS, SIDEWALKS. FENCING, RAILINGS, SIGNAGE, SITE LIGHTING, RETAINING WALLS AND MISCELLANEOUS
- 18. HOURS OF CONSTRUCTION ACTIVITY MUST COMPLY WITH THE TOWN OF ORANGETOWN CODE.

APPLICABLE TO THE PROJECT. ASSUMED PROVIDED BY OTHERS

- 19. PRIOR STARTING CONSTRUCTION ALL ACTIVE UTILITIES SHOULD BE IDENTIFIED, MARKED OUT IN THE FIELD, AND SECURED AS
- 16. CONTRACTOR IS ALSO TO FAMILIARIZE HIMSELF WITH THE SUBSURFACE EXPLORATIONS AND GEOTECHNICAL REPORTS
- 17. INFORMATION GIVEN IN THE SUBSURFACE EXPLORATIONS AND GEOTECHNICAL ENGINEERING REPORTS WAS OBTAINED FOR USE BY THE OWNER IN EXECUTION OF DESIGN. THE SUBSURFACE CONDITIONS DESCRIBED IN THE REPORTS ARE NOT INTENDED AS REPRESENTATIONS OR WARRANTIES OF ACCURACY. THE SUBSURFACE STRATIGRAPHY SHOWN IN THE REPORTS ARE BASED ON NECESSARY INTERPOLATIONS BETWEEN BORINGS AND MAY OR MAY NOT REPRESENT ACTUAL SUBSURFACE CONDITIONS. THE OWNER WILL NOT BE RESPONSIBLE FOR INTERPRETATIONS OR CONCLUSIONS MADE FROM THE DATA IN THE REPORTS BY THE CONTRACTOR.
- 18. CONDUCT A PRE-CONSTRUCTION CONFERENCE AT THE PROJECT SITE A MINIMUM OF SEVENTY-TWO (72) HOURS PRIOR TO COMMENCING ANY WORK OF THIS CONTRACT. THE MEETING WILL BE ARRANGED BY THE OWNER UPON NOTIFICATION OF THE CONTRACTOR AND IS TO BE ATTENDED BY REPRESENTATIVES OF THE CONTRACTOR, OWNER, CONSTRUCTION MANAGER, GEOTECHNICAL ENGINEER, SITE/CIVIL ENGINEER AND REPRESENTATIVES OF THE TOWN OF ORANGETOWN.
- 19. ADJOINING PROPERTY OWNERS WILL CONTINUE TO OCCUPY THEIR FACILITIES IMMEDIATELY ADJACENT TO THE PROJECT SITE AND DEMOLITION AREAS. THUS, THE CONTRACTOR MUST CONDUCT HIS OPERATIONS IN SUCH A MANNER AND MAKE ANY ARRANGEMENTS NECESSARY SO THAT THE ADJOINING PROPERTY OWNER'S USE OF THEIR FACILITIES WILL NOT BE DISRUPTED DURING THE COURSE OF THE WORK.
- 20. PROVIDE NOT LESS THAN SEVENTY-TWO (72) HOURS' NOTICE TO THE OWNER AND ADJACENT PROPERTY OWNERS OF ACTIVITIES THAT WILL AFFECT THEIR RESPECTIVE USE OF THEIR PROPERTY.
- 21. MAINTAIN ACCESS TO EXISTING WALKWAYS, EXITS, AND OTHER ADJACENT OCCUPIED OR USED FACILITIES.
- 22. DO NOT CLOSE OR OBSTRUCT WALKWAYS, EXITS, OR OTHER OCCUPIED OR USED FACILITIES WITHOUT WRITTEN PERMISSION FROM AUTHORITIES HAVING JURISDICTION OR THE AFFECTED PROPERTY OWNER.
- 23. IT IS NOT EXPECTED THAT HAZARDOUS MATERIALS WILL BE ENCOUNTERED IN THE CONDUCT OF THE WORK. HOWEVER, IF MATERIALS SUSPECTED OF CONTAINING HAZARDOUS MATERIALS ARE ENCOUNTERED. DO NOT DISTURB AND IMMEDIATELY NOTIFY THE OWNER AND CONSTRUCTION MANAGER. HAZARDOUS MATERIALS WILL BE REMOVED BY THE OWNER AND/OR CONTRACTOR UNDER A SEPARATE CONTRACT.
- 24. REVIEW PROJECT RECORD DOCUMENTS OF EXISTING CONSTRUCTION PROVIDED BY OWNER. OWNER DOES NOT GUARANTEE THAT EXISTING CONDITIONS ARE SAME AS THOSE INDICATED IN PROJECT RECORD DOCUMENTS.
- 25. THE CONTRACTOR IS RESPONSIBLE FOR ENGAGING A PROFESSIONAL ENGINEER TO PERFORM AN ENGINEERING SURVEY OF THE CONDITION OF ANY REMAINING BUILDING STRUCTURE OR FOUNDATION SYSTEM TO DETERMINE WHETHER REMOVING ANY ELEMENT MIGHT RESULT IN A STRUCTURAL DEFICIENCY OR UNPLANNED COLLAPSE OF ANY PORTION OF THAT STRUCTURE OR ADJACENT STRUCTURES DURING DEMOLITION OPERATIONS.
- 26. PROVIDE AND MAINTAIN INTERIOR AND EXTERIOR SHORING, BRACING, OR STRUCTURAL SUPPORT TO PRESERVE STABILITY AND PREVENT UNEXPECTED MOVEMENT OR COLLAPSE OF CONSTRUCTION BEING DEMOLISHED.
- 27. EXISTING UTILITIES: MAINTAIN ACTIVE UTILITY SERVICES INDICATED TO REMAIN AND PROTECT THEM AGAINST DAMAGE DURING DEMOLITION OPERATIONS.
- 28. DO NOT INTERRUPT EXISTING UTILITIES SERVING BOTH ON SITE AND OFF SITE ADJACENT OCCUPIED OR OPERATING
- FACILITIES UNLESS AUTHORIZED IN WRITING BY OWNER AND AUTHORITIES HAVING JURISDICTION.
- 29. PROVIDE TEMPORARY SERVICES DURING INTERRUPTIONS TO EXISTING UTILITIES, AS ACCEPTABLE TO OWNER AND TO AUTHORITIES HAVING JURISDICTION.
- 30. PROVIDE AT LEAST SEVENTY-TWO (72) HOURS' NOTICE TO OWNER IF SHUTDOWN OF SERVICE IS REQUIRED DURING
- 31. TEMPORARY PROTECTION: ERECT TEMPORARY PROTECTION, SUCH AS WALKS, FENCES, RAILINGS, CANOPIES, AND COVERED PASSAGEWAYS, WHERE REQUIRED BY AUTHORITIES HAVING JURISDICTION AND AS INDICATED.
- 32. PROTECT EXISTING SITE IMPROVEMENTS, APPURTENANCES, AND LANDSCAPING TO REMAIN.
- 33. PROVIDE TEMPORARY BARRICADES AND OTHER PROTECTION REQUIRED TO PREVENT INJURY TO PEOPLE AND DAMAGE TO ADJACENT BUILDINGS AND FACILITIES TO REMAIN.
- 34. PROVIDE PROTECTION TO ENSURE SAFE PASSAGE OF PEOPLE AROUND BUILDING DEMOLITION AREA AND TO AND FROM OCCUPIED PORTIONS OF ADJACENT BUILDINGS AND STRUCTURES.
- 35. PROTECT WALLS, WINDOWS, ROOFS, AND OTHER ADJACENT EXTERIOR CONSTRUCTION THAT ARE TO REMAIN AND THAT ARE EXPOSED TO BUILDING DEMOLITION OPERATIONS OR OTHER CONSTRUCTION ACTIVITY.
- 36. GENERAL: DEMOLISH ALL ITEMS, AS EITHER INDICATED ON THE PLANS OR ENCOUNTERED IN THE FIELD DURING THE WORK, COMPLETELY. USE METHODS REQUIRED TO COMPLETE THE WORK WITHIN LIMITATIONS OF GOVERNING REGULATIONS AND AS
- 37. DO NOT USE CUTTING TORCHES UNTIL WORK AREA IS CLEARED OF FLAMMABLE MATERIALS. MAINTAIN FIRE WATCH AND
- PORTABLE FIRE-SUPPRESSION DEVICES DURING FLAME-CUTTING OPERATIONS. 38. MAINTAIN ADEQUATE VENTILATION WHEN USING CUTTING TORCHES.
- 39. LOCATE DEMOLITION EQUIPMENT AND REMOVE DEBRIS AND OTHER MATERIALS SO AS NOT TO IMPOSE EXCESSIVE LOADS ON SUPPORTING WALLS, FLOORS, OR FRAMING OF ADJOINING STRUCTURES.
- 40. ENGINEERING SURVEYS: PERFORM SURVEYS AS THE WORK PROGRESSES TO DETECT HAZARDS THAT MAY RESULT FROM BUILDING DEMOLITION ACTIVITIES.
- 41. SITE ACCESS AND TEMPORARY CONTROLS: CONDUCT DEMOLITION AND DEBRIS-REMOVAL OPERATIONS TO ENSURE MINIMUM
- INTERFERENCE WITH ROADS, STREETS, WALKS, WALKWAYS, AND OTHER ADJACENT OCCUPIED AND USED FACILITIES. 42. DO NOT CLOSE OR OBSTRUCT STREETS, WALKS, WALKWAYS. OR OTHER ADJACENT OCCUPIED OR USED FACILITIES WITHOUT
- 43. USE WATER MIST AND OTHER SUITABLE METHODS TO LIMIT SPREAD OF DUST AND DIRT. COMPLY WITH GOVERNING ENVIRONMENTAL-PROTECTION REGULATIONS. DO NOT USE WATER WHEN IT MAY DAMAGE ADJACENT CONSTRUCTION OR CREATE HAZARDOUS OR OBJECTIONABLE CONDITIONS, SUCH AS ICE, FLOODING, AND POLLUTION.

PERMISSION FROM OWNER AND AUTHORITIES HAVING JURISDICTION. PROVIDE ALTERNATE ROUTES AROUND CLOSED OR

44. REMOVE STRUCTURES AND OTHER SITE IMPROVEMENTS INTACT WHEN PERMITTED BY AUTHORITIES HAVING JURISDICTION.

OBSTRUCTED TRAFFIC WAYS IF REQUIRED BY AUTHORITIES HAVING JURISDICTION.

- 45. CONCRETE: CUT CONCRETE FULL DEPTH AT JUNCTURES WITH CONSTRUCTION INDICATED TO REMAIN. USING POWER-DRIVEN SAW, THEN REMOVE CONCRETE BETWEEN SAW CUTS.
- 46. MASONRY: CUT MASONRY AT JUNCTURES WITH CONSTRUCTION INDICATED TO REMAIN, USING POWER-DRIVEN SAW, THEN
- 47. CONCRETE SLABS-ON-GRADE: SAW-CUT PERIMETER OF AREA TO BE DEMOLISHED AT JUNCTURES WITH CONSTRUCTION INDICATED TO REMAIN. THEN BREAK UP AND REMOVE.

- 48. EQUIPMENT: DISCONNECT EQUIPMENT AT NEAREST FITTING CONNECTION TO SERVICES, COMPLETE WITH SERVICE VALVES. REMOVE AS WHOLE UNITS. COMPLETE WITH CONTROLS.
- 49. BELOW-GRADE CONSTRUCTION: DEMOLISH EXISTING FOUNDATIONS AND FOOTINGS, FOUNDATION WALLS, WALLS, SLABS AND OTHER BELOW-GRADE CONSTRUCTION THAT IS WITHIN TEN (10) FEET OUTSIDE OF FOOTPRINT INDICATED FOR NEW CONSTRUCTION. ABANDON BELOW-GRADE CONSTRUCTION OUTSIDE THIS AREA.
- 50. REMOVE BELOW-GRADE CONSTRUCTION TO DEPTHS INDICATED ON THE PLANS.

POSSIBLE. SEPARATE RECYCLABLE MATERIALS BY TYPE.

INCHES IN DIAMETER, PER EARTHWORK SPECIFICATIONS.

- 51. EXISTING BELOW GRADE CONSTRUCTION SHOULD BE REMOVED ENTIRELY FROM BELOW PROPOSED FOUNDATIONS AND THEIR ZONES OF INFLUENCE (IF DETERMINED BY LINES EXTENDING AT LEAST ONE (1) FOOT LATERALLY BEYOND FOOTING EDGES FOR EACH VERTICAL FOOT OF DEPTH) AND EXCAVATED TO AT LEAST TWO (2) FEET BELOW PROPOSED CONSTRUCTION SUBGRADE LEVELS ELSEWHERE.
- 2. FOUNDATION AND SLABS MAY REMAIN IN PLACE BELOW THESE DEPTHS BELOW GROUND SUPPORTED SLABS, PAVEMENTS AND LANDSCAPED AREAS, PROVIDED THEY ARE APPROVED BY THE GEOTECHNICAL ENGINEER AND DO NOT INTERFERE WITH FUTURE CONSTRUCTION (INCLUDING UTILITIES); HOWEVER, IF EXISTING SLAB OR STRUCTURE TO REMAIN SHOULD BE
- THOROUGHLY BROKEN TO ALLOW VERTICAL DRAINAGE OF INFILTRATING WATER. 53. EXISTING UTILITIES: ABANDON EXISTING UTILITIES AND BELOW-GRADE UTILITY STRUCTURES. CUT UTILITIES FLUSH WITH
- 54. EXISTING UTILITIES: DEMOLISH EXISTING UTILITIES AND BELOW-GRADE UTILITY STRUCTURES THAT ARE WITHIN TEN (10) FEET
- OUTSIDE OF FOOTPRINT INDICATED FOR NEW CONSTRUCTION. ABANDON UTILITIES OUTSIDE THIS AREA. 55. FILL ABANDONED UTILITY STRUCTURES AND PIPING WITH EITHER LEAN CONCRETE OR SATISFACTORY SOIL MATERIALS APPROVED BY THE OWNER OR GEOTECHNICAL ENGINEER.
- 56. EXISTING UTILITIES: DEMOLISH AND REMOVE EXISTING UTILITIES AND BELOW-GRADE UTILITY STRUCTURES. 57. SITE DRAINAGE: SITE SOILS MAY SOFTEN WHEN EXPOSED TO WATER, EVERY EFFORT MUST BE MADE TO MAINTAIN DRAINAGE
- OF SURFACE WATER RUNOFF AWAY FROM CONSTRUCTION AREAS AND OPEN EXCAVATIONS BY GRADING AND LIMITING THE EXPOSURE OF EXCAVATIONS AND PREPARED SUBGRADES TO RAINFALL. 58. BELOW-GRADE AREAS: COMPLETELY FILL BELOW-GRADE AREAS AND VOIDS RESULTING FROM BUILDING DEMOLITION
- OPERATIONS WITH SATISFACTORY SOIL MATERIALS APPROVED BY THE OWNER AND/OR GEOTECHNICAL ENGINEER. 59. SITE GRADING: UNIFORMLY ROUGH GRADE AREA OF DEMOLISHED CONSTRUCTION TO A SMOOTH SURFACE, FREE FROM
- IRREGULAR SURFACE CHANGES. PROVIDE A SMOOTH TRANSITION BETWEEN ADJACENT EXISTING GRADES AND NEW GRADES. 60. SEPARATE RECYCLABLE DEMOLISHED MATERIALS FROM OTHER DEMOLISHED MATERIALS TO THE MAXIMUM EXTENT
- 61. PROVIDE CONTAINERS OR OTHER STORAGE METHOD APPROVED BY ARCHITECT FOR CONTROLLING RECYCLABLE MATERIALS UNTIL THEY ARE REMOVED FROM PROJECT SITE.
- 62. STOCKPILE PROCESSED MATERIALS ON-SITE WITHOUT INTERMIXING WITH OTHER MATERIALS. PLACE, GRADE, AND SHAPE STOCKPILES TO DRAIN SURFACE WATER COVER TO PREVENT WINDBLOWN DUST

63. STOCKPILE MATERIALS IN DESIGNATED AREAS SHOWN ON THE PLANS OR AS APPROVED IN THE FIELD BY THE OWNER OR

- 64. IF RECYCLABLE MATERIAL CANNOT BE USED ON-SITE, THE CONTRACTOR SHALL TRANSPORT THE RECYCLABLE MATERIALS
- OFF OWNER'S PROPERTY AND LEGALLY DISPOSE OF THEM AT NO ADDITIONAL COST TO THE OWNER IN ACCORDANCE WITH 65. DEMOLITION MATERIAL FREE OF ENVIRONMENTAL CONCERNS, AND APPROVED BY NYSDEC, MAY BE USED AS FILL MATERIAL
- PROVIDED THE MATERIAL IS PROPERLY SEGREGATED AND PROCESSED AS FOLLOWS AND APPROVED FOR REUSE ON THE SITE BY THE GEOTECHNICAL ENGINEER: CONCRETE MASONRY MATERIALS SHOULD BE CRUSHED TO A WELL GRADED BLEND WITH A MAXIMUM SIZE OF THREE (3)
- MILLED OR RECYCLED ASPHALT PAVEMENT (RAP) MAY BE REUSED AS GRANULAR BASE MATERIAL FOR PAVEMENTS, PROVIDED THAT THE RAP PARTICLE SIZE MEETS THE NEW YORK STATE DEPARTMENT OF TRANSPORTATION STANDARD SPECIFICATIONS FOR GRANULAR BASE AND NO MORE THAN FIFTY (50) PERCENT OF THE PAVEMENT GRANULAR BASE CONTAINS RAP.
- OTHER ASPHALTIC MATERIALS AND DELETERIOUS BUILDING MATERIALS SUCH AS WOOD, INSULATION, METAL, SHINGLES, ETC. SHOULD NOT BE USED AS GENERAL STRUCTURAL FILL MATERIAL.
- 66. EXCEPT FOR ITEMS OR MATERIALS INDICATED TO BE RECYCLED, REUSED, SALVAGED, REINSTALLED, OR OTHERWISE INDICATED TO REMAIN OWNER'S PROPERTY, REMOVE DEMOLISHED MATERIALS FROM PROJECT SITE AND LEGALLY DISPOSE OF THEM IN AN EPA-APPROVED LANDFILL
- 67. REMOVE AND TRANSPORT DEBRIS IN A MANNER THAT WILL PREVENT SPILLAGE ON ADJACENT SURFACES AND AREAS.
- 68. BURNING: ON SITE BURNING OF RUBBISH AND OTHER DEMOLITION DEBRIS WILL NOT BE PERMITTED. 69. DISPOSAL: TRANSPORT DEMOLISHED MATERIALS OFF OWNER'S PROPERTY AND PROVIDE FOR THE LEGAL OFF SITE DISPOSAL OF THE MATERIAL IN ACCORDANCE WITH THE SMP.
- 70. CLEAN ADJACENT STRUCTURES AND IMPROVEMENTS OF DUST, DIRT, AND DEBRIS CAUSED BY BUILDING DEMOLITION OPERATIONS. RETURN ADJACENT AREAS TO CONDITION EXISTING BEFORE BUILDING DEMOLITION OPERATIONS BEGAN.
- 71. THE CONTRACTOR SHALL BE RESPONSIBLE FOR PROVIDING THE OWNER WITH A SURVEY PREPARED BY A NYS LICENSED LAND SURVEYOR SHOWING THE LOCATION AND THE ELEVATIONS TO WHICH THE DEMARCATION BARRIER IS INSTALLED.
- 72. THE CONTRACTOR IS TO NOTE THAT THE WORK OF THIS CONTRACT WILL INCLUDE WORK BY OTHERS AND THE CONTRACTOR SHALL COORDINATE HIS WORK AND MAKE EVERY REASONABLE EFFORT TO PERMIT THE EXECUTION OF SUCH WORK BY
- 73. IF TEMPORARY UTILITY SERVICES ARE REQUIRED, THE CONTRACTOR SHALL SEE TO IT THAT THEY ARE PROVIDED AT NO ADDITIONAL COST TO THE OWNER AND IT SHALL BE THE CONTRACTOR'S RESPONSIBILITY TO MAINTAIN SUCH TEMPORARY
- 74. ALL WORK OF THIS CONTRACT SHALL CONFORM TO THESE CONTRACT DRAWINGS AND SPECIFICATIONS AS WELL AS TO THE APPLICABLE REQUIREMENTS OF THE TOWN OF ORANGETOWN BUILDING, PUBLIC WORKS, AND FIRE DEPARTMENTS, AS WELL
- 75. ALL WORK SHALL COMPLY WITH THE BUILDING CODE OF NEW YORK STATE AND ALL OTHER APPLICABLE FEDERAL, STATE, AND LOCAL RULES, LAWS, AND REGULATIONS.
- 6. ALL PROJECT RELATED LINES AND GRADES ARE TO BE ESTABLISHED BY A LICENSED SURVEYOR REGISTERED TO PRACTICE IN THE STATE OF NEW YORK

77. SIZES OF EXISTING UTILITY LINES ARE TO BE VERIFIED IN THE FIELD BY CAREFUL TEST EXCAVATIONS BY THE CONTRACTOR

PRIOR TO STARTING THE WORK ANY SUBSTANTIVE VARIATIONS FROM THE SURVEY DATA PROVIDED ARE TO BE BROUGHT TO THE ATTENTION OF THE ARCHITECT OR ENGINEER SO THAT APPROPRIATE DESIGN MODIFICATIONS MAY BE MADE. 78. THE CONTRACTOR SHALL TAKE CARE NOT TO DAMAGE EXISTING DRAINAGE OR UTILITY SYSTEMS WITHIN OR ADJACENT TO THE WORK SHOWN ON THESE DRAWINGS. ANY DAMAGE CAUSED BY THE CONTRACTOR'S OPERATIONS SHALL IMMEDIATELY

BE REPAIRED BY THE CONTRACTOR AT NO ADDITIONAL EXPENSE AND TO THE SATISFACTION OF THE OWNER OR UTILITY

- COMPANY INVOLVED. 79. THE CONTRACTOR SHALL BE RESPONSIBLE FOR THE COORDINATION OF ALL TRADES REQUIRED BY THE CONTRACT WORK AND SHALL OBTAIN BONDS, PERMITS, ETC. REQUIRED FOR THE EXECUTION OF THE WORK AND CONFORM THE WORK WITH ALL APPLICABLE CODES, RULES AND REGULATIONS OF THE GOVERNING AGENCIES. THE CONTRACTOR IN ACCORDANCE WITH NEW YORK STATE LAW (CODE RULE 53) SHALL BE RESPONSIBLE FOR NOTIFYING THE APPROPRIATE UTILITY COMPANY OR AGENCY PRIOR TO COMMENCING ANY EXCAVATION WORK AND SHALL NOTIFY THE "CALL BEFORE YOU DIG" HOTLINE @
- 80. SAFE AND ADEQUATE PEDESTRIAN AND VEHICULAR TRAFFIC FLOW SHALL BE MAINTAINED AT ALL TIMES TO THE ADJACENT BUILDINGS WHILE THE WORK IS PROGRESSING. THE CONTRACTOR SHALL SUBMIT FOR APPROVAL OF THE OWNER A CONSTRUCTION SEQUENCE SCHEDULE AND PLAN FOR PEDESTRIAN AND VEHICULAR TRAFFIC FLOW.
- 81. THE TREE PROTECTION AND PRESERVATION GUIDELINES ADOPTED PURSUANT TO SECTION 21-24 OF THE LAND DEVELOPMENT REGULATIONS OF THE TOWN OF ORANGETOWN WILL BE IMPLEMENTED IN ORDER TO PROTECT AND PRESERVE BOTH INDIVIDUAL SPECIMEN TREES AND BUFFER AREA WITH MANY TREES. STEPS THAT WILL BE TAKEN TO PRESERVE AND PROTECT EXISTING TREES TO REMAIN ARE AS FOLLOWS:
- 81.1. NO CONSTRUCTION EQUIPMENT SHALL BE PARKED UNDER THE TREE CANOPY.

1-800-962-7962 PRIOR TO COMMENCING ANY CONSTRUCTION ACTIVITIES.

- 81.2. THERE WILL BE NO EXCAVATION OR STOCKPILING OF EARTH UNDERNEATH THE TREES.
- 81.3. TREES DESIGNATED TO BE PRESERVED SHALL BE MARKED CONSPICUOUSLY ON ALL SIDES AT A 5 TO 10-FOOT HEIGHT. THE TREE PROTECTION ZONE FOR TREES DESIGNATED TO BE PRESERVED WILL BE ESTABLISHED BY ONE OF THE
- 81.4.1. ONE (1) FOOT RADIUS FROM PER INCH DBH.
- DRIP LINE OF THE TREE CANOPY: THE METHOD CHOSEN SHOULD BE BASED ON PROVIDING THE MAXIMUM PROTECTION ZONE POSSIBLE. A BARRIER OF SNOW FENCE OR EQUAL IS TO BE PLACED AND MAINTAINED ONE (1 YARD BEYOND THE ESTABLISHED TREE PROTECTION ZONE. IF IT IS AGREED THAT THE TREE PROTECTION ZONE OF A SELECTED TREE MUST BE VIOLATED, ONE OF THE FOLLOWING METHODS MUST BE EMPLOYED TO MITIGATE THE
- LIGHT TO HEAVY IMPACTS: MINIMUM OF EIGHT (8) INCHES OF WOOD CHIPS INSTALLED IN THE AREA TO BE PROTECTED. CHIPS SHALL BE REMOVED UPON COMPLETION OF WORK.
- LIGHT IMPACTS ONLY: INSTALLATION OF ¾ INCH OF PLYWOOD OR BOARDS, OR EQUAL OVER THE AREA TO BE
- THE BUILDER OR ITS AGENT MAY NOT CHANGE THE GRADE WITHIN THE TREE PROTECTION ZONE OF A PRESERVED TREE UNLESS SUCH GRADE CHANGE HAS RECEIVED FINAL APPROVAL FROM THE TOWN OF ORANGETOWN PLANNING BOARD. IF THE GRADE LEVEL IS TO BE CHANGED MORE THAN SIX (6) INCHES, TREES DESIGNATED TO BE PRESERVED SHALL BE WELLED AND/OR PRESERVED IN A RAISED BED, WITH THE TREE WELL A RADIUS OF THREE (3) FEET LARGER THAN THE TREE CANOPY.
- 82. ALL UNPAVED AREAS WITHIN THE WORK AREAS AND ALL AREAS DISTURBED DURING CONSTRUCTION ARE TO BE STABILIZED IN ACCORDANCE WITH THE NYSDEC APPROVED STORMWATER POLLUTION PREVENTION PLAN. UNLESS OTHERWISE DIRECTED BY THE OWNER, TURFED AREAS, DISTURBED BY REGRADING AND OTHER WORK OF CONTRACTOR, SHALL BE BROUGHT TO THE PROPER SUBGRADE ELEVATION, TOPSOIL TO A MINIMUM DEPTH OF 4 INCHES SHALL BE PLACED AND, LIMING, FERTILIZING AND SEEDING ACCOMPLISHED, AS SPECIFIED. THE CONTRACTOR SHALL WATER AND MAINTAIN THE SEEDED AREAS UNTIL THEY HAVE BECOME WELL ESTABLISHED.
- 83. EXISTING PAVEMENT WHICH IS TO REMAIN AND WHICH IS TO BE REMOVED OR DAMAGED DURING THE CONSTRUCTION WORK OF THIS CONTRACT IS TO BE RESTORED TO ITS ORIGINAL CONDITION.
- 84. UNLESS OTHERWISE SHOWN HEREON OR DIRECTED BY THE ENGINEER. THE CONTRACTOR SHALL MATCH THE MATERIALS. TYPES, THICKNESS AND QUALITY OF EXISTING BITUMINOUS CONCRETE PAVEMENTS, WALKWAYS AND CURBS WITHIN THE PUBLIC RIGHT-OF-WAY WHICH ARE TO BE REPLACED.
- 85. AS A REFERENCE STANDARD, ALL WORK CONTAINED HEREIN SHALL BE GOVERNED BY THE REQUIREMENTS SET FORTH IN THE "STANDARD SPECIFICATIONS, CONSTRUCTION AND MATERIALS" AS PUBLISHED BY THE NYSDOT, DESIGN AND CONSTRUCTION DIVISION, DATED JANUARY 2, 2002, INCLUDING ALL LATEST AMENDMENTS THERETO.
- 86. AT NO TIME SHALL ANY EXCAVATED AREAS BE LEFT UNATTENDED UNLESS APPROPRIATE MARKING AND BARRICADING IS
- 87. WITH REGARD TO EXISTING UTILITIES TO REMAIN. THE CONTRACTOR SHALL BE RESPONSIBLE FOR ADJUSTING ALL EXISTING UTILITY VALVES, MANHOLE FRAMES, COVERS, RIMS, INVERTS AND HYDRANTS TO MEET NEW FINISHED GRADE OR AS OTHERWISE REQUIRED TO FUNCTION PROPERLY.
- 88. CONTRACTOR SHALL REVIEW PLANS FROM SITE PREPARATION AND SITE PACKAGE CONTRACT AND FAMILIARIZE THEMSELVES WITH PREVIOUS SCOPE OF WORK.
- 89. CONTRACTOR SHALL LIMIT ACTIVITIES IN AREAS OF DEVELOPMENT THAT ARE OCCUPIED 90. THE GENERATORS WILL ONLY BE TESTED FROM 9:00 A.M. TO 5:00 P.M. MONDAY THROUGH FRIDAY. ONLY ONE GENERATOR MILL BE TESTED AT A TIME. THE TESTING SCHEDULE SHALL BE PROVIDED TO THE TOWN OF ORANGETOWN OFFICE OF BUILDING, ZONING, PLANNING, ADMINISTRATION AND ENFORCEMENT.

## PAVING, GRADING AND DRAINAGE NOTES

- 1. CONTRACTOR SHALL MAINTAIN GRADES AT ENTRANCES TO PHASE 2 CONSTRUCTION.
- 2. ALL PAVING. CONSTRUCTION. MATERIALS. AND WORKMANSHIP WITHIN JURISDICTION'S RIGHT-OF-WAY SHALL BE IN ACCORDANCE WITH LOCAL OR COUNTY SPECIFICATIONS AND STANDARDS (LATEST EDITION) OR NEW YORK STATE DEPARTMENT OF TRANSPORTATION SPECIFICATIONS AND STANDARDS (LATEST EDITION) IF NOT COVERED BY LOCAL OR
- 3. ALL UNPAVED AREAS IN EXISTING RIGHTS-OF-WAY DISTURBED BY CONSTRUCTION SHALL BE REGRADED AND REPAIRED TO EXISTING CONDITION OR BETTER
- 4. TRAFFIC CONTROL ON ALL NYSDOT, LOCAL AND COUNTY RIGHTS-OF-WAY SHALL MEET THE REQUIREMENTS OF THE MANUAL OF UNIFORM TRAFFIC CONTROL DEVICES (U.S. DOT/FHA) AND THE REQUIREMENTS OF THE STATE AND ANY LOCAL AGENCY HAVING JURISDICTION. IN THE EVENT THAT THE CONTRACT DOCUMENTS AND THE JURISDICTIONAL AGENCY REQUIREMENTS ARE NOT IN AGREEMENT. THE MOST STRINGENT SHALL GOVERN
- 5. THE CONTRACTOR SHALL GRADE THE SITE TO THE ELEVATIONS INDICATED AND SHALL REGRADE WASHOUTS WHERE THEY OCCUR AFTER EVERY RAINFALL UNTIL AN ADEQUATE STABILIZATION OCCURS.
- 6. ALL OPEN AREAS WITHIN THE PROJECT SITE SHALL BE COVERED WITH TOPSOIL AND SEED AS INDICATED ON THE LANDSCAPE
- 7. ALL AREAS INDICATED AS PAVEMENT SHALL BE CONSTRUCTED IN ACCORDANCE WITH THE TYPICAL PAVEMENT SECTIONS AS 8. WHERE EXISTING PAVEMENT IS INDICATED TO BE REMOVED AND REPLACED, THE CONTRACTOR SHALL SAW CUT A MINIMUM 2"
- DEEP FOR A SMOOTH AND STRAIGHT JOINT AND REPLACE THE PAVEMENT WITH THE SAME TYPE AND DEPTH OF MATERIAL AS EXISTING OR AS INDICATED. . WHERE NEW PAVEMENT MEETS THE EXISTING PAVEMENT, THE CONTRACTOR SHALL SAW CUT THE EXISTING PAVEMENT A
- MINIMUM 2" DEEP FOR A SMOOTH AND STRAIGHT JOINT AND MATCH THE EXISTING PAVEMENT ELEVATION WITH THE PROPOSED PAVEMENT UNLESS OTHERWISE INDICATED. 10. THE CONTRACTOR SHALL INSTALL FILTER FABRIC OVER ALL DRAINAGE STRUCTURES FOR THE DURATION OF CONSTRUCTION AND UNTIL ACCEPTANCE OF THE PROJECT BY THE OWNER. ALL DRAINAGE STRUCTURES SHALL BE CLEANED OF DEBRIS AS
- 11. DEWATERING DISCHARGE WILL NOT BE PERMITTED TO DISCHARGE ONTO OPEN GROUND. IT SHALL BE TREATED AND DISCHARGED INTO THE COUNTY SEWER. PERMIT TO BE COORDINATED BY THE OWNER.
- 12. STRIP TOPSOIL AND ORGANIC MATTER FROM ALL AREAS OF THE SITE AS REQUIRED. IN SOME CASES TOPSOIL MAY BE STOCKPILED ON SITE FOR PLACEMENT WITHIN LANDSCAPED AREAS BUT ONLY AS DIRECTED BY THE OWNER. 13. FIELD DENSITY TESTS SHALL BE TAKEN AT INTERVALS IN ACCORDANCE WITH THE TOWN OF ORANGETOWN.

REQUIRED DURING AND AT THE END OF CONSTRUCTION TO PROVIDE POSITIVE DRAINAGE FLOWS.

WHICH VIOLATES THE WATER QUALITY STANDARDS OF THE GOVERNING CODE.

- 14. ALL SLOPES AND AREAS DISTURBED BY CONSTRUCTION SHALL BE GRADED AS PER PLANS. THE AREAS SHALL THEN BE STABILIZED BY MEANS AND METHODS APPROVED BY THE TOWN OF ORANGETOWN. ANY AREAS DISTURBED FOR ANY REASON PRIOR TO FINAL ACCEPTANCE OF THE JOB SHALL BE CORRECTED BY THE CONTRACTOR AT NO ADDITIONAL COST TO THE
- OWNER. ALL EARTHEN AREAS WILL BE COVERED WITH ROCK OR MULCHED AS SHOWN ON THE LANDSCAPING PLAN. 15. ALL CUT OR FILL SLOPES SHALL BE 3 (HORIZONTAL): 1 (VERTICAL) OR FLATTER UNLESS OTHERWISE SHOWN. 16. THE CONTRACTOR SHALL BE RESPONSIBLE FOR THE CONTROL OF DUST AND DIRT RISING AND SCATTERING IN THE AIR
- CONTRACTOR SHALL COMPLY WITH ALL GOVERNING REGULATIONS PERTAINING TO ENVIRONMENTAL PROTECTION. 17. THE CONTRACTOR SHALL TAKE ALL REQUIRED MEASURES TO CONTROL TURBIDITY, INCLUDING BUT NOT LIMITED TO THE INSTALLATION OF TURBIDITY BARRIERS AT ALL LOCATIONS WHERE THE POSSIBILITY OF TRANSFERRING SUSPENDED SOLIDS INTO THE RECEIVING WATER BODY EXISTS DUE TO THE PROPOSED WORK. TURBIDITY BARRIERS MUST BE MAINTAINED IN EFFECTIVE CONDITION AT ALL LOCATIONS UNTIL CONSTRUCTION IS COMPLETED AND DISTURBED SOIL AREAS ARE STABILIZED. THEREAFTER, THE CONTRACTOR MUST REMOVE THE BARRIERS. AT NO TIME SHALL THERE BE ANY OFF-SITE DISCHARGE

DURING CONSTRUCTION AND SHALL PROVIDE WATER SPRINKLING OR OTHER SUITABLE METHODS OF CONTROL. THE

- 18. EXPOSED SLOPES SHOULD BE STABILIZED WITHIN 48 HOURS OF COMPLETING FINAL GRADING, AND AT ANY OTHER TIME AS NECESSARY, TO PREVENT EROSION, SEDIMENTATION OR TURBID DISCHARGES.
- 19. THE CONTRACTOR MUST REVIEW AND MAINTAIN A COPY OF THE REQUIRED PERMITS COMPLETE WITH ALL CONDITIONS, ATTACHMENTS. EXHIBITS. AND PERMIT MODIFICATIONS IN GOOD CONDITION AT THE CONSTRUCTION SITE. THE COMPLETE PERMIT MUST BE AVAILABLE FOR REVIEW UPON REQUEST BY GOVERNING JURISDICTIONS.
- 20. THE CONTRACTOR SHALL ENSURE THAT ISLAND PLANTING AREAS AND OTHER PLANTING AREAS ARE NOT COMPACTED AND DO NOT CONTAIN ROAD BASE MATERIALS. THE CONTRACTOR SHALL ALSO EXCAVATE AND REMOVE ALL UNDESIRABLE MATERIAL FROM ALL AREAS ON THE SITE TO BE PLANTED AND PROPERLY DISPOSED OF IN A LEGAL MANNER.
- 21. THE CONTRACTOR SHALL INSTALL ALL UNDERGROUND STORM WATER PIPING PER MANUFACTURER'S RECOMMENDATIONS.
- **BUILDING AND SAFETY DIVISION NOTES** FILL TO BE COMPACTED TO NOT LESS THAN 90% OF MAXIMUM DENSITY AS DETERMINED BY A.S.T.M. SOIL COMPACTION TEST
- 2. FIELD DENSITY WILL BE DETERMINED BY THE SAND-CONE METHOD A.S.T.M. 1556-07 AND/OR NUCLEAR DENSITY GAUGE METHOD A.S.T.M. 2922/3017. IN FINE GRAINED, COHESIVE SOILS, FIELD DENSITY MAY BE DETERMINED BY THE DRIVE-CYLINDER METHOD D2937 A.S.T.M. PROVIDED NOT LESS THAN 20% OF THE REQUIRED DENSITY TESTS, UNIFORMLY DISTRIBUTED, ARE BY THE SAND-CONE METHOD. THE METHOD OF DETERMINING FIELD DENSITY SHALL BE SHOWN IN THE COMPACTION REPORT. OTHER METHODS MAY BE USED IF RECOMMENDED BY THE SOILS ENGINEER AND APPROVED IN ADVANCE BY THE BUILDING OFFICIAL.
- NOT LESS THAN ONE FIELD DENSITY TEST WILL BE MADE FOR EACH TWO-FOOT VERTICAL LIFT OF FILL NOR LESS THAN ONE SUCH TEST FOR EACH 1,000 CUBIC YARDS OF MATERIAL PLACED UNLESS OTHERWISE RECOMMENDED BY THE SOILS
- . NO FILL TO BE PLACED UNTIL STRIPPING OF VEGETATION, REMOVAL OF UNSUITABLE SOILS AND INSTALLATION OF SUBDRAINS (IF ANY) HAS BEEN INSPECTED AND APPROVED BY THE SOILS ENGINEER. NO ROCK OR SIMILAR MATERIAL GREATER THAN 8" IN DIAMETER WILL BE PLACED IN THE FILL UNLESS RECOMMENDATIONS FOR
- SUCH PLACEMENT HAVE BEEN SUBMITTED BY THE SOILS ENGINEER IN ADVANCE AND APPROVED BY THE BUILDING OFFICIAL. 6. FINISH GRADING WILL BE COMPLETED AND APPROVED BEFORE OCCUPANCY OF BUILDINGS.
- 7. SEE GRADING PLANS FOR EARTHWORK VOLUMES.

STRUCTURES UPON COMPLETION.

18. SANITARY FACILITIES SHALL BE MAINTAINED ON THE SITE.

- 8. FILL SLOPES SHALL NOT BE STEEPER THAN 2:1. 9. DENSITY TESTS WILL BE MADE AT POINTS APPROXIMATELY ONE FOOT BELOW THE FILL SLOPE SURFACE. ONE TEST WILL BE MADE FOR EACH 1,000 SQ. FT. OF SLOPE SURFACE, BUT NOT LESS THAN ONE TEST FOR EACH 10 FT. VERTICAL OF SLOPE
- HEIGHT UNLESS OTHERWISE RECOMMENDED BY THE SOILS ENGINEER. 10. ALL PADS AT ROUGH GRADING WILL HAVE A MINIMUM SLOPE OF 1% TOWARDS THE STREET OR DESIGNED DRAINAGE OUTLET.
- 11. APPROVAL OF THIS PLAN BY THE TOWN OF ORANGETOWN BUILDING, ZONING, PLANNING, ADMINISTRATION AND ENFORCEMENT DOES NOT CONSTITUTE A REPRESENTATION AS TO THE ACCURACY OF THE LOCATION OR THE EXISTENCE OR NON-EXISTENCE OF ANY UNDERGROUND UTILITY PIPE OR STRUCTURE WITHIN THE LIMITS OF THIS PROJECT. THE CONTRACTOR SHALL ASSUME FULL RESPONSIBILITY FOR THE PROTECTION OF ALL UTILITIES WITHIN THE LIMITS OF THIS PROJECT.
- 12. FILLS SHALL BE BENCHED IN ACCORDANCE WITH APPROVED GEOTECHNICAL REPORT.

COMPLIANCE WITH THE PLANS, SPECIFICATIONS, AND CODE WITHIN THIS PURVIEW.

- 13. ALL TRENCH BACKFILLS SHALL BE TESTED AND CERTIFIED BY THE SITE SOILS ENGINEER PER THE GRADING CODE.
- 14. ALL CUT SLOPES SHALL BE INVESTIGATED BOTH DURING AND AFTER GRADING BY AN ENGINEERING GEOLOGIST TO DETERMINE IF ANY SLOPE STABILITY PROBLEM EXISTS. SHOULD EXCAVATION DISCLOSE ANY GEOLOGICAL HAZARDS OR POTENTIAL GEOLOGICAL HAZARDS, THE ENGINEERING GEOLOGIST SHALL RECOMMEND NECESSARY TREATMENT TO THE BUILDING
- i. Where support or buttressing of cut and natural slopes is determined to be necessary by the engineering GEOLOGIST AND SOILS ENGINEER, THE SOILS ENGINEER WILL SUBMIT DESIGN, LOCATION AND CALCULATIONS TO THE BUILDING OFFICIAL PRIOR TO CONSTRUCTION. THE ENGINEERING GEOLOGIST AND SOILS ENGINEER WILL INSPECT AND CONTROL THE CONSTRUCTION OF THE BUTTRESSING AND CERTIFY TO THE STABILITY OF THE SLOPE AND ADJACENT
- 16. THE SOILS ENGINEER AND ENGINEERING GEOLOGIST SHALL PERFORM SUFFICIENT INSPECTIONS AND BE AVAILABLE DURING GRADING AND CONSTRUCTION TO PROVIDE CONSULTATION CONCERNING COMPLIANCE WITH THE PLANS, SPECIFICATIONS,
- AND CODE WITHIN THEIR PURVIEW. 17. THE DESIGN CIVIL ENGINEER SHALL BE AVAILABLE DURING GRADING AND CONSTRUCTION FOR CONSULTATION CONCERNING

ALL MEASURES STATED ON THE EROSION AND SEDIMENT CONTROL PLAN, AND IN THE STORM WATER POLLUTION PREVENTION PLAN, SHALL BE MAINTAINED IN FULLY FUNCTIONAL CONDITION UNTIL NO LONGER REQUIRED FOR A COMPLETED PHASE OF WORK OR FINAL STABILIZATION OF THE SITE. ALL EROSION AND SEDIMENTATION CONTROL MEASURES MAY BE CHECKED BY A QUALIFIED.

- DETERIORATION.
- 2. ALL SEEDED AREAS SHALL BE CHECKED REGULARLY TO SEE THAT A GOOD STAND IS MAINTAINED. AREAS SHOULD BE FERTILIZED. WATERED AND RESEEDED AS NEEDED.
- ONTO PUBLIC RIGHTS-OF-WAY. THIS MAY REQUIRE PERIODIC TOP DRESSING OF THE CONSTRUCTION ENTRANCES AS
- 6. OUTLET STRUCTURES IN THE SEDIMENTATION BASINS SHALL BE MAINTAINED IN OPERATIONAL CONDITIONS AT ALL TIMES.

### 7. ALL MAINTENANCE OPERATIONS SHALL BE DONE IN A TIMELY MANNER.

- THE CONTRACTOR SHALL CONSTRUCT GRAVITY SEWER LATERALS, CLEANOUTS, GRAVITY SEWER LINES, AND DOMESTIC WATER AND FIRE PROTECTION SYSTEM AS SHOWN ON THESE PLANS. THE CONTRACTOR SHALL FURNISH ALL NECESSARY MATERIALS, EQUIPMENT, MACHINERY, TOOLS, MEANS OF TRANSPORTATION AND LABOR NECESSARY TO COMPLETE THE WORK IN FULL AND COMPLETE ACCORDANCE WITH THE SHOWN, DESCRIBED AND REASONABLY INTENDED REQUIREMENTS OF THE CONTRACT DOCUMENTS AND JURISDICTIONAL AGENCY REQUIREMENTS. IN THE EVENT THAT THE CONTRACT DOCUMENTS AND
- 2. ALL EXISTING UNDERGROUND UTILITY LOCATIONS SHOWN ARE APPROXIMATE. THE CONTRACTOR SHALL COMPLY WITH ALL REQUIREMENTS FOR UTILITY LOCATION AND COORDINATION IN ACCORDANCE WITH THE NOTES CONTAINED IN THE GENERAL

THE JURISDICTIONAL AGENCY REQUIREMENTS ARE NOT IN AGREEMENT, THE MOST STRINGENT SHALL GOVERN.

- 7. ALL UTILITY AND STORM DRAIN TRENCHES LOCATED UNDER AREAS TO RECEIVE PAVING SHALL BE COMPLETELY BACK FILLED IN ACCORDANCE WITH THE GOVERNING JURISDICTIONAL AGENCY'S SPECIFICATIONS. IN THE EVENT THAT THE CONTRACT
- 8. CONTRACTOR SHALL PERFORM, AT HIS OWN EXPENSE, ANY AND ALL TESTS REQUIRED BY THE SPECIFICATIONS AND/OR ANY AGENCY HAVING JURISDICTION. THESE TESTS MAY INCLUDE, BUT MAY NOT BE LIMITED TO, INFILTRATION AND EXFILTRATION, TELEVISION INSPECTION AND A MANDREL TEST ON GRAVITY SEWER. A COPY OF THE TEST RESULTS SHALL BE PROVIDED TO THE UTILITY PROVIDER, OWNER AND JURISDICTIONAL AGENCY AS REQUIRED.
- WHERE LOCAL JURISDICTIONS REQUIRE RECORD DRAWINGS, THE CONTRACTOR SHALL PROVIDE TO THE ENGINEER AND OWNER COPIES OF A PAVING. GRADING AND DRAINAGE RECORD DRAWING AND A SEPARATE UTILITY RECORD DRAWING. BOTH PREPARED BY A NEW YORK REGISTERED SURVEYOR. THE RECORD DRAWINGS SHALL VERIFY ALL DESIGN INFORMATION INCLUDED ON THE DESIGN PLANS OF THE SAME NAME.
- CONTRACTOR SHALL PROVIDE THE NECESSARY ITEMS INCLUDING ANY TESTING, REPORTS, OR CERTIFICATION DOCUMENTS HE GOVERNING JURISDICTIONS TO PROPERLY CLOSEOUT THE PROJECT BEFORE IT CAN BE DEEMED

### COMPLETE.

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2. Contractor shall not rely solely on electronic versions of plans, specifications, and data files that are

THEIR ACTUAL DIMENSIONS OR LOCATIONS ON THE DRAWINGS. THE CONTRACTOR SHALL REFER TO THE DETAIL SHEET DIMENSIONS, NYSDOT STANDARD SHEETS, MANUFACTURERS' LITERATURE, SHOP DRAWINGS AND FIELD MEASUREMENTS OF

PERSON ON A SCHEDULE THAT MEETS OR EXCEEDS THE GOVERNING REQUIREMENTS, AND CLEANED AND REPAIRED IN

ACCORDANCE WITH THE FOLLOWING:

1. INLET PROTECTION DEVICES AND BARRIERS SHALL BE REPAIRED OR REPLACED IF THEY SHOW SIGNS OF UNDERMINING, OR

SILT FENCES SHALL BE REPAIRED TO THEIR ORIGINAL CONDITIONS IF DAMAGED. SEDIMENT SHALL BE REMOVED FROM THE SILT FENCES WHEN IT REACHES ONE-HALF THE HEIGHT OF THE SILT FENCE. 4. THE CONSTRUCTION ENTRANCES SHALL BE MAINTAINED IN A CONDITION WHICH WILL PREVENT TRACKING OR FLOW OF MUD.

5. THE TEMPORARY PARKING AND STORAGE AREA SHALL BE KEPT IN GOOD CONDITION (SUITABLE FOR PARKING AND STORAGE). THIS MAY REQUIRE PERIODIC TOP DRESSING OF THE TEMPORARY PARKING AS CONDITIONS DEMAND.

SEDIMENT SHALL BE REMOVED FROM SEDIMENT BASINS OR TRAPS WHEN THE DESIGN CAPACITY HAS BEEN REDUCED BY 55 CUBIC YARDS / ACRE.

## WATER AND SEWER UTILITY NOTES

- 3. THE CONTRACTOR SHALL RESTORE ALL DISTURBED VEGETATION IN KIND, UNLESS SHOWN OTHERWISE.

INTO THE TRENCH. VALVES SHALL BE PLUMB AND LOCATED ACCORDING TO THE PLANS.

4. DEFLECTION OF PIPE JOINTS AND CURVATURE OF PIPE SHALL NOT EXCEED THE MANUFACTURER'S SPECIFICATIONS. SECURELY CLOSE ALL OPEN ENDS OF PIPE AND FITTINGS WITH A WATERTIGHT PLUG WHEN WORK IS NOT IN PROGRESS. THE INTERIOR OF ALL PIPES SHALL BE CLEAN AND JOINT SURFACES WIPED CLEAN AND DRY AFTER THE PIPE HAS BEEN LOWERED

CONSTRUCTION SECTION OF THIS SHEET. THE CONTRACTOR SHALL ALSO SCOPE THE SEWER LINES ON SITE AND RECORD A

- 5. ALL PHASES OF INSTALLATION, INCLUDING UNLOADING, TRENCHING, LAYING AND BACK FILLING, SHALL BE DONE IN A FIRST CLASS WORKMANLIKE MANNER. ALL PIPE AND FITTINGS SHALL BE CAREFULLY STORED FOLLOWING MANUFACTURER'S RECOMMENDATIONS. CARE SHALL BE TAKEN TO AVOID DAMAGE TO THE COATING OR LINING IN ANY D.I. PIPE FITTINGS. ANY PIPE OR FITTING WHICH IS DAMAGED OR WHICH HAS FLAWS OR IMPERFECTIONS WHICH, IN THE OPINION OF THE ENGINEER OR OWNER. RENDERS IT UNFIT FOR USE. SHALL NOT BE USED. ANY PIPE NOT SATISFACTORY FOR USE SHALL BE CLEARLY MARKED AND IMMEDIATELY REMOVED FROM THE JOB SITE, AND SHALL BE REPLACED AT THE CONTRACTOR'S EXPENSE.
- 6. WATER FOR FIRE FIGHTING SHALL BE AVAILABLE FOR USE PRIOR TO COMBUSTIBLES BEING BROUGHT ON SITE.
- DOCUMENTS AND THE JURISDICTIONAL AGENCY REQUIREMENTS ARE NOT IN AGREEMENT, THE MOST STRINGENT SHALL
- RECORD DRAWINGS
- PROJECT CLOSEOUT

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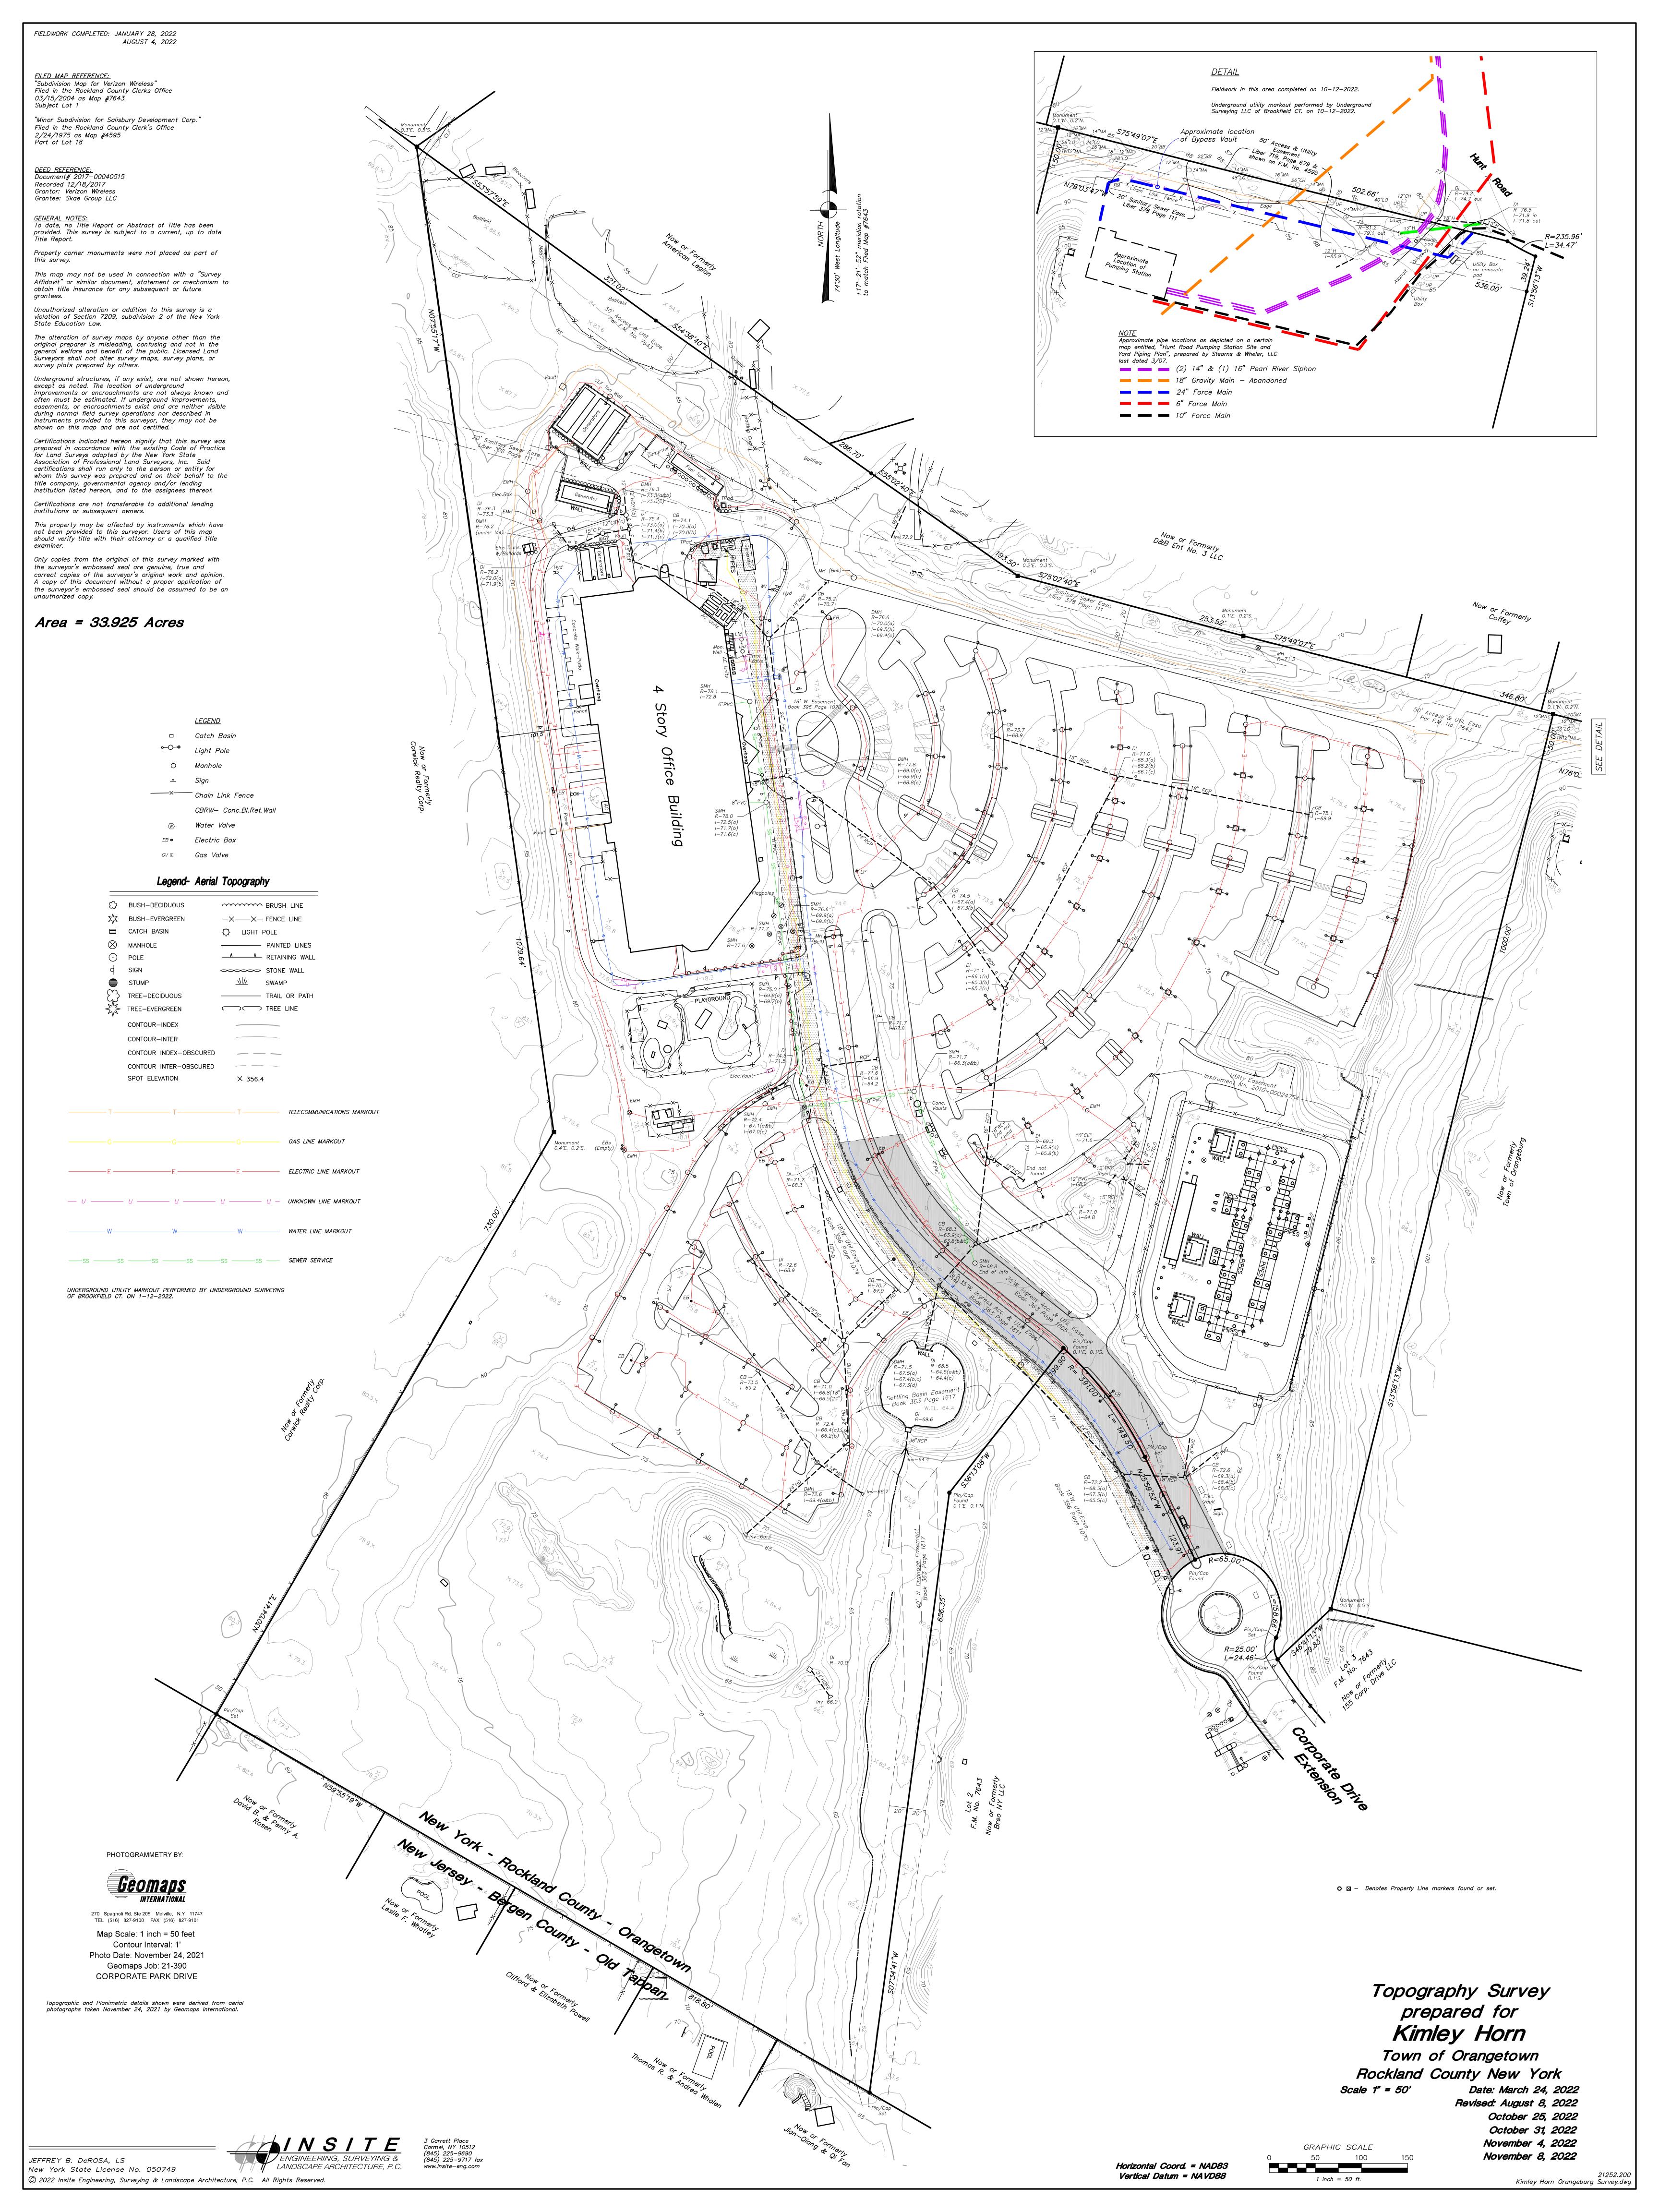
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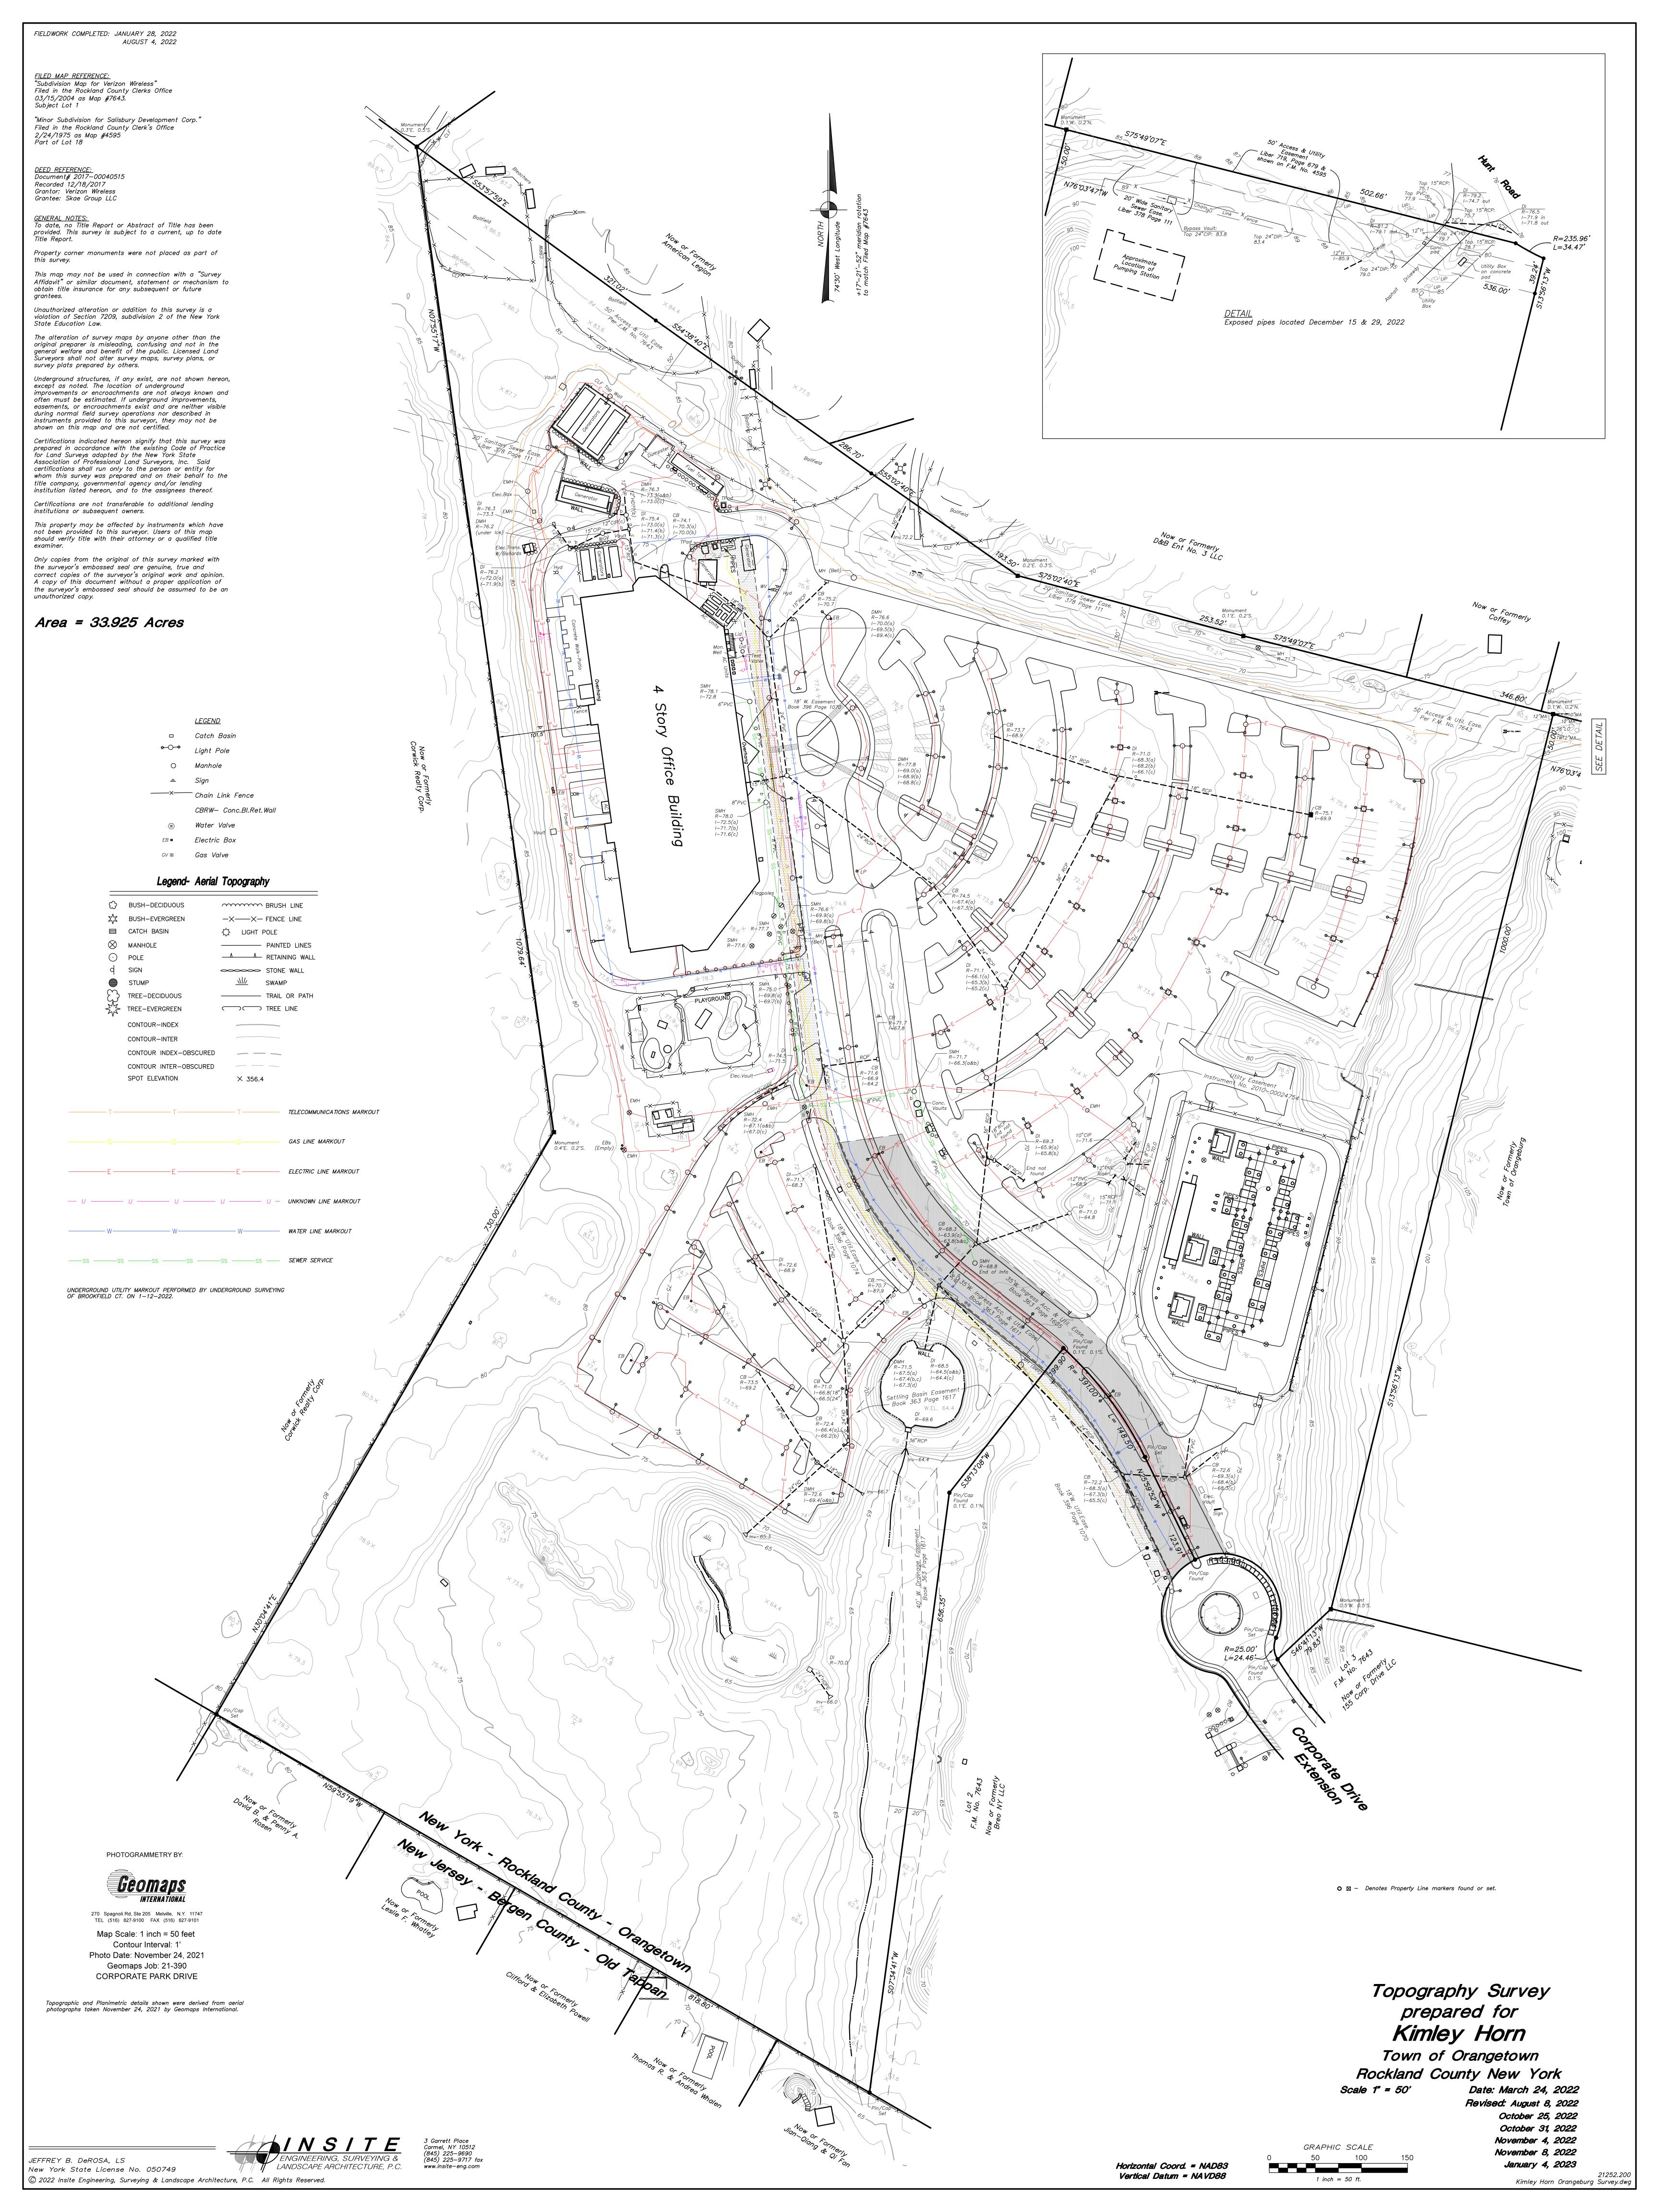
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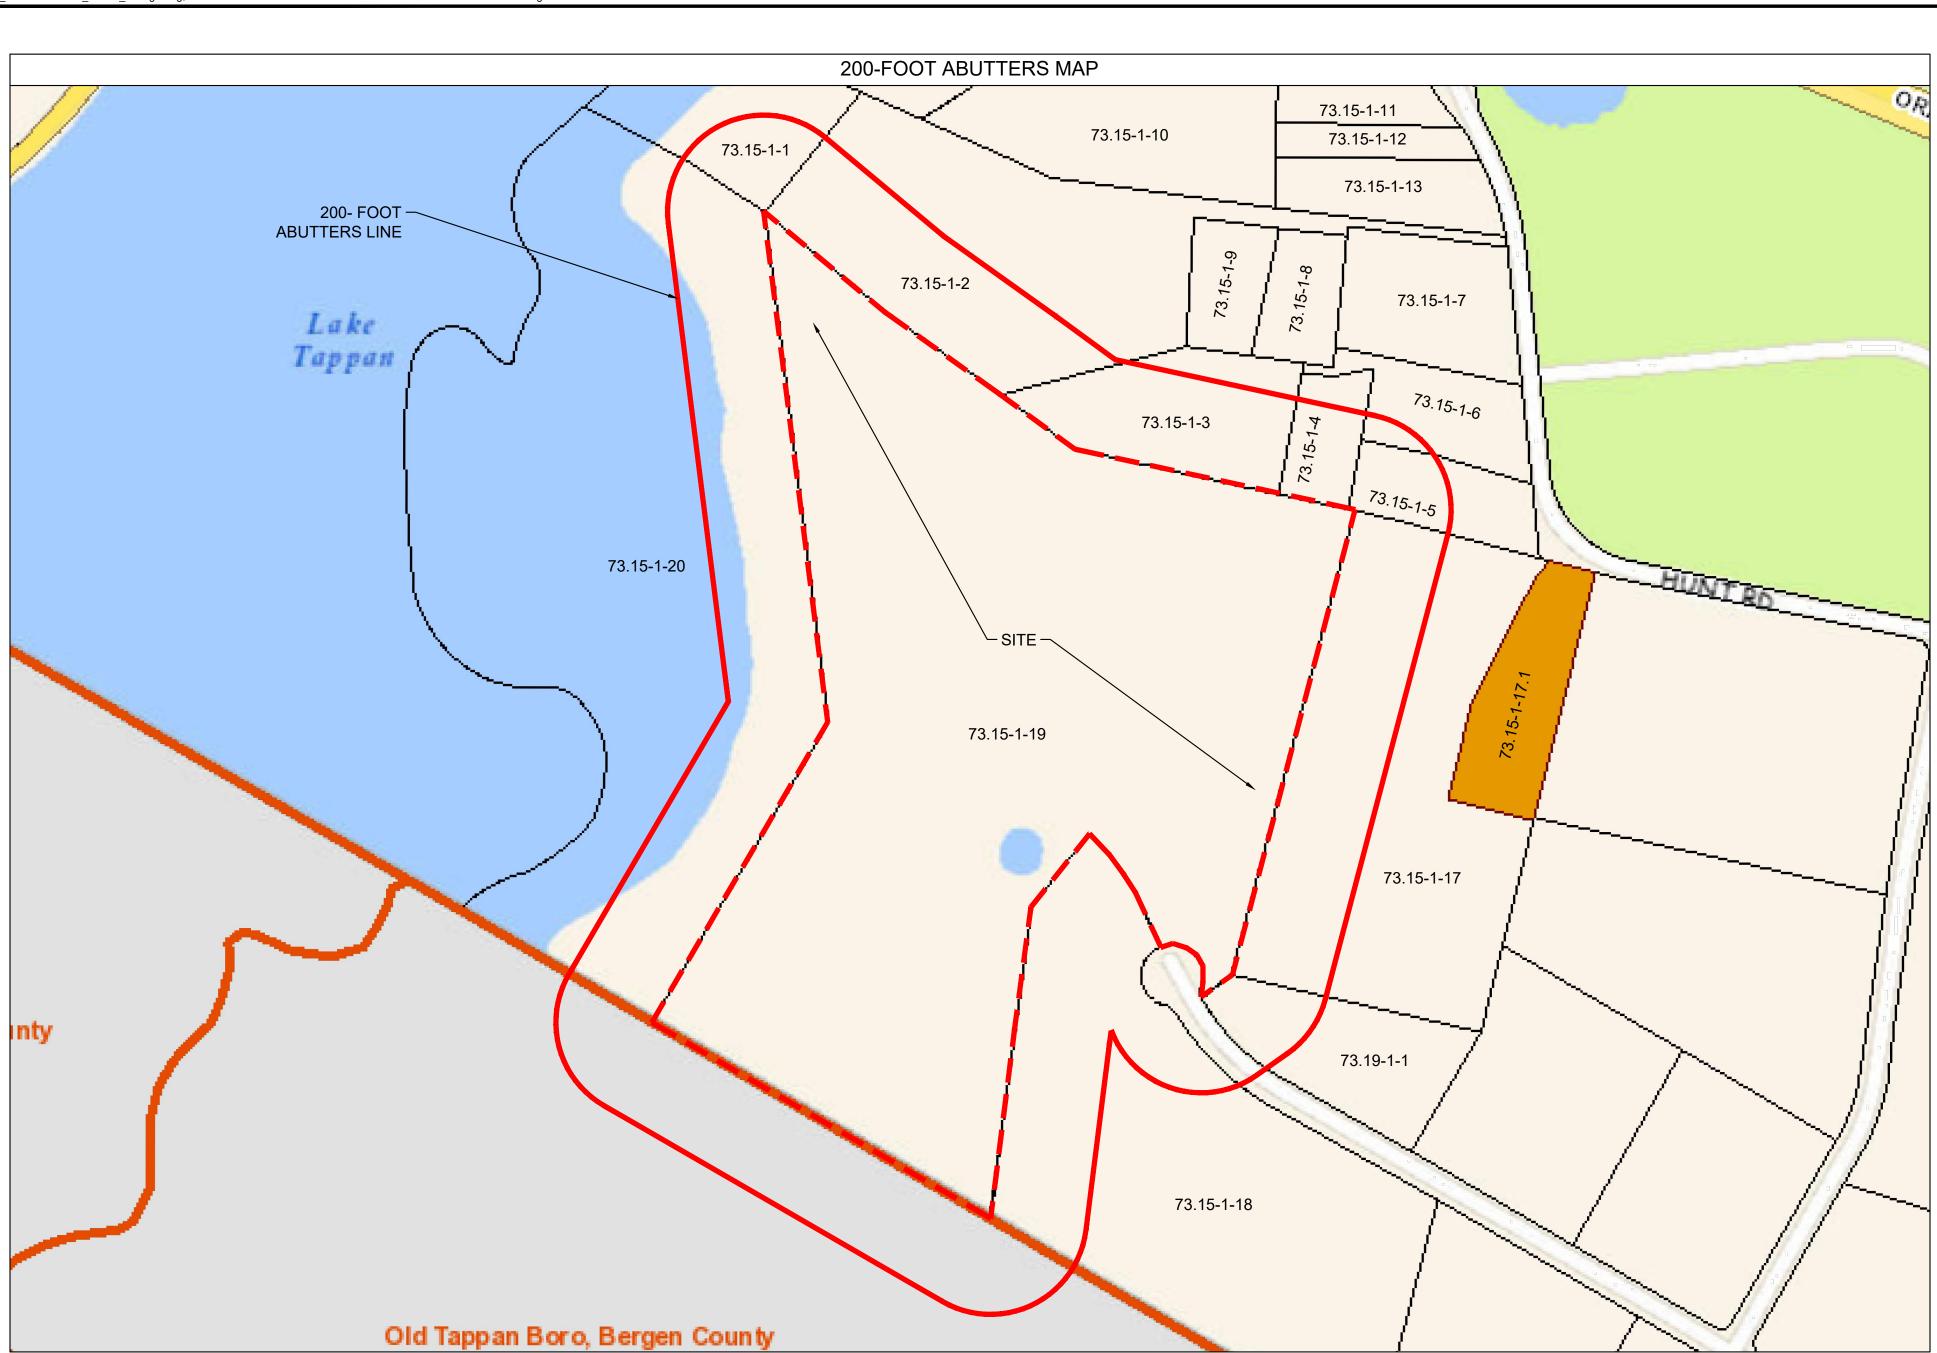
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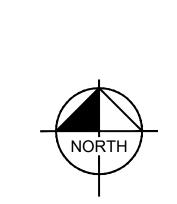
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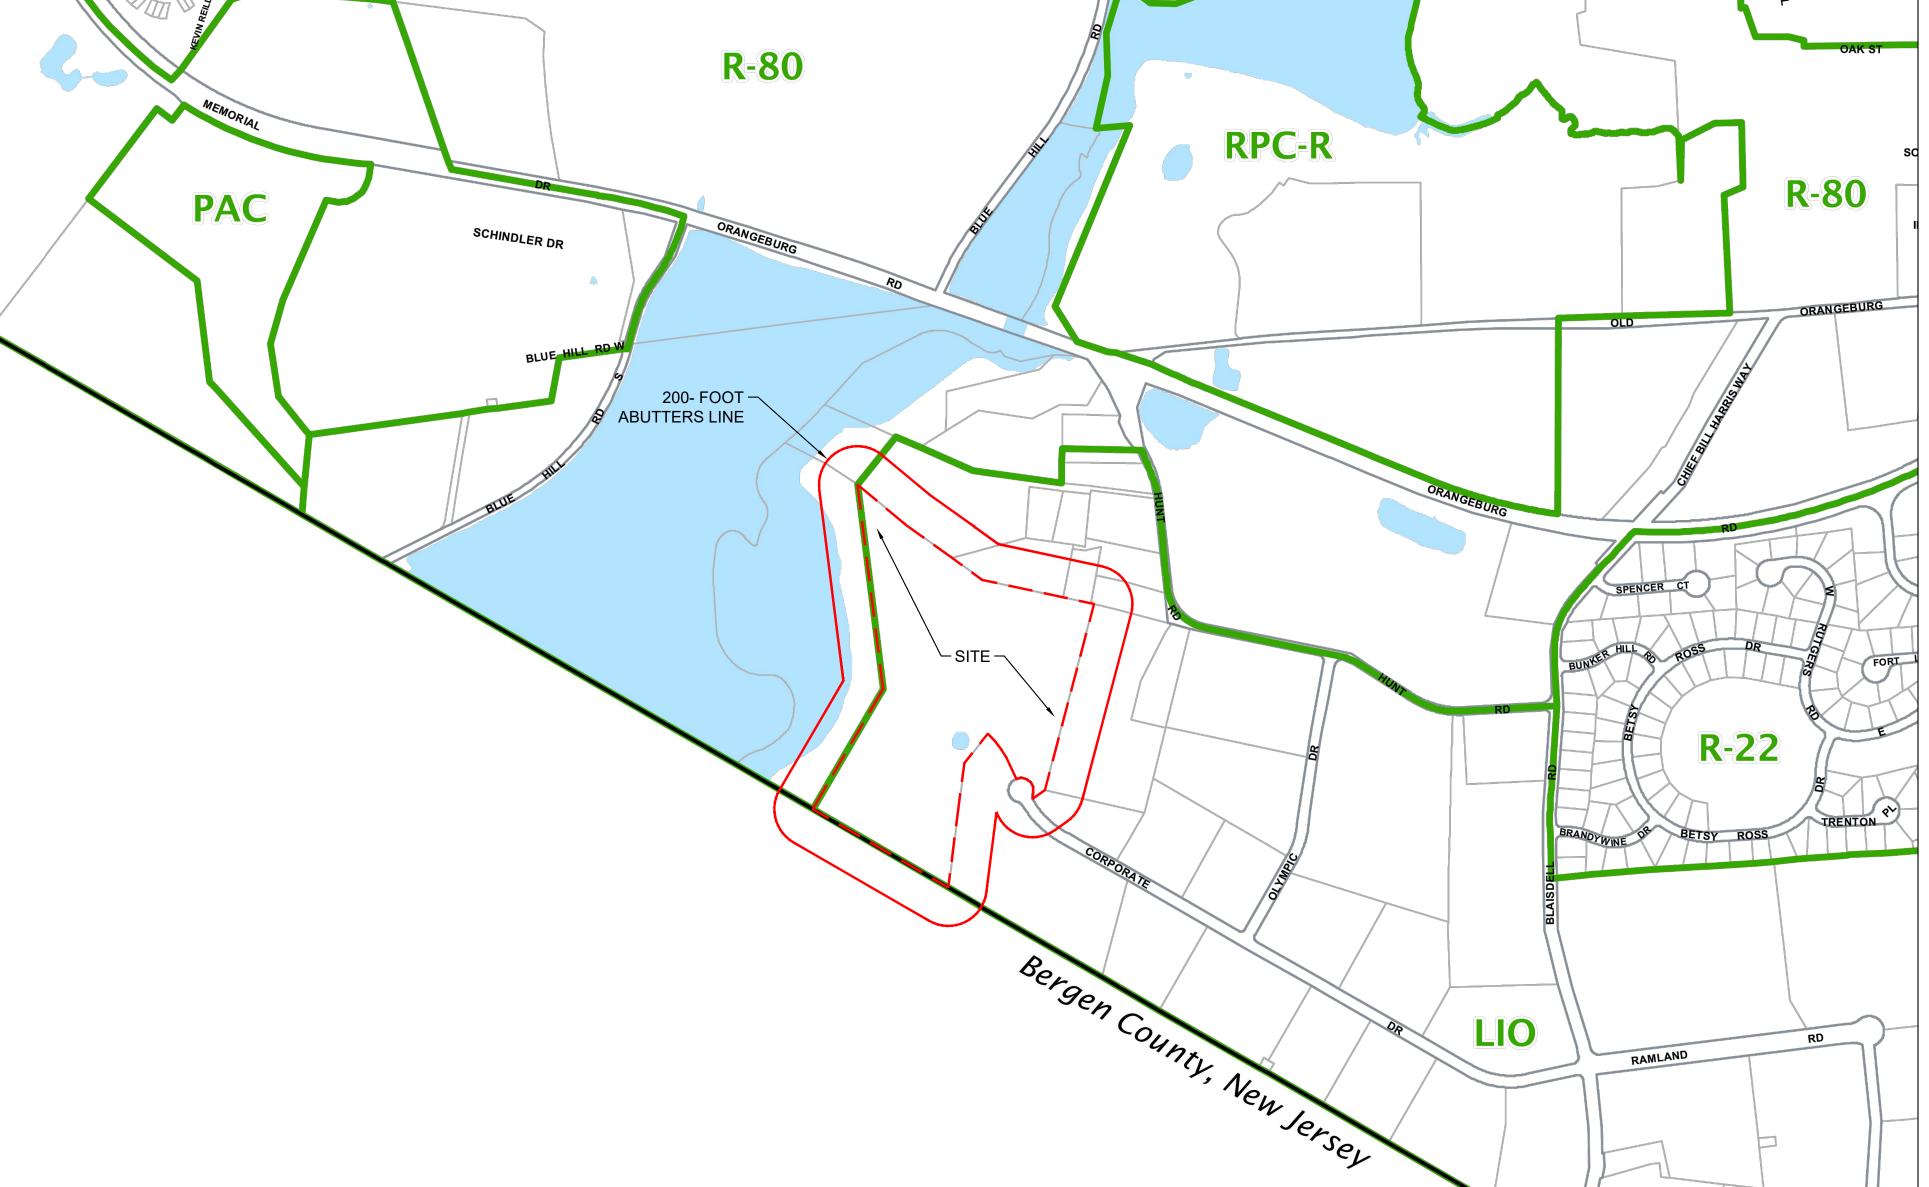





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392489	73.14-1-2	Corwick Realty Corp Altus Group US Inc	P.O. Box 71970, Phoenix, AZ 85050	
392489	73.15-1-1	Corwick Realty Corp Joseph Chimenti	7 Van Terrace,Sparkill, NY 10976	
392489	73.15-1-2	American Legion Joseph Chimenti	7 Van Ter,Sparkill, NY 10976	
392489	73.15-1-3	D & B Ent No 3 LLC	10 Dorsey Ct, Orangeburg, NY 10962	
392489	73.15-1-4	James Coffey	95 Putnam Ave, Portchester, NY 10573	
392489	73.15-1-5	Melody P Fiore	P.O. Box 66, Orangeburg, NY 10962	
392489	73.15-1-6	Jacqueline M Fiore	28 Strawtown Rd, West Nyack Ny, 10994	
392489	73.15-1-7	85 Hunt Road LLC Claude Baumann	15 Winding Way,Upper Saddle River, NJ 07458	
392489	73.15-1-8	Kiera Burtch	73 Hunt Rd, Orangeburg, NY 10962	
392489	73.15-1-9	67 Hunt Road LLC	67 Hunt Rd,Orangeburg, NY 10962	
392489	73.15-1-10	Brightview Lake Tappan LLC Altus Group	P.O. Box 92129, Southlake, TX 76092	
392489	73.15-1-11	Kazziegirl LLC	2 Rolyn Hill Dr, Orangeburg, NY 10962	
392489	73.15-1-12	Joseph Missale	41 Hunt Rd, Orangeburg, NY 10962	
392489	73.15-1-13	Grace B Meyer	9 Paradise Ave, Piermont, NY 10968	
392489	73.15-1-15	Daikin America Inc	20 Olympic Dr, Orangeburg, NY 10962	
392489	73.15-1-16	SQ Properties LLC	8 Olympic Dr,Orangeburg, NY 10962	
392489	73.15-1-17	Town Of Orangetown	26 Orangeburg Rd, Orangeburg, NY 10962	
392489	73.15-1-18	BREO NY LLC Peter Smith	731 Lexington Ave, New York, NY 10022	
392489	73.15-1-19	2000 Corporate Drive LLC	400 S Akard St Ste 100, Dallas, TX 75202	
392489	73.15-1-20	Corwick Realty Corp Altus Group US Inc.	P.O. Box 71970, Phoenix, AZ 85050	
392489	73.16-1-1	Town Of Orangetown	26 Orangeburg Rd,Orangeburg, NY 10962	
392489	73.16-2-78	Clarins Usa Inc	15 Olympic Dr, Orangeburg, NY 10962	
392489	73.19-1-1	BREO NY LLC Peter Smith	731 Lexington Ave, New York, NY 10022	
392489	73.19-1-2	30 Corporate LLC	151 N Main St Ste 400, New City, NY 10956	
392489	73.19-1-3	Csilleberc Inc	20 Corporate Dr, Orangeburg, NY 10962	
392489	73.19-1-5	One Olympic Drive LLC	1 Olympic Dr, Orangeburg, NY 10962	
392489	73.19-1-8	29 Corporate Drive LLC	200 Performance Dr Ste 207, Mahwah, NJ 07495	
392489	73.19-1-9	Ford 33 Realty LLC	100 Challenger Rd Ste 105, Ridgefield Park, NJ 0765	



GRAPHIC SCALE IN FEET
100 200 40



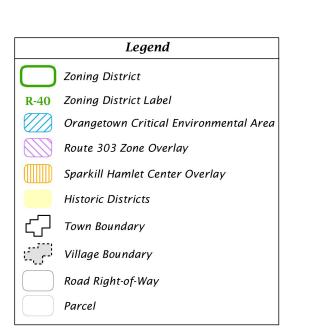ZONING MAP





NOTES

ZONING MAP SOURCE:
ORANGETOWN ZONING MAP (ADOPTED DECEMBER 11,2018)
https://www.orangetown.com/wp-content/uploads/Orangetown\_Zoning\_Adopted\_Dec\_11\_2018\_opt.pdf

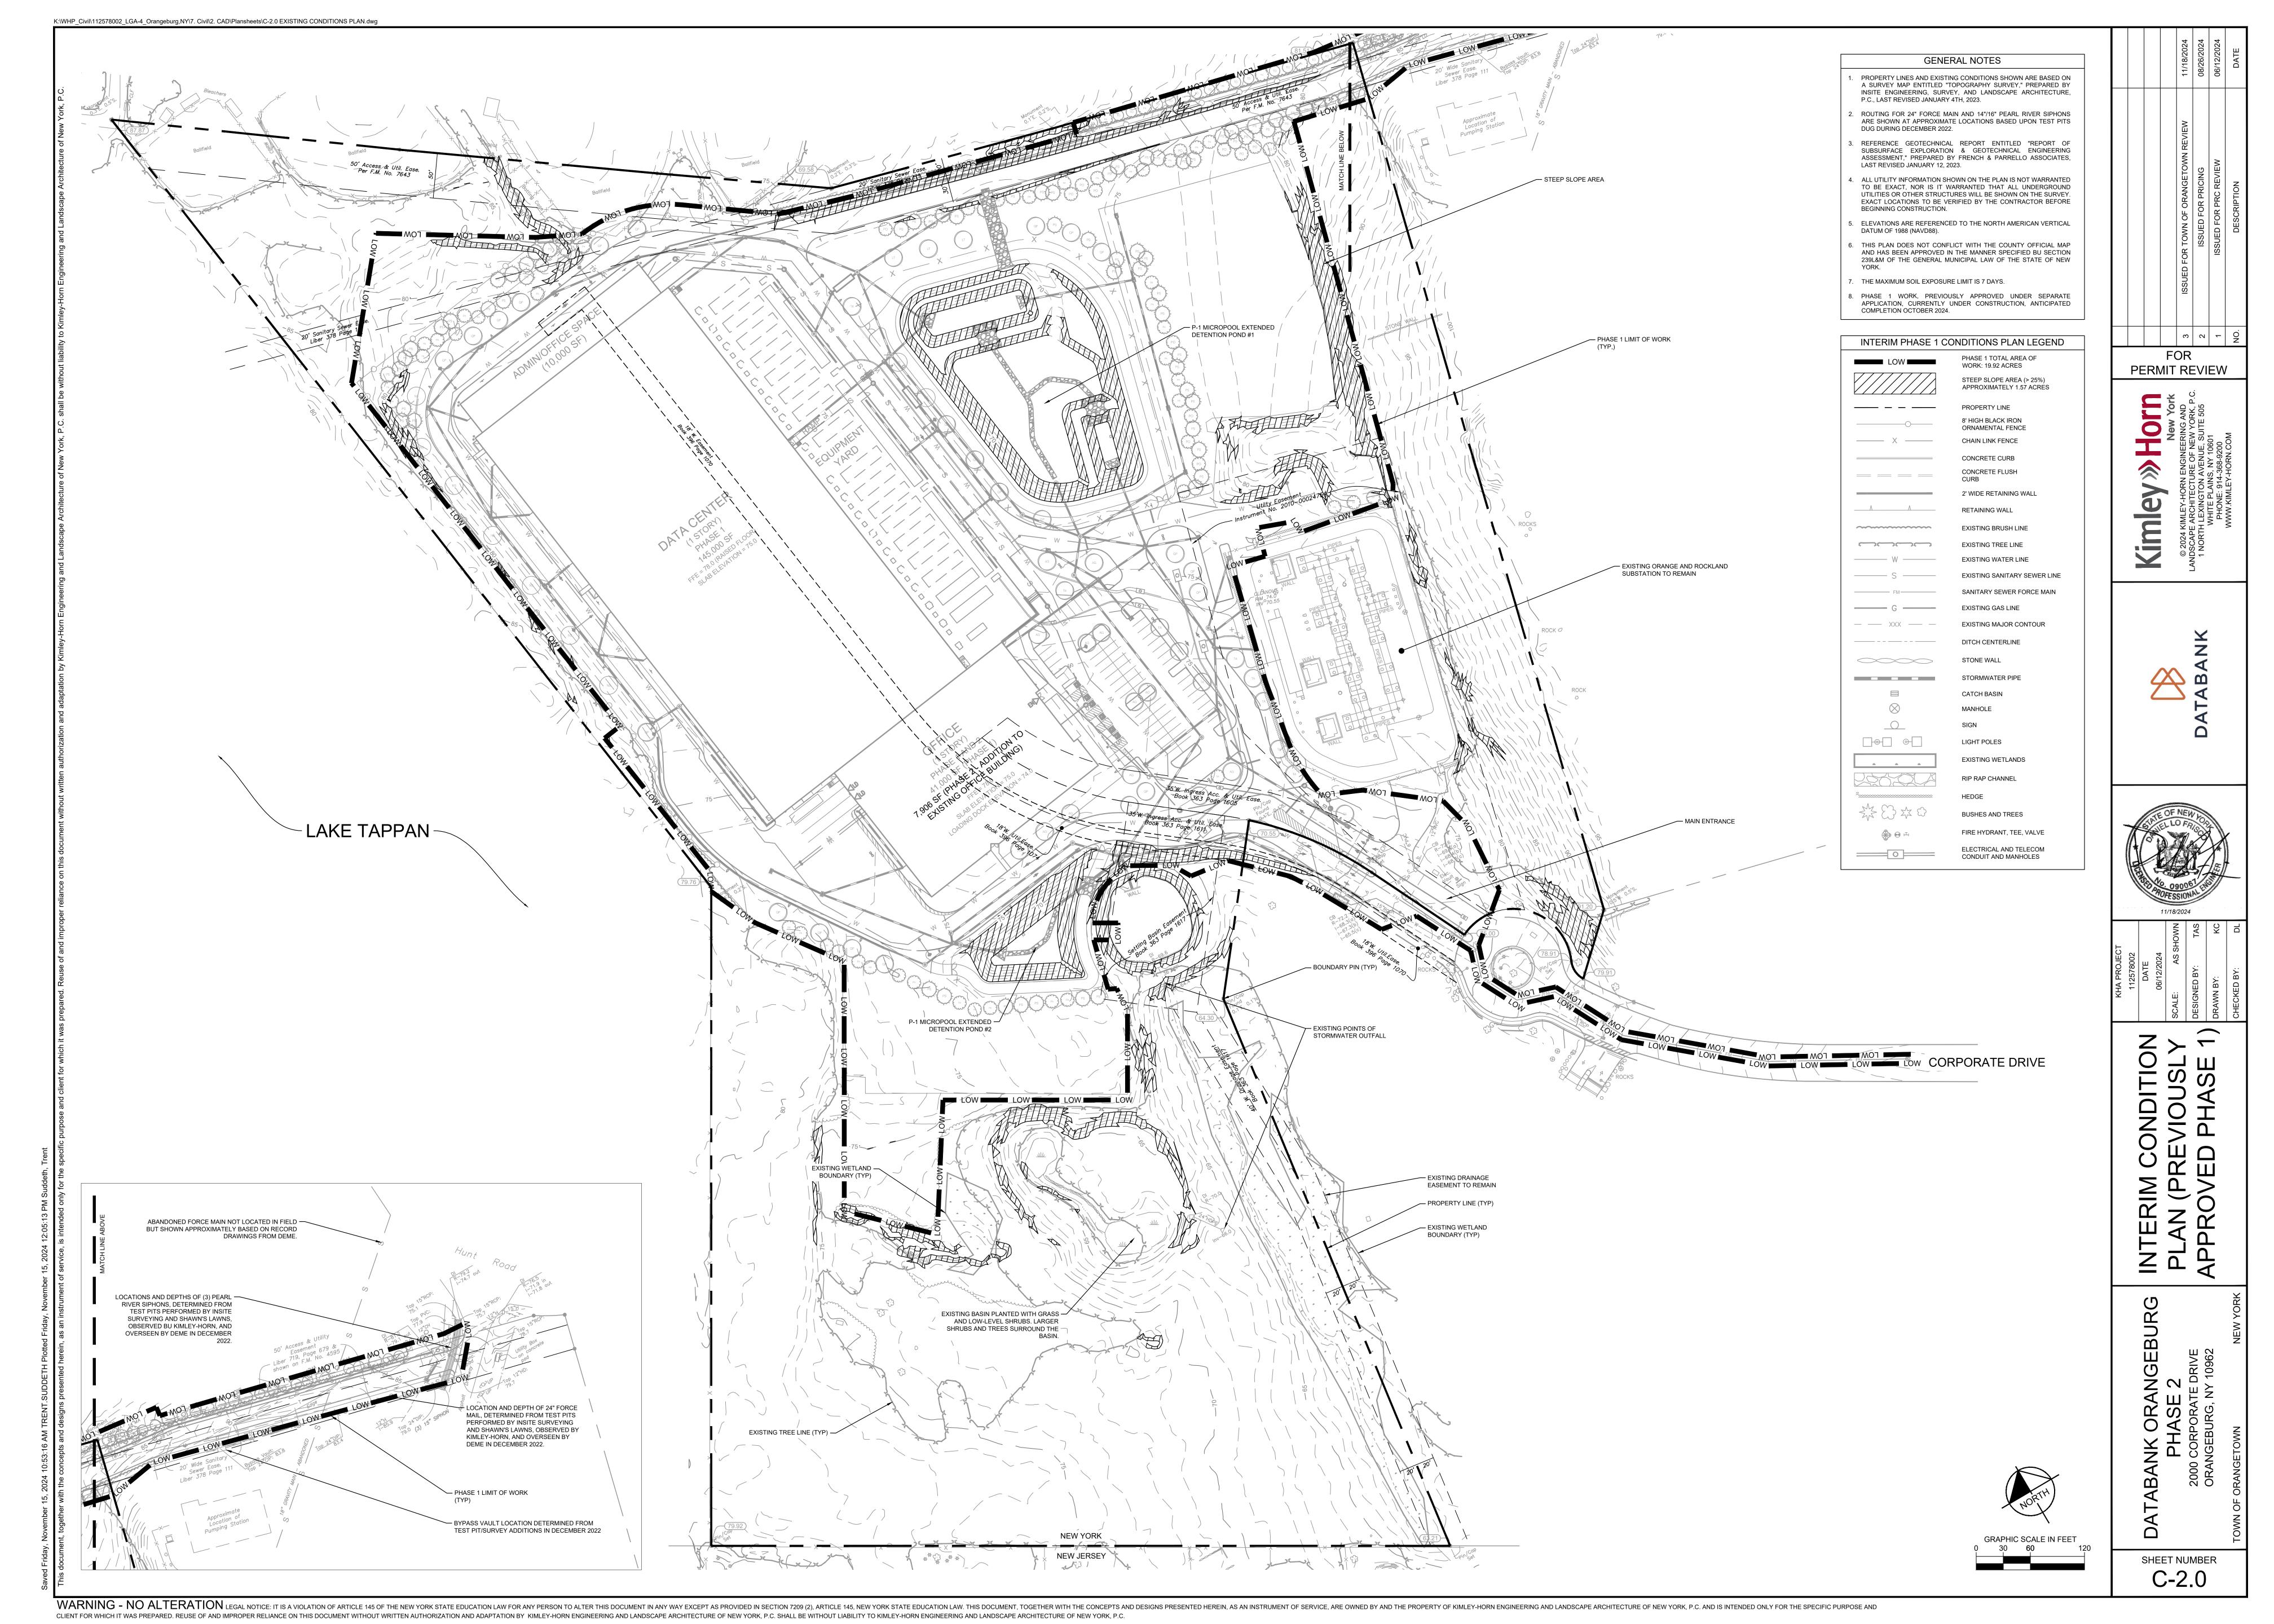
PARCEL DATA SOURCE:
ROCKLAND COUNTY GML MAP APPLICATON, PLANNING DEPARTMENT -GIS
https://www.rocklandgis.com/portal/apps/sites/#/data/app/71bc97364aa743858ff39457585a88fa

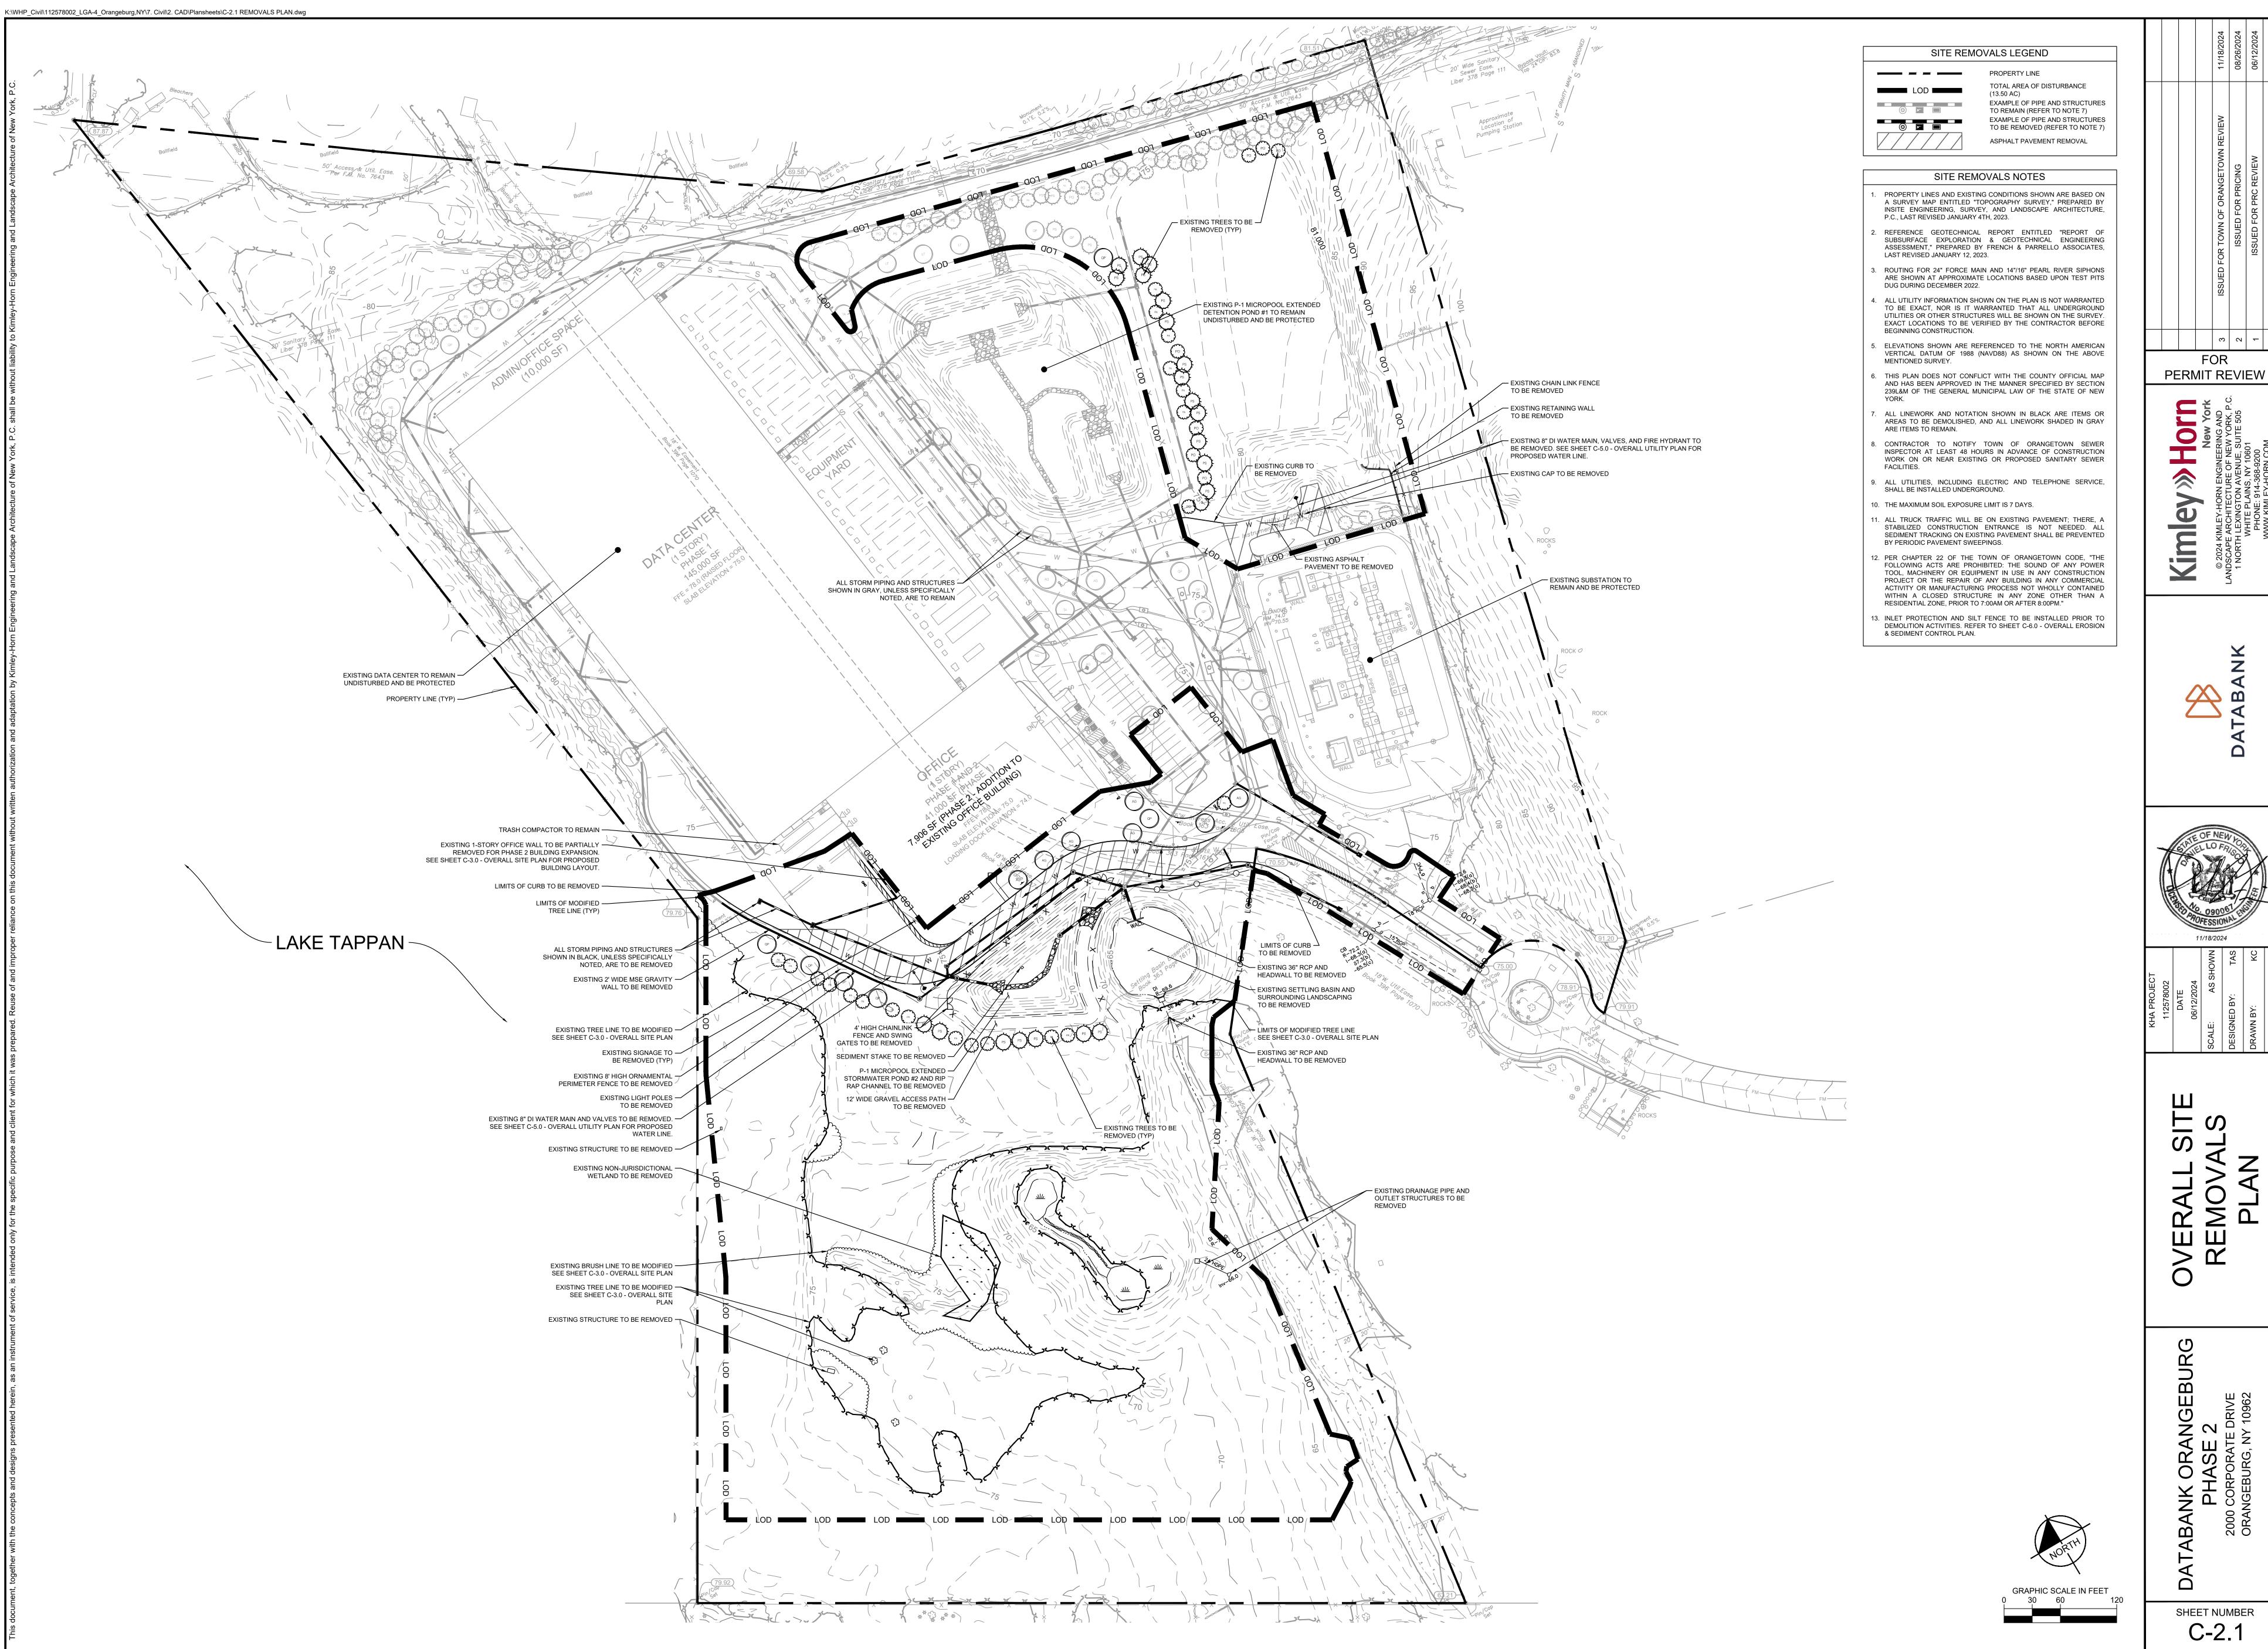
ABUTTERS LIST SOURCE:
ROCKLAND COUNTY GIS AND BERGEN COUNTY GIS

KIMLEY-HORN DOES NOT GUARANTEE THE ACCURACY OR COMPLETENESS OF THE INFORMATION PROVIDED ON THIS SHEET. INFORMATION PROVIDED FOR GENERAL INFORMATIONAL PURPOSES ONLY.

PERMIT REVIEW











SHEET NUMBER

C-2.1

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CLIENT FOR WHICH IT WAS PREPARED. REUSE OF AND IMPROPER RELIANCE ON THIS DOCUMENT WITHOUT WRITTEN AUTHORIZATION AND ADAPTATION BY KIMLEY-HORN ENGINEERING AND LANDSCAPE ARCHITECTURE OF NEW YORK, P.C. SHALL BE WITHOUT LIABILITY TO KIMLEY-HORN ENGINEERING AND LANDSCAPE ARCHITECTURE OF NEW YORK, P.C.

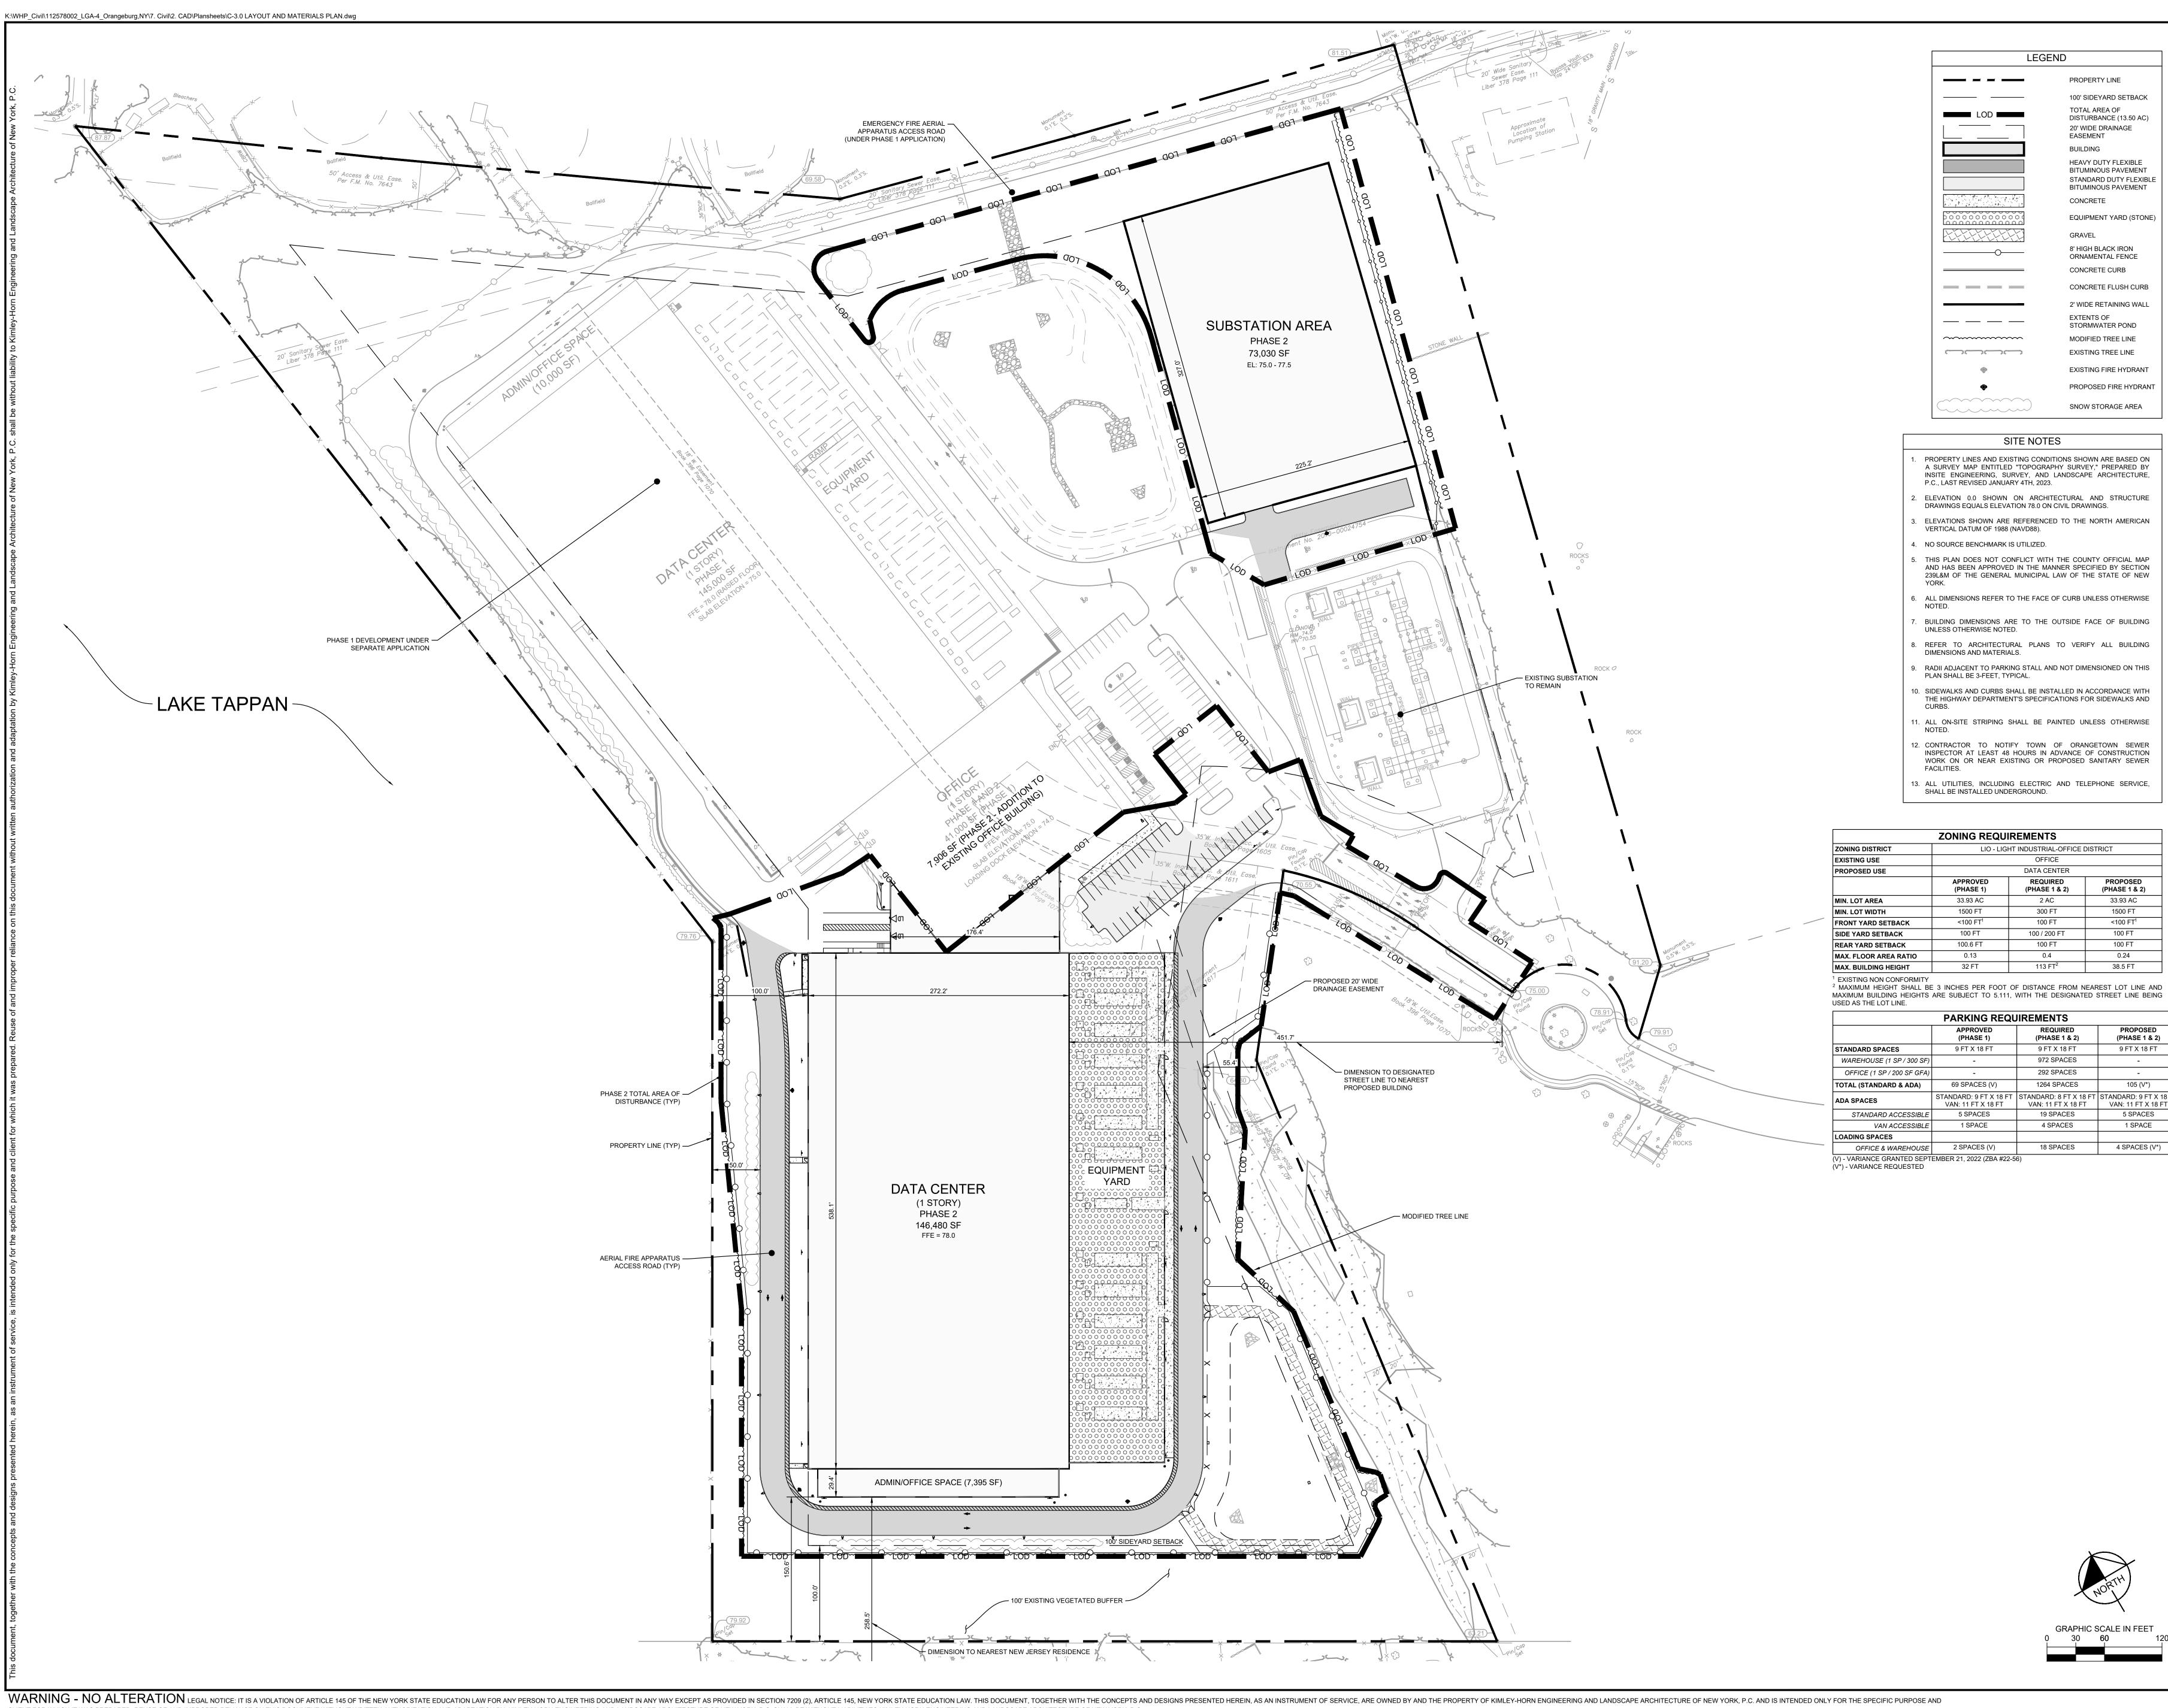

SITE NOTES

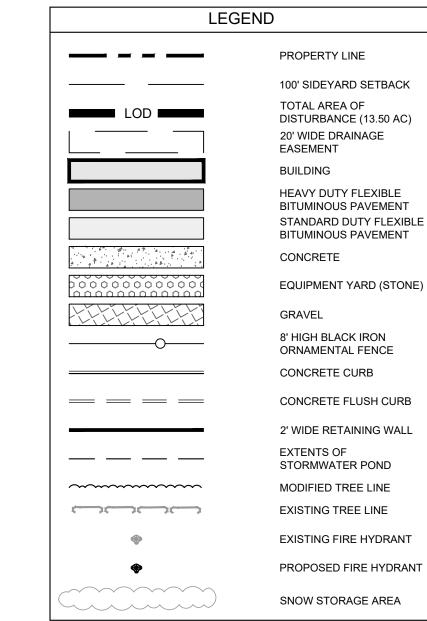PROPERTY LINES AND EXISTING CONDITIONS SHOWN ARE BASED ON A SURVEY MAP ENTITLED "TOPOGRAPHY SURVEY," PREPARED BY INSITE ENGINEERING, SURVEY, AND LANDSCAPE ARCHITECTURE,

- DRAWINGS EQUALS ELEVATION 78.0 ON CIVIL DRAWINGS. ELEVATIONS SHOWN ARE REFERENCED TO THE NORTH AMERICAN
- VERTICAL DATUM OF 1988 (NAVD88).
- THIS PLAN DOES NOT CONFLICT WITH THE COUNTY OFFICIAL MAP AND HAS BEEN APPROVED IN THE MANNER SPECIFIED BY SECTION 239L&M OF THE GENERAL MUNICIPAL LAW OF THE STATE OF NEW
- BUILDING DIMENSIONS ARE TO THE OUTSIDE FACE OF BUILDING
- REFER TO ARCHITECTURAL PLANS TO VERIFY ALL BUILDING
- RADII ADJACENT TO PARKING STALL AND NOT DIMENSIONED ON THIS PLAN SHALL BE 3-FEET, TYPICAL.
- 0. SIDEWALKS AND CURBS SHALL BE INSTALLED IN ACCORDANCE WITH THE HIGHWAY DEPARTMENT'S SPECIFICATIONS FOR SIDEWALKS AND
- I. ALL ON-SITE STRIPING SHALL BE PAINTED UNLESS OTHERWISE
- WORK ON OR NEAR EXISTING OR PROPOSED SANITARY SEWER

13. ALL UTILITIES, INCLUDING ELECTRIC AND TELEPHONE SERVICE, SHALL BE INSTALLED UNDERGROUND.

	ZOMINO INEQU	IIVEINIEIVIO		
ZONING DISTRICT	LIO - LIGHT INDUSTRIAL-OFFICE DISTRICT			
EXISTING USE	OFFICE			
PROPOSED USE	DATA CENTER			
	APPROVED (PHASE 1)	REQUIRED (PHASE 1 & 2)	PROPOSED (PHASE 1 & 2)	
MIN. LOT AREA	33.93 AC	2 AC	33.93 AC	
MIN. LOT WIDTH	1500 FT	300 FT	1500 FT	
FRONT YARD SETBACK	<100 FT <sup>1</sup>	100 FT	<100 FT <sup>1</sup>	
SIDE YARD SETBACK	100 FT	100 / 200 FT	100 FT	
REAR YARD SETBACK	100.6 FT	100 FT	100 FT	
MAX. FLOOR AREA RATIO	0.13	0.4	0.24	
MAX. BUILDING HEIGHT	32 FT	113 FT <sup>2</sup>	38.5 FT	


<sup>1</sup> EXISTING NON CONFORMITY
<sup>2</sup> MAXIMUM HEIGHT SHALL BE 3 INCHES PER FOOT OF DISTANCE FROM NEAREST LOT LINE AND MAXIMUM BUILDING HEIGHTS ARE SUBJECT TO 5.111, WITH THE DESIGNATED STREET LINE BEING


PARKING REQUIREMENTS						
	APPROVED (PHASE 1)	REQUIRED (PHASE 1 & 2)	PROPOSED (PHASE 1 & 2)			
STANDARD SPACES	9 FT X 18 FT	9 FT X 18 FT	9 FT X 18 FT			
WAREHOUSE (1 SP / 300 SF)	-	972 SPACES	-			
OFFICE (1 SP / 200 SF GFA)	-	292 SPACES	-			
TOTAL (STANDARD & ADA)	69 SPACES (V)	1264 SPACES	105 (V*)			
ADA SPACES	STANDARD: 9 FT X 18 FT VAN: 11 FT X 18 FT	STANDARD: 8 FT X 18 FT VAN: 11 FT X 18 FT	STANDARD: 9 FT X 18 FT VAN: 11 FT X 18 FT			
STANDARD ACCESSIBLE	5 SPACES	19 SPACES	5 SPACES			
VAN ACCESSIBLE	1 SPACE	4 SPACES	1 SPACE			
LOADING SPACES						
OFFICE & WAREHOUSE	2 SPACES (V)	18 SPACES	4 SPACES (V*)			


PERMIT REVIEW

SHEET NUMBER

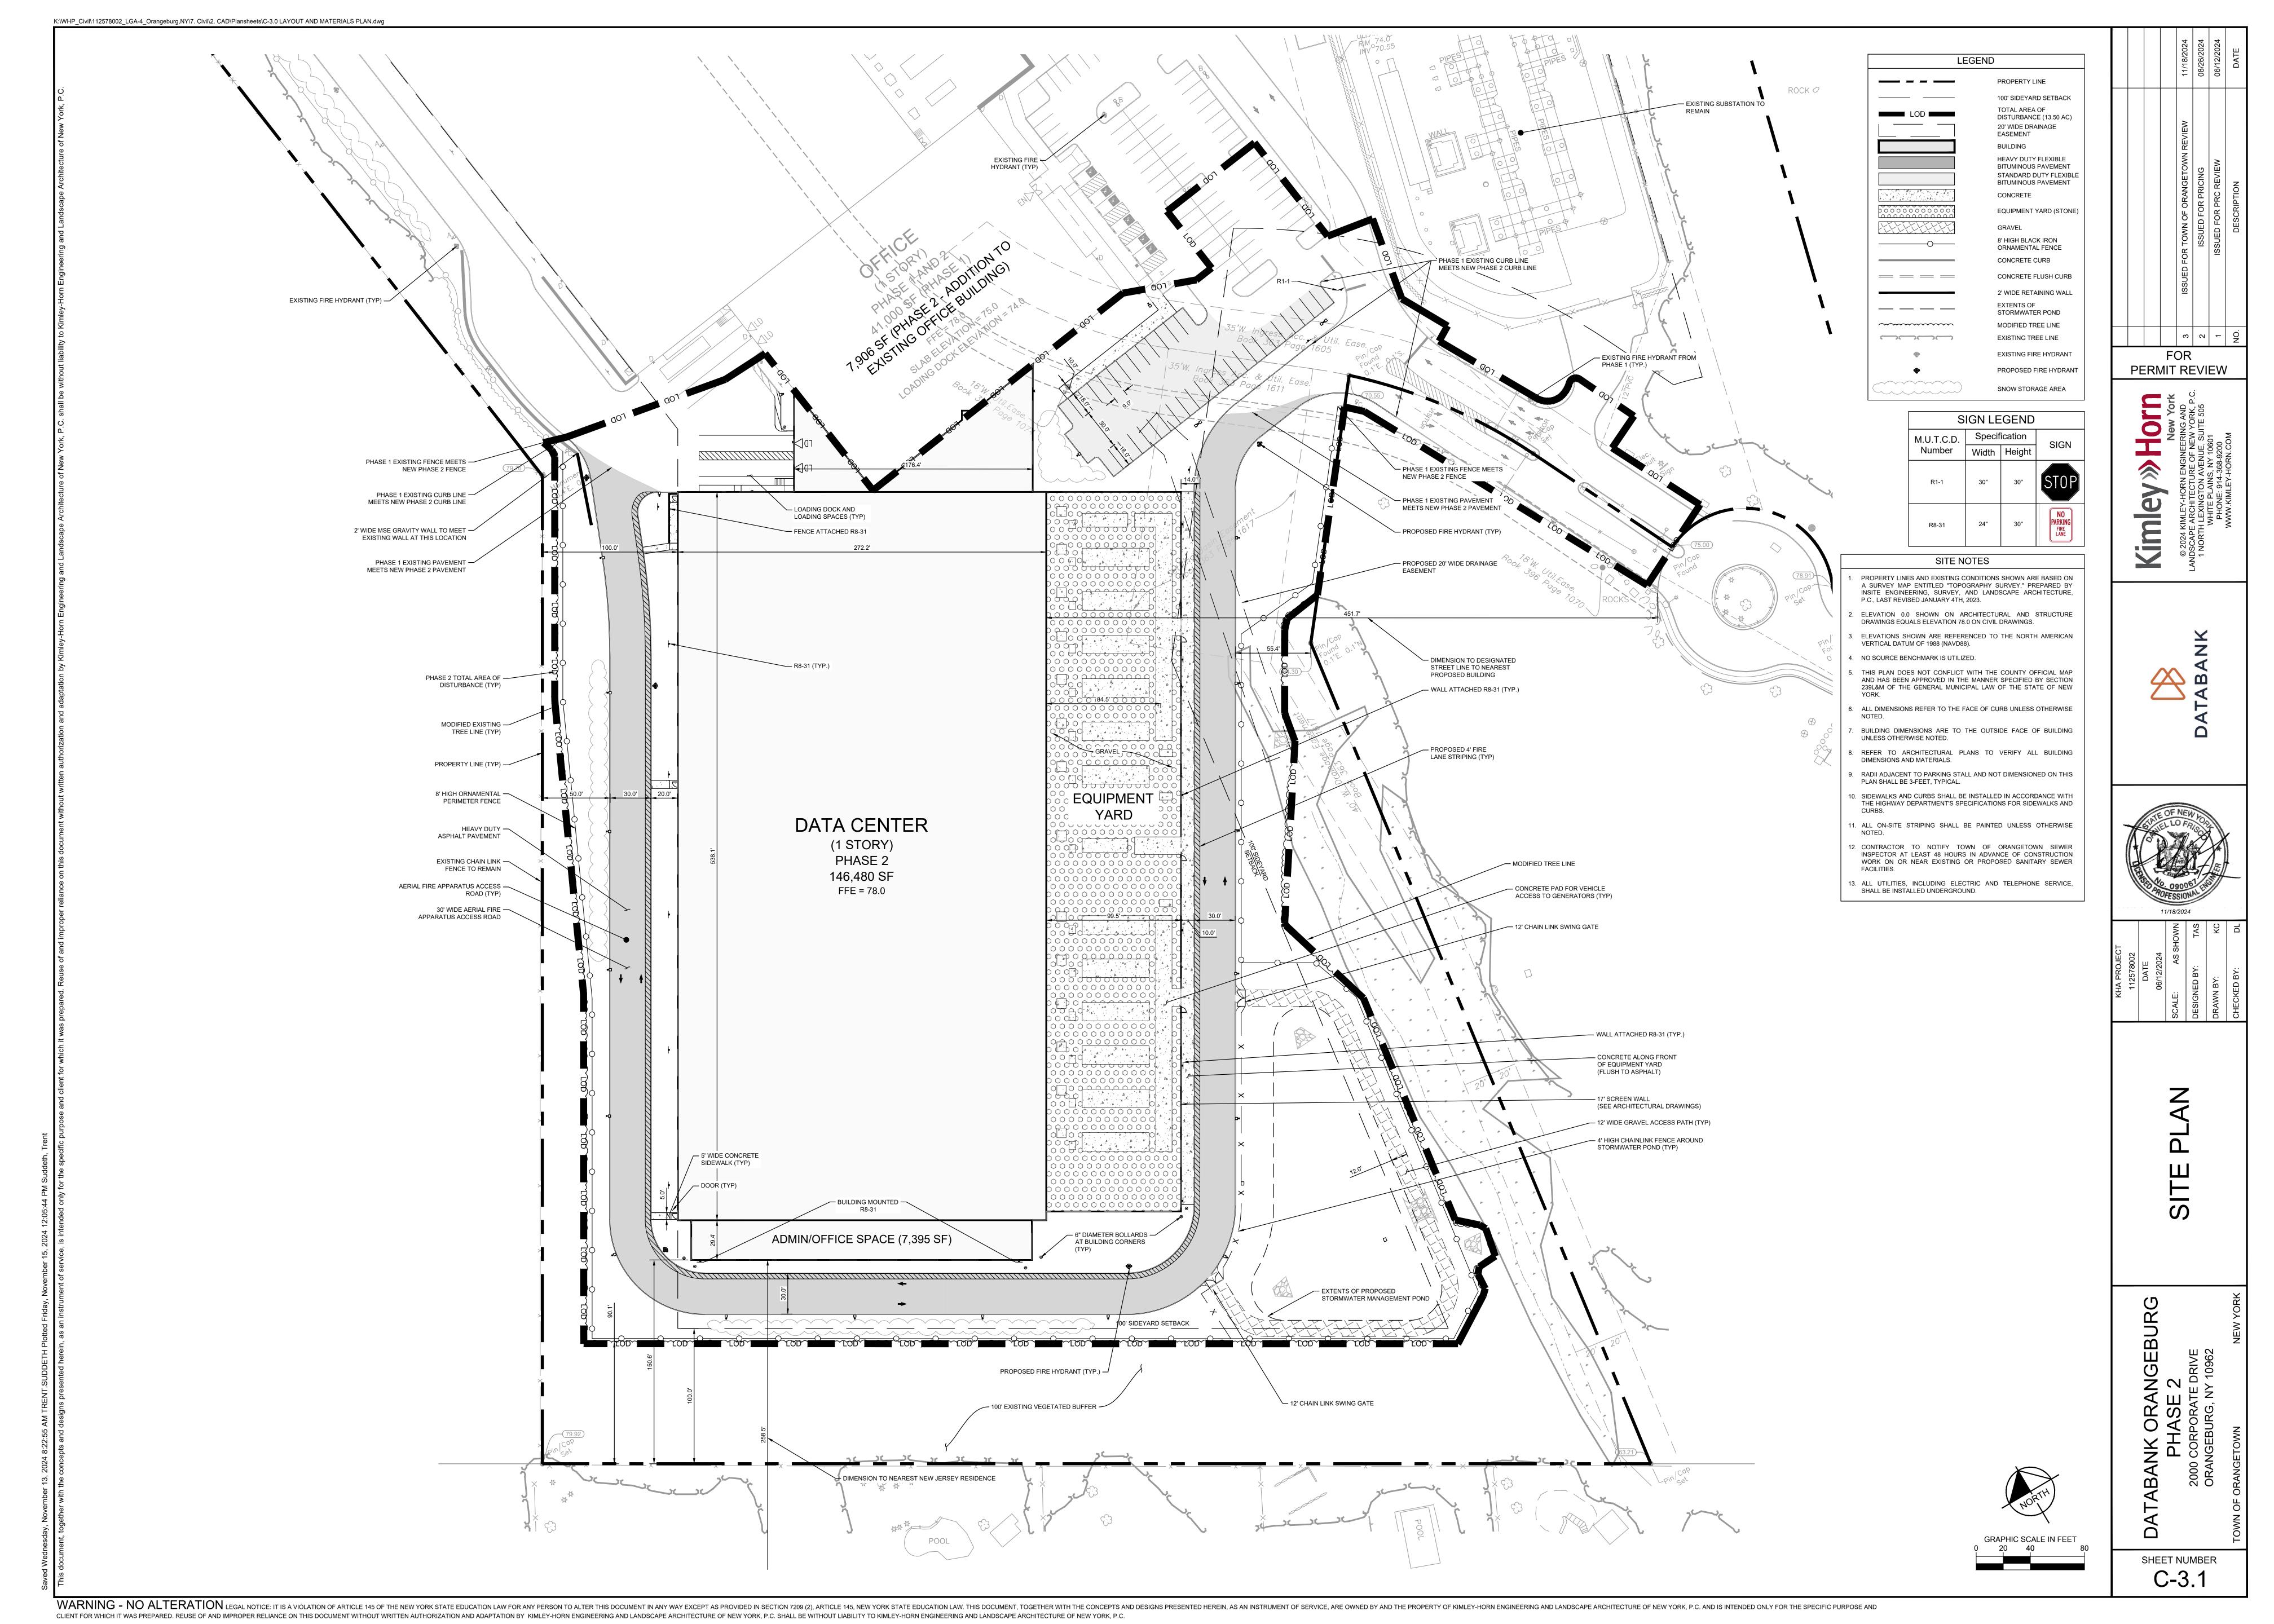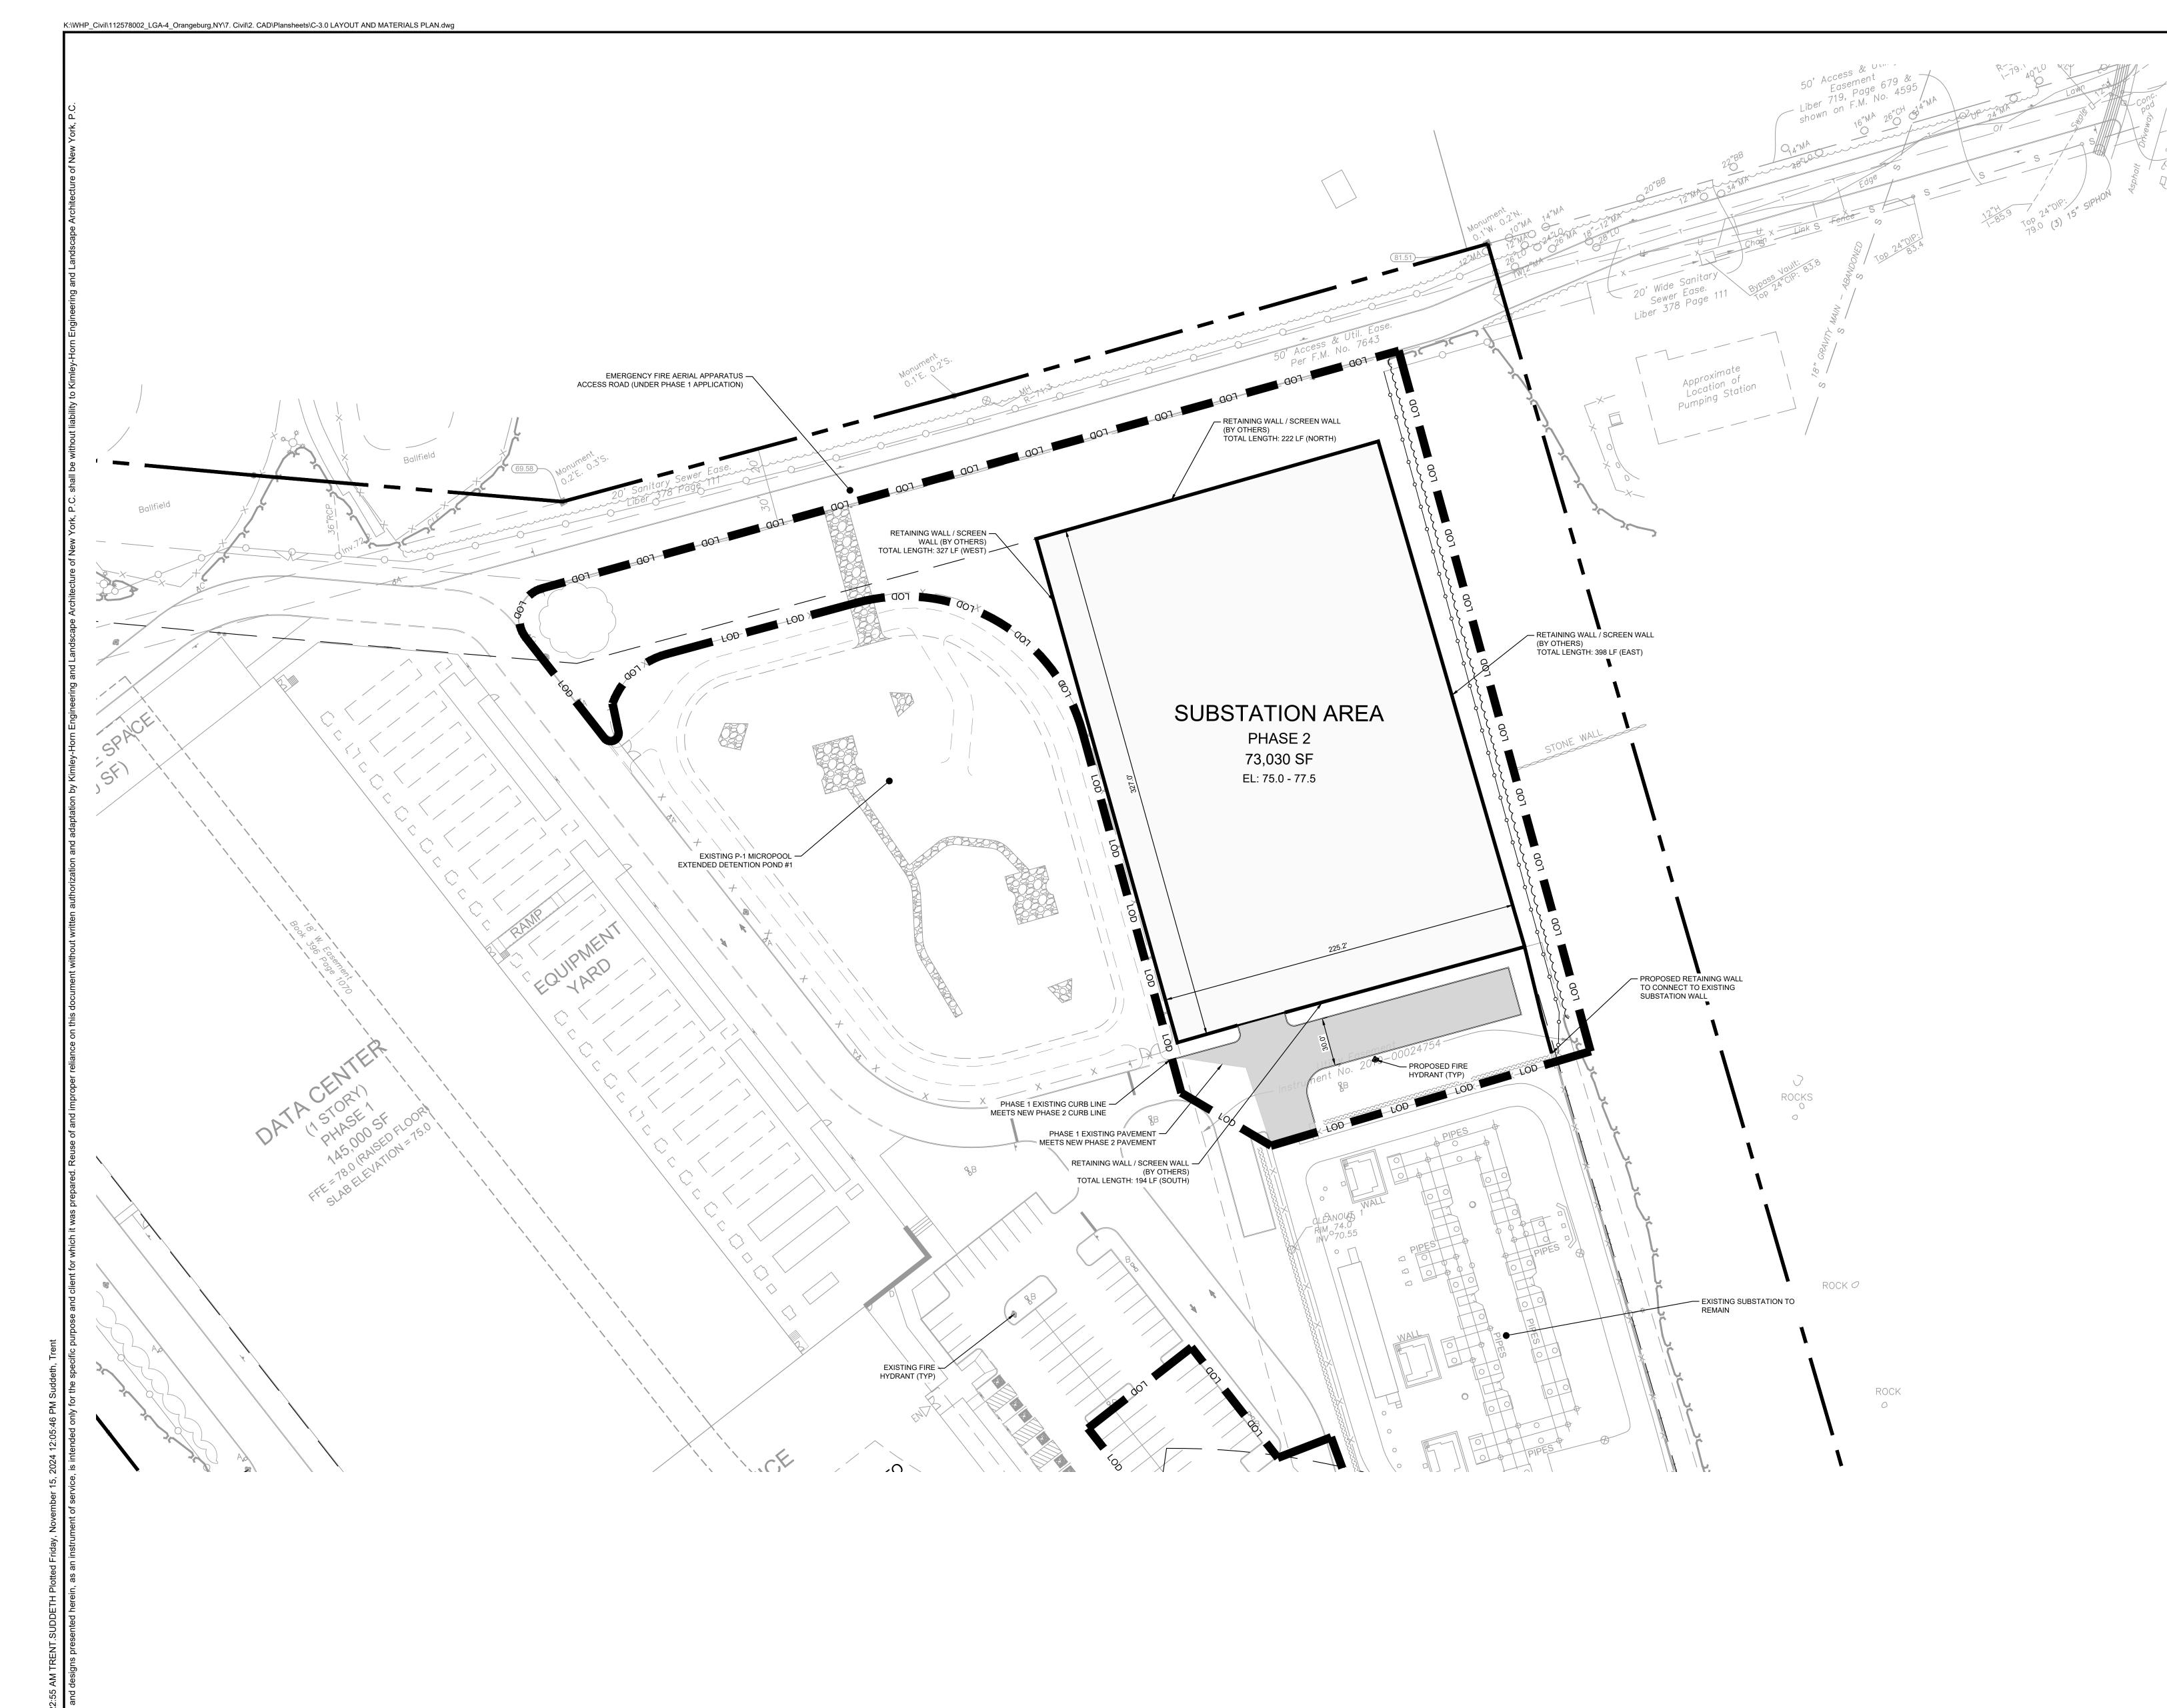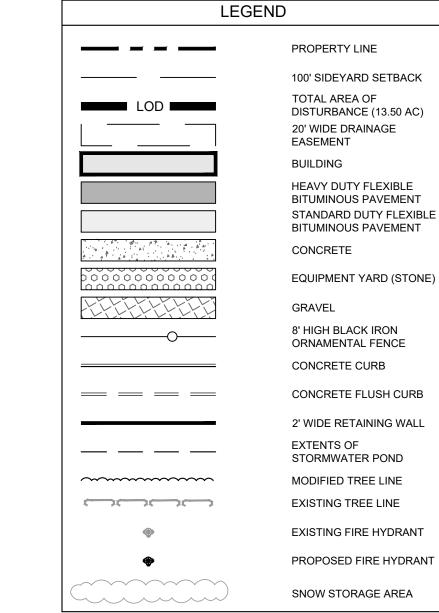C-3.0







### SITE NOTES

- I. PROPERTY LINES AND EXISTING CONDITIONS SHOWN ARE BASED ON A SURVEY MAP ENTITLED "TOPOGRAPHY SURVEY," PREPARED BY INSITE ENGINEERING, SURVEY, AND LANDSCAPE ARCHITECTURE, P.C., LAST REVISED JANUARY 4TH, 2023.
- ELEVATION 0.0 SHOWN ON ARCHITECTURAL AND STRUCTURE DRAWINGS EQUALS ELEVATION 78.0 ON CIVIL DRAWINGS.
- ELEVATIONS SHOWN ARE REFERENCED TO THE NORTH AMERICAN VERTICAL DATUM OF 1988 (NAVD88).
- NO SOURCE BENCHMARK IS UTILIZED.
   THIS PLAN DOES NOT CONFLICT WITH THE COUNTY OFFICIAL MAP
- AND HAS BEEN APPROVED IN THE MANNER SPECIFIED BY SECTION 239L&M OF THE GENERAL MUNICIPAL LAW OF THE STATE OF NEW YORK
- ALL DIMENSIONS REFER TO THE FACE OF CURB UNLESS OTHERWISE NOTED.
- 7. BUILDING DIMENSIONS ARE TO THE OUTSIDE FACE OF BUILDING UNLESS OTHERWISE NOTED.
- 8. REFER TO ARCHITECTURAL PLANS TO VERIFY ALL BUILDING DIMENSIONS AND MATERIALS.
- 9. RADII ADJACENT TO PARKING STALL AND NOT DIMENSIONED ON THIS PLAN SHALL BE 3-FEET, TYPICAL.
- 10. SIDEWALKS AND CURBS SHALL BE INSTALLED IN ACCORDANCE WITH THE HIGHWAY DEPARTMENT'S SPECIFICATIONS FOR SIDEWALKS AND CURBS.
- ALL ON-SITE STRIPING SHALL BE PAINTED UNLESS OTHERWISE NOTED.
- 12. CONTRACTOR TO NOTIFY TOWN OF ORANGETOWN SEWER INSPECTOR AT LEAST 48 HOURS IN ADVANCE OF CONSTRUCTION WORK ON OR NEAR EXISTING OR PROPOSED SANITARY SEWER FACILITIES
- 13. ALL UTILITIES, INCLUDING ELECTRIC AND TELEPHONE SERVICE, SHALL BE INSTALLED UNDERGROUND.

DATABA

PERMIT REVIEW



DATE
06/12/2024
SCALE: AS SHOWN
DESIGNED BY: TAS
DRAWN BY: KC


ITE PLAN


PHASE 2
2000 CORPORATE DRIVE
ORANGEBURG, NY 10962


SHEET NUMBER
C-3.2

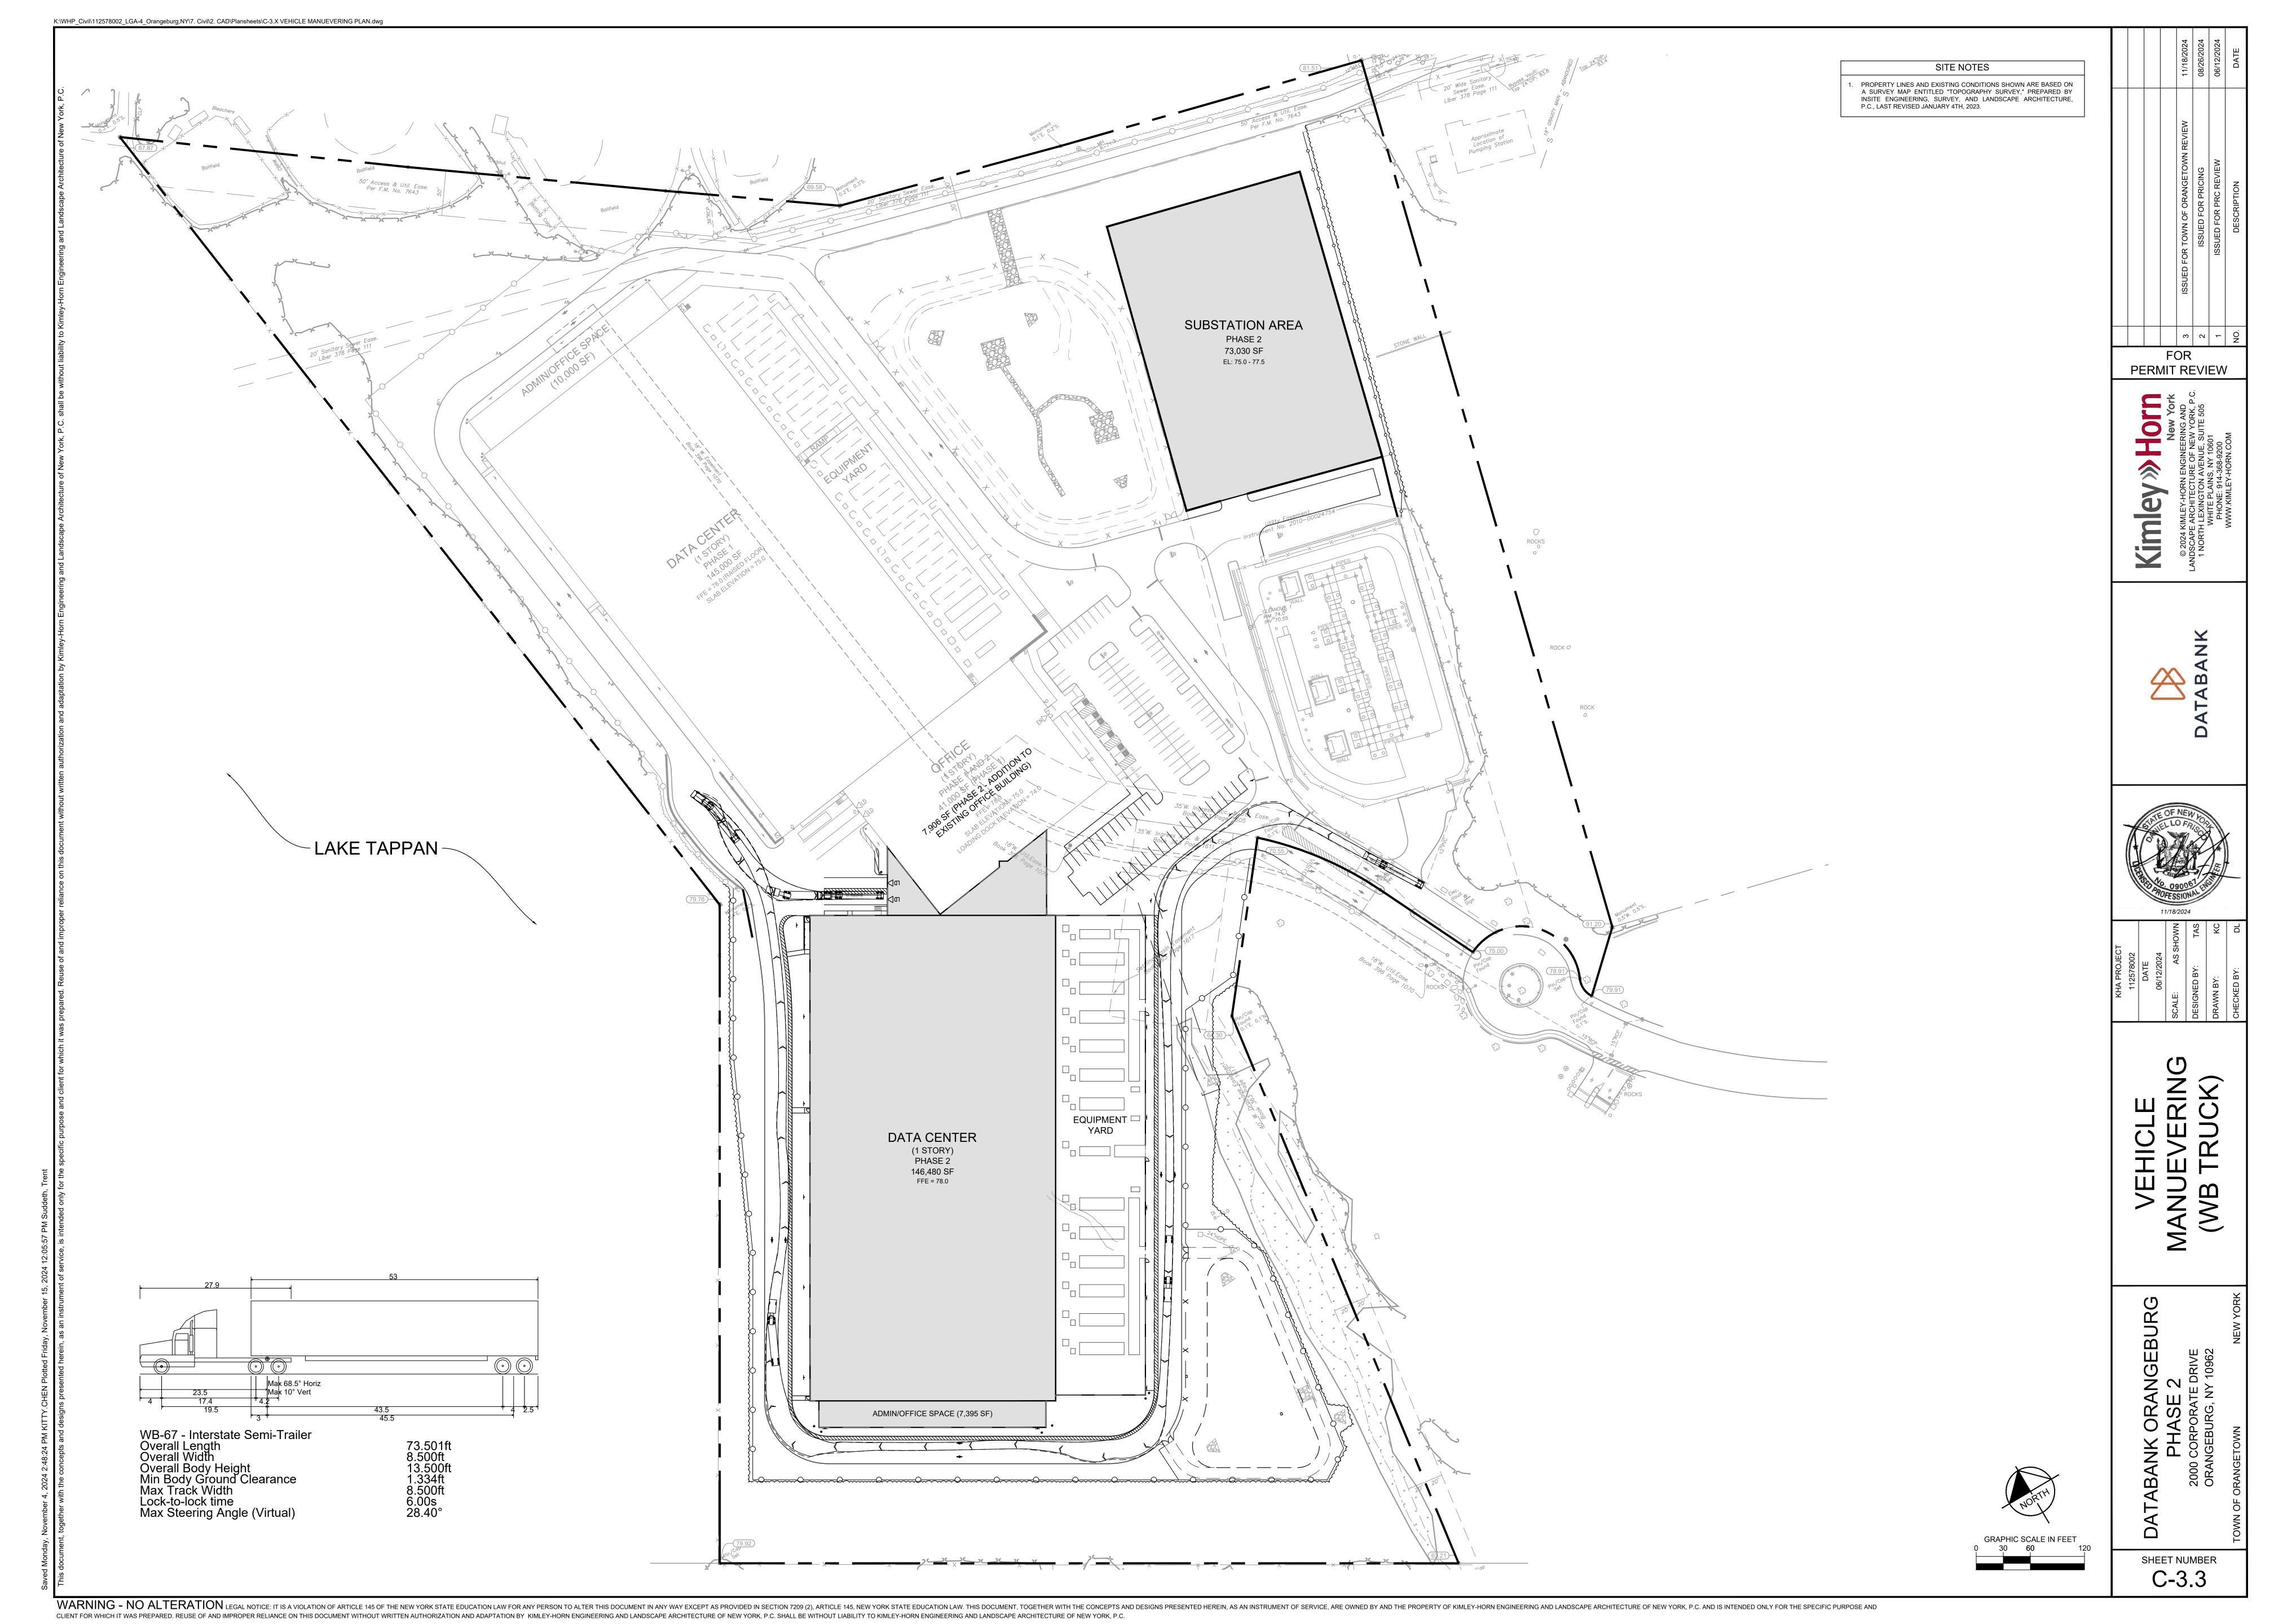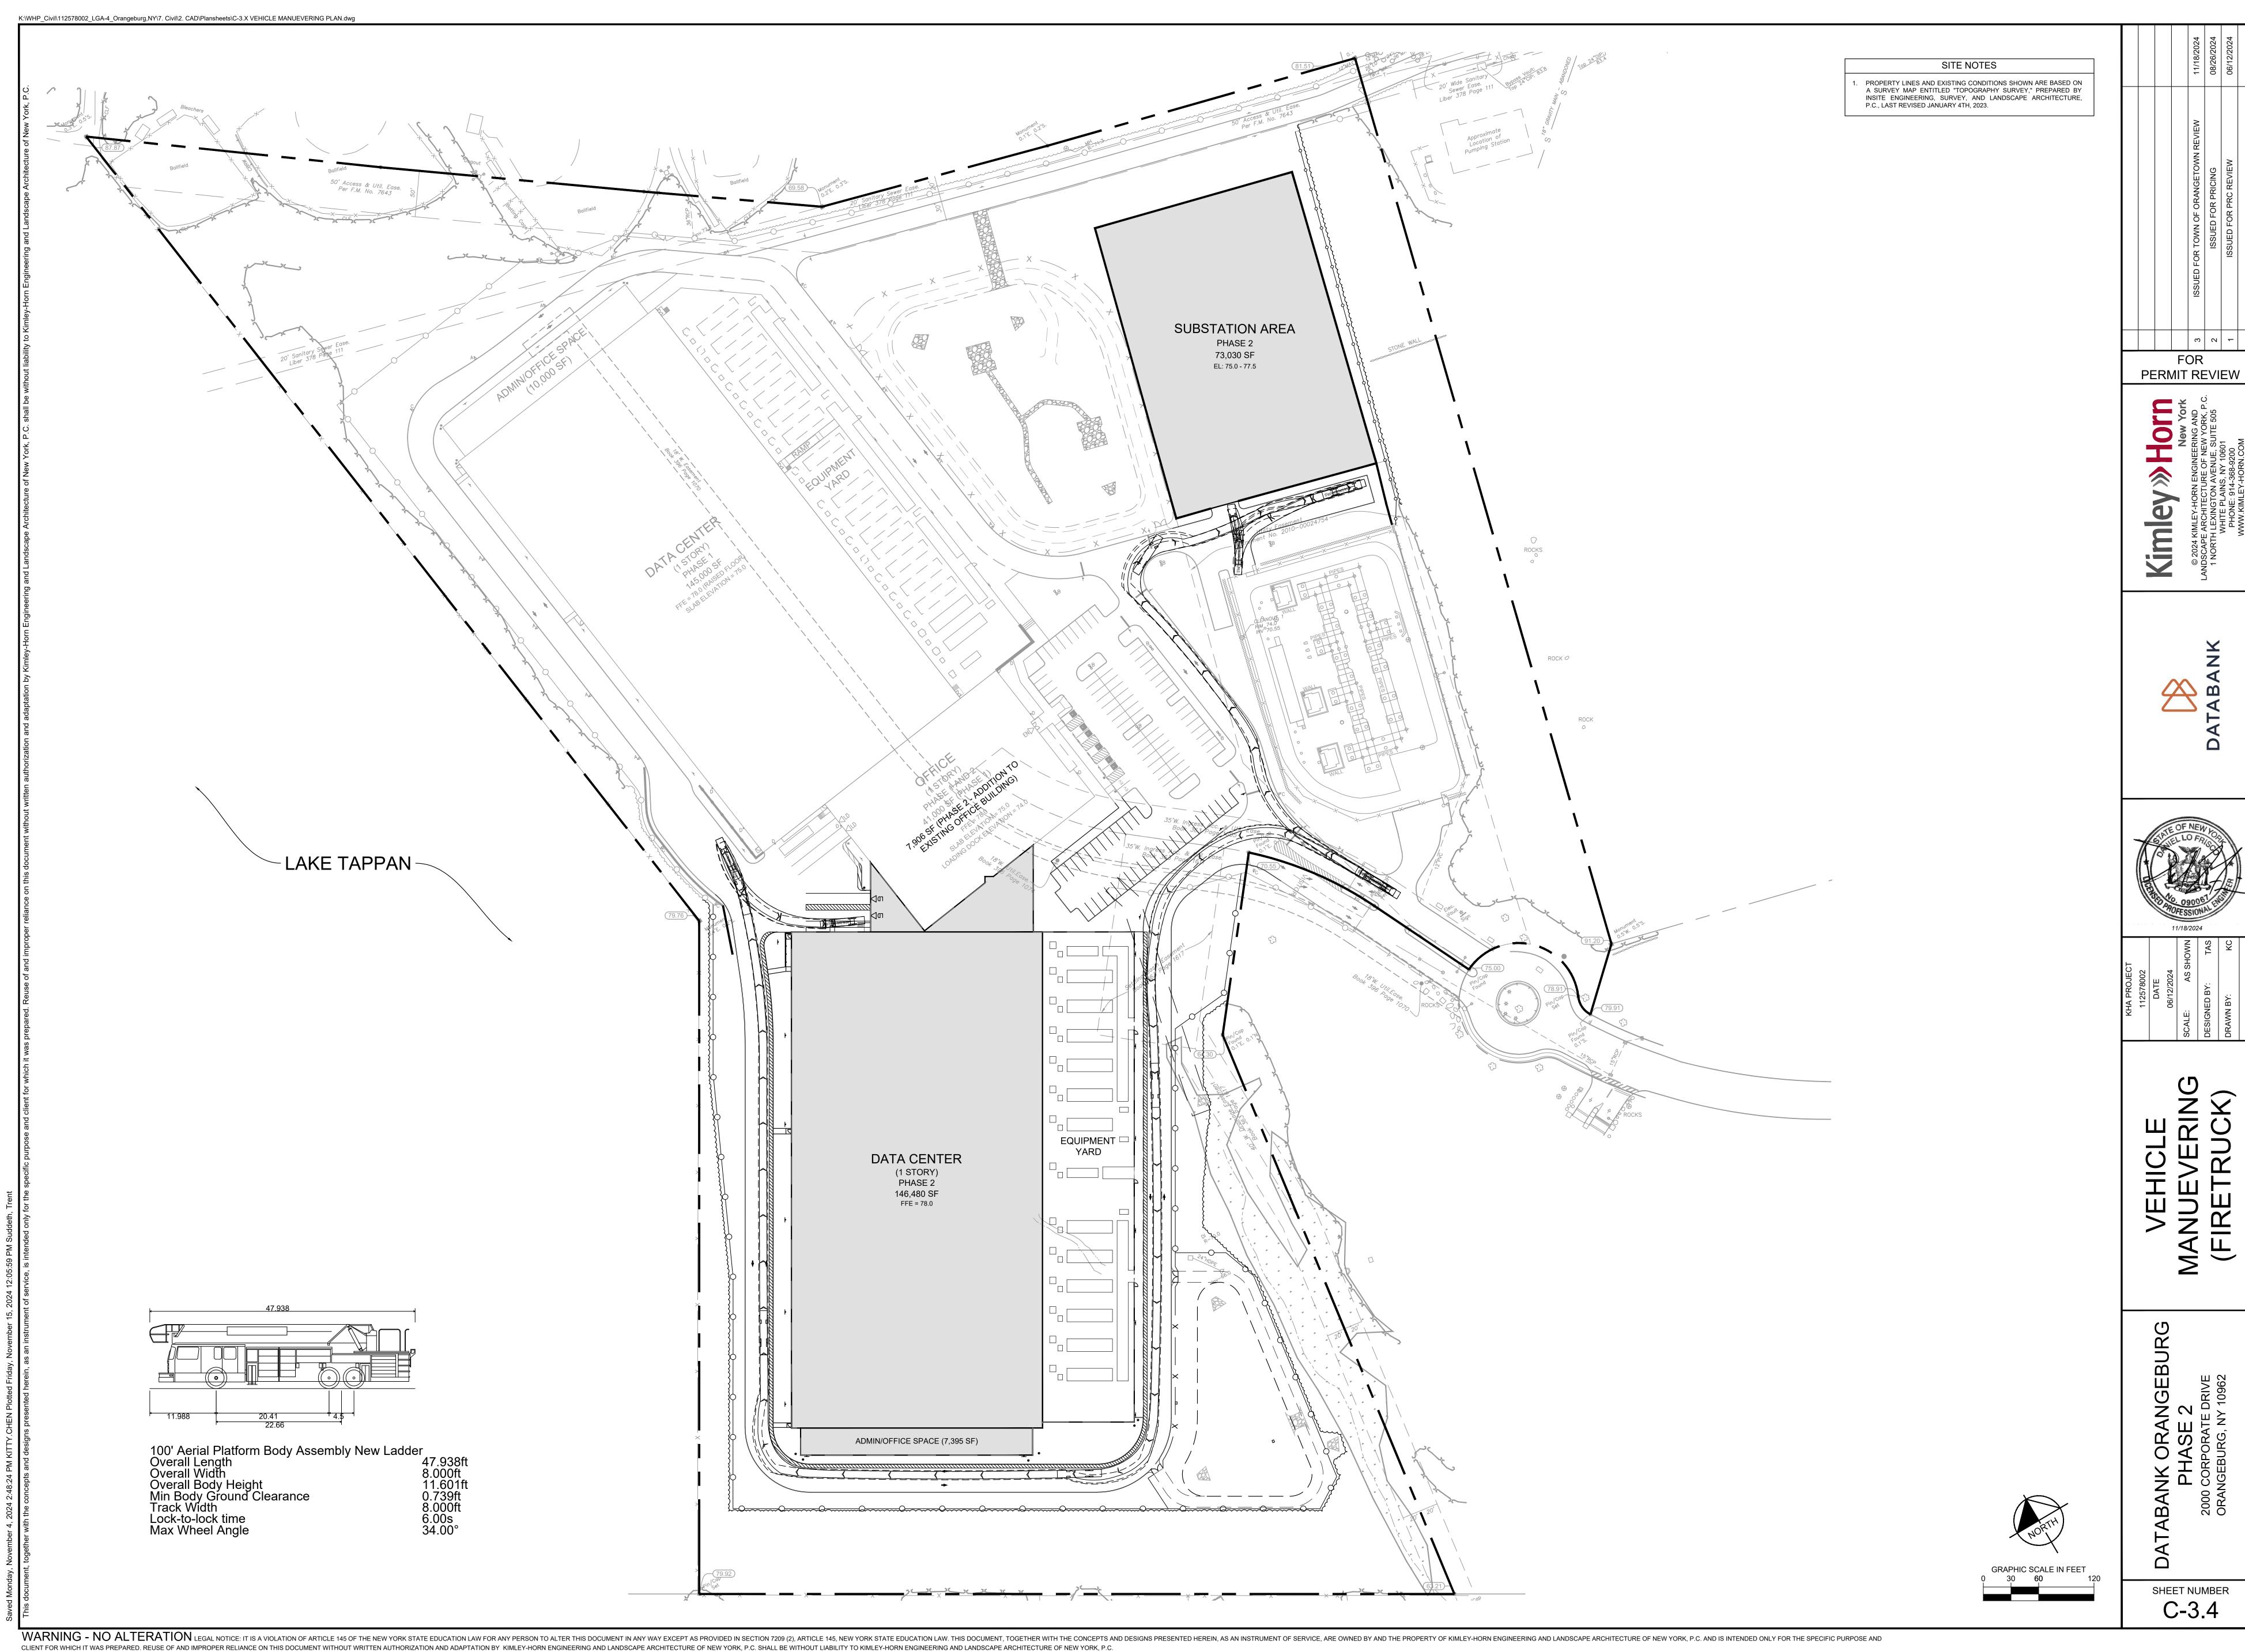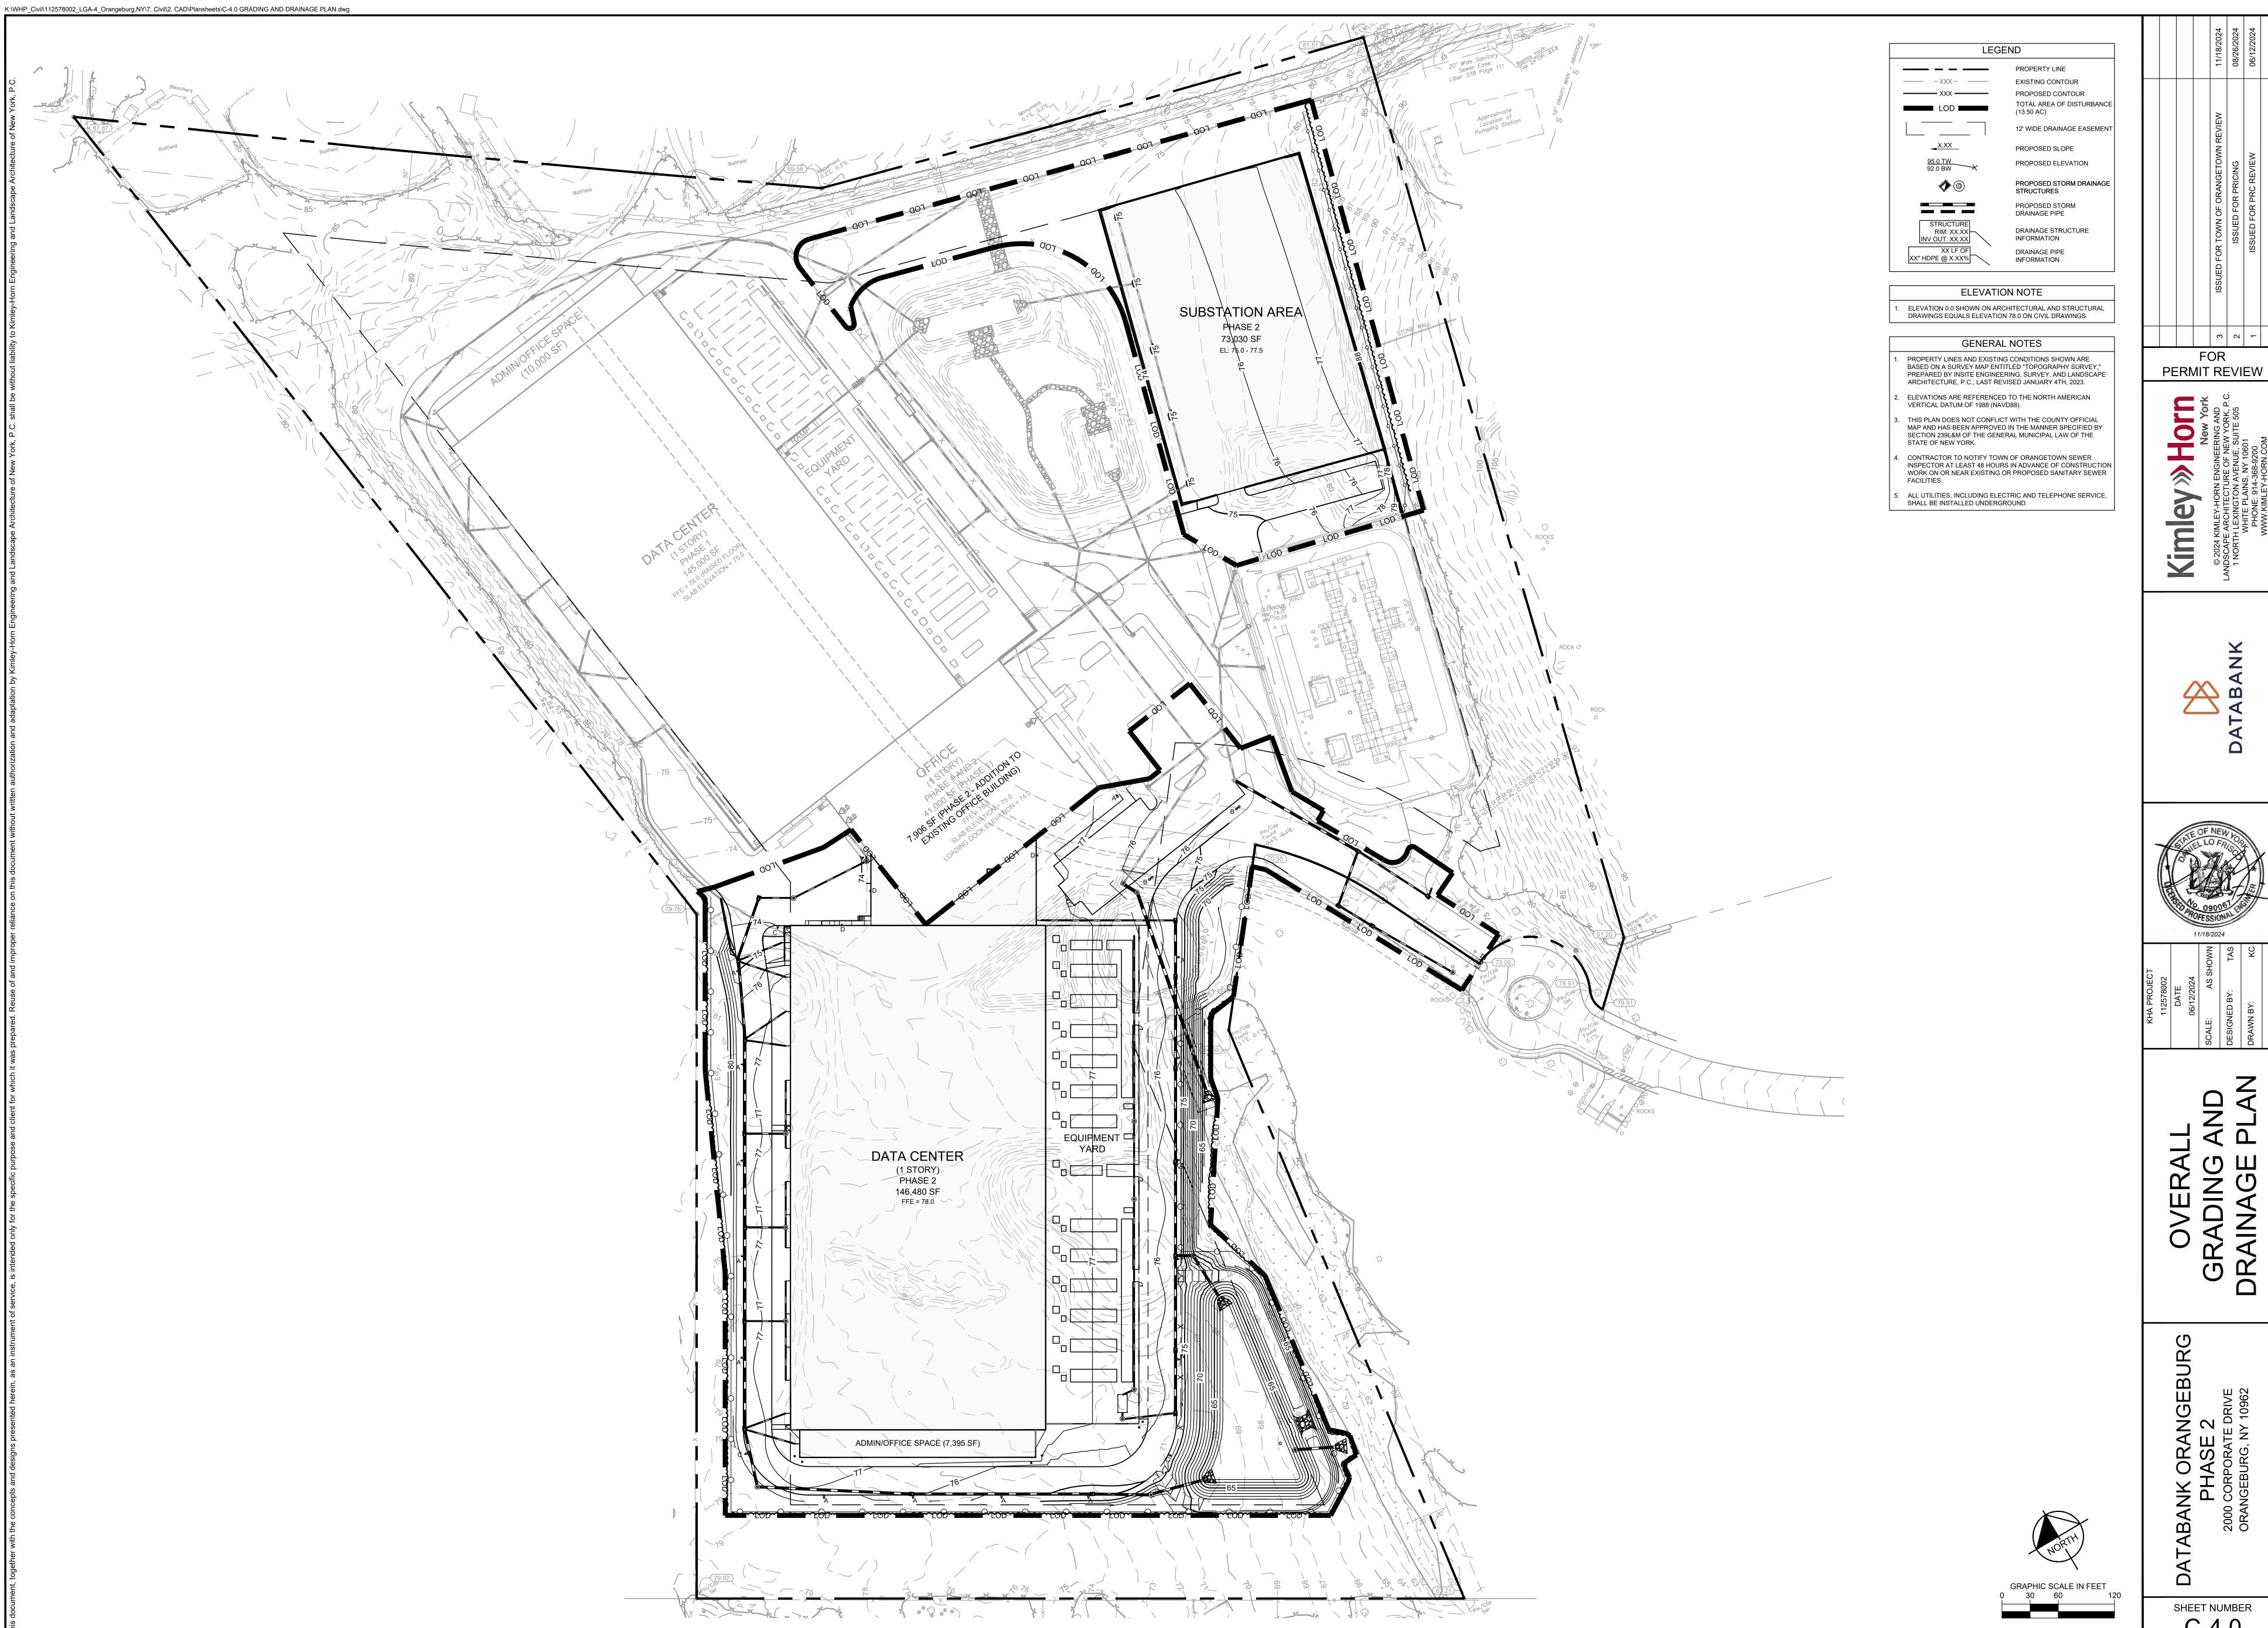GRAPHIC SCALE IN FEE

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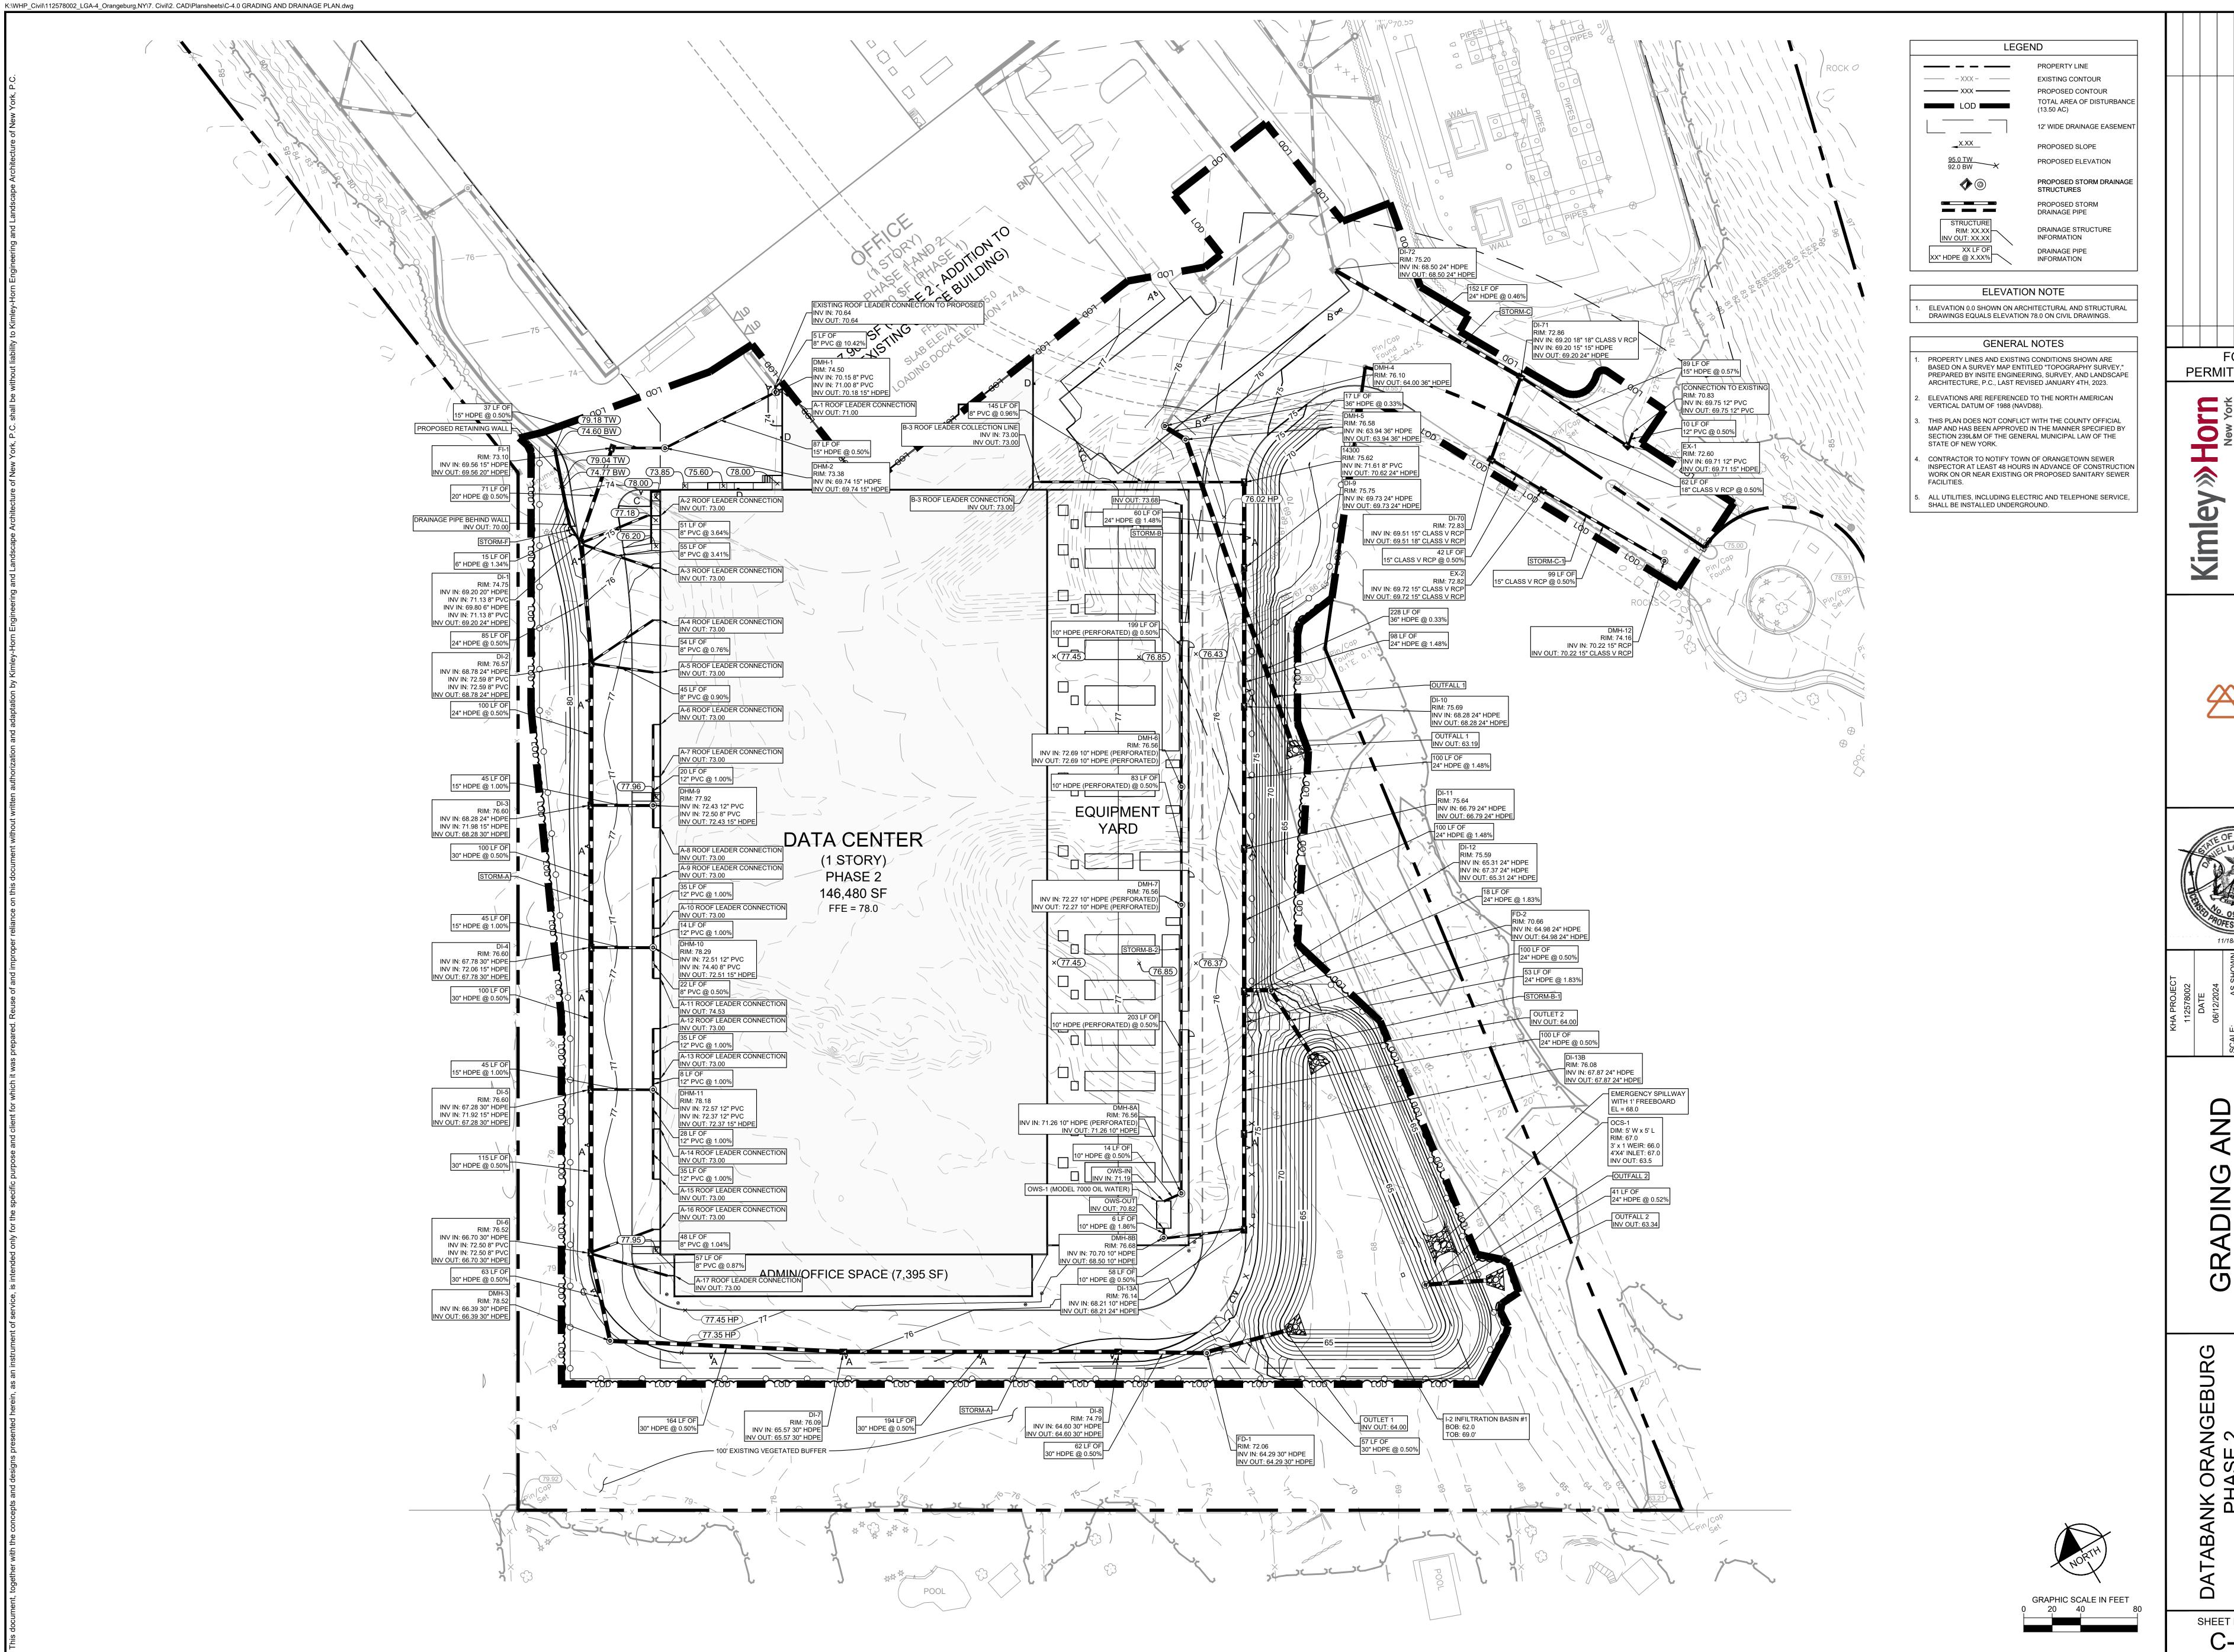






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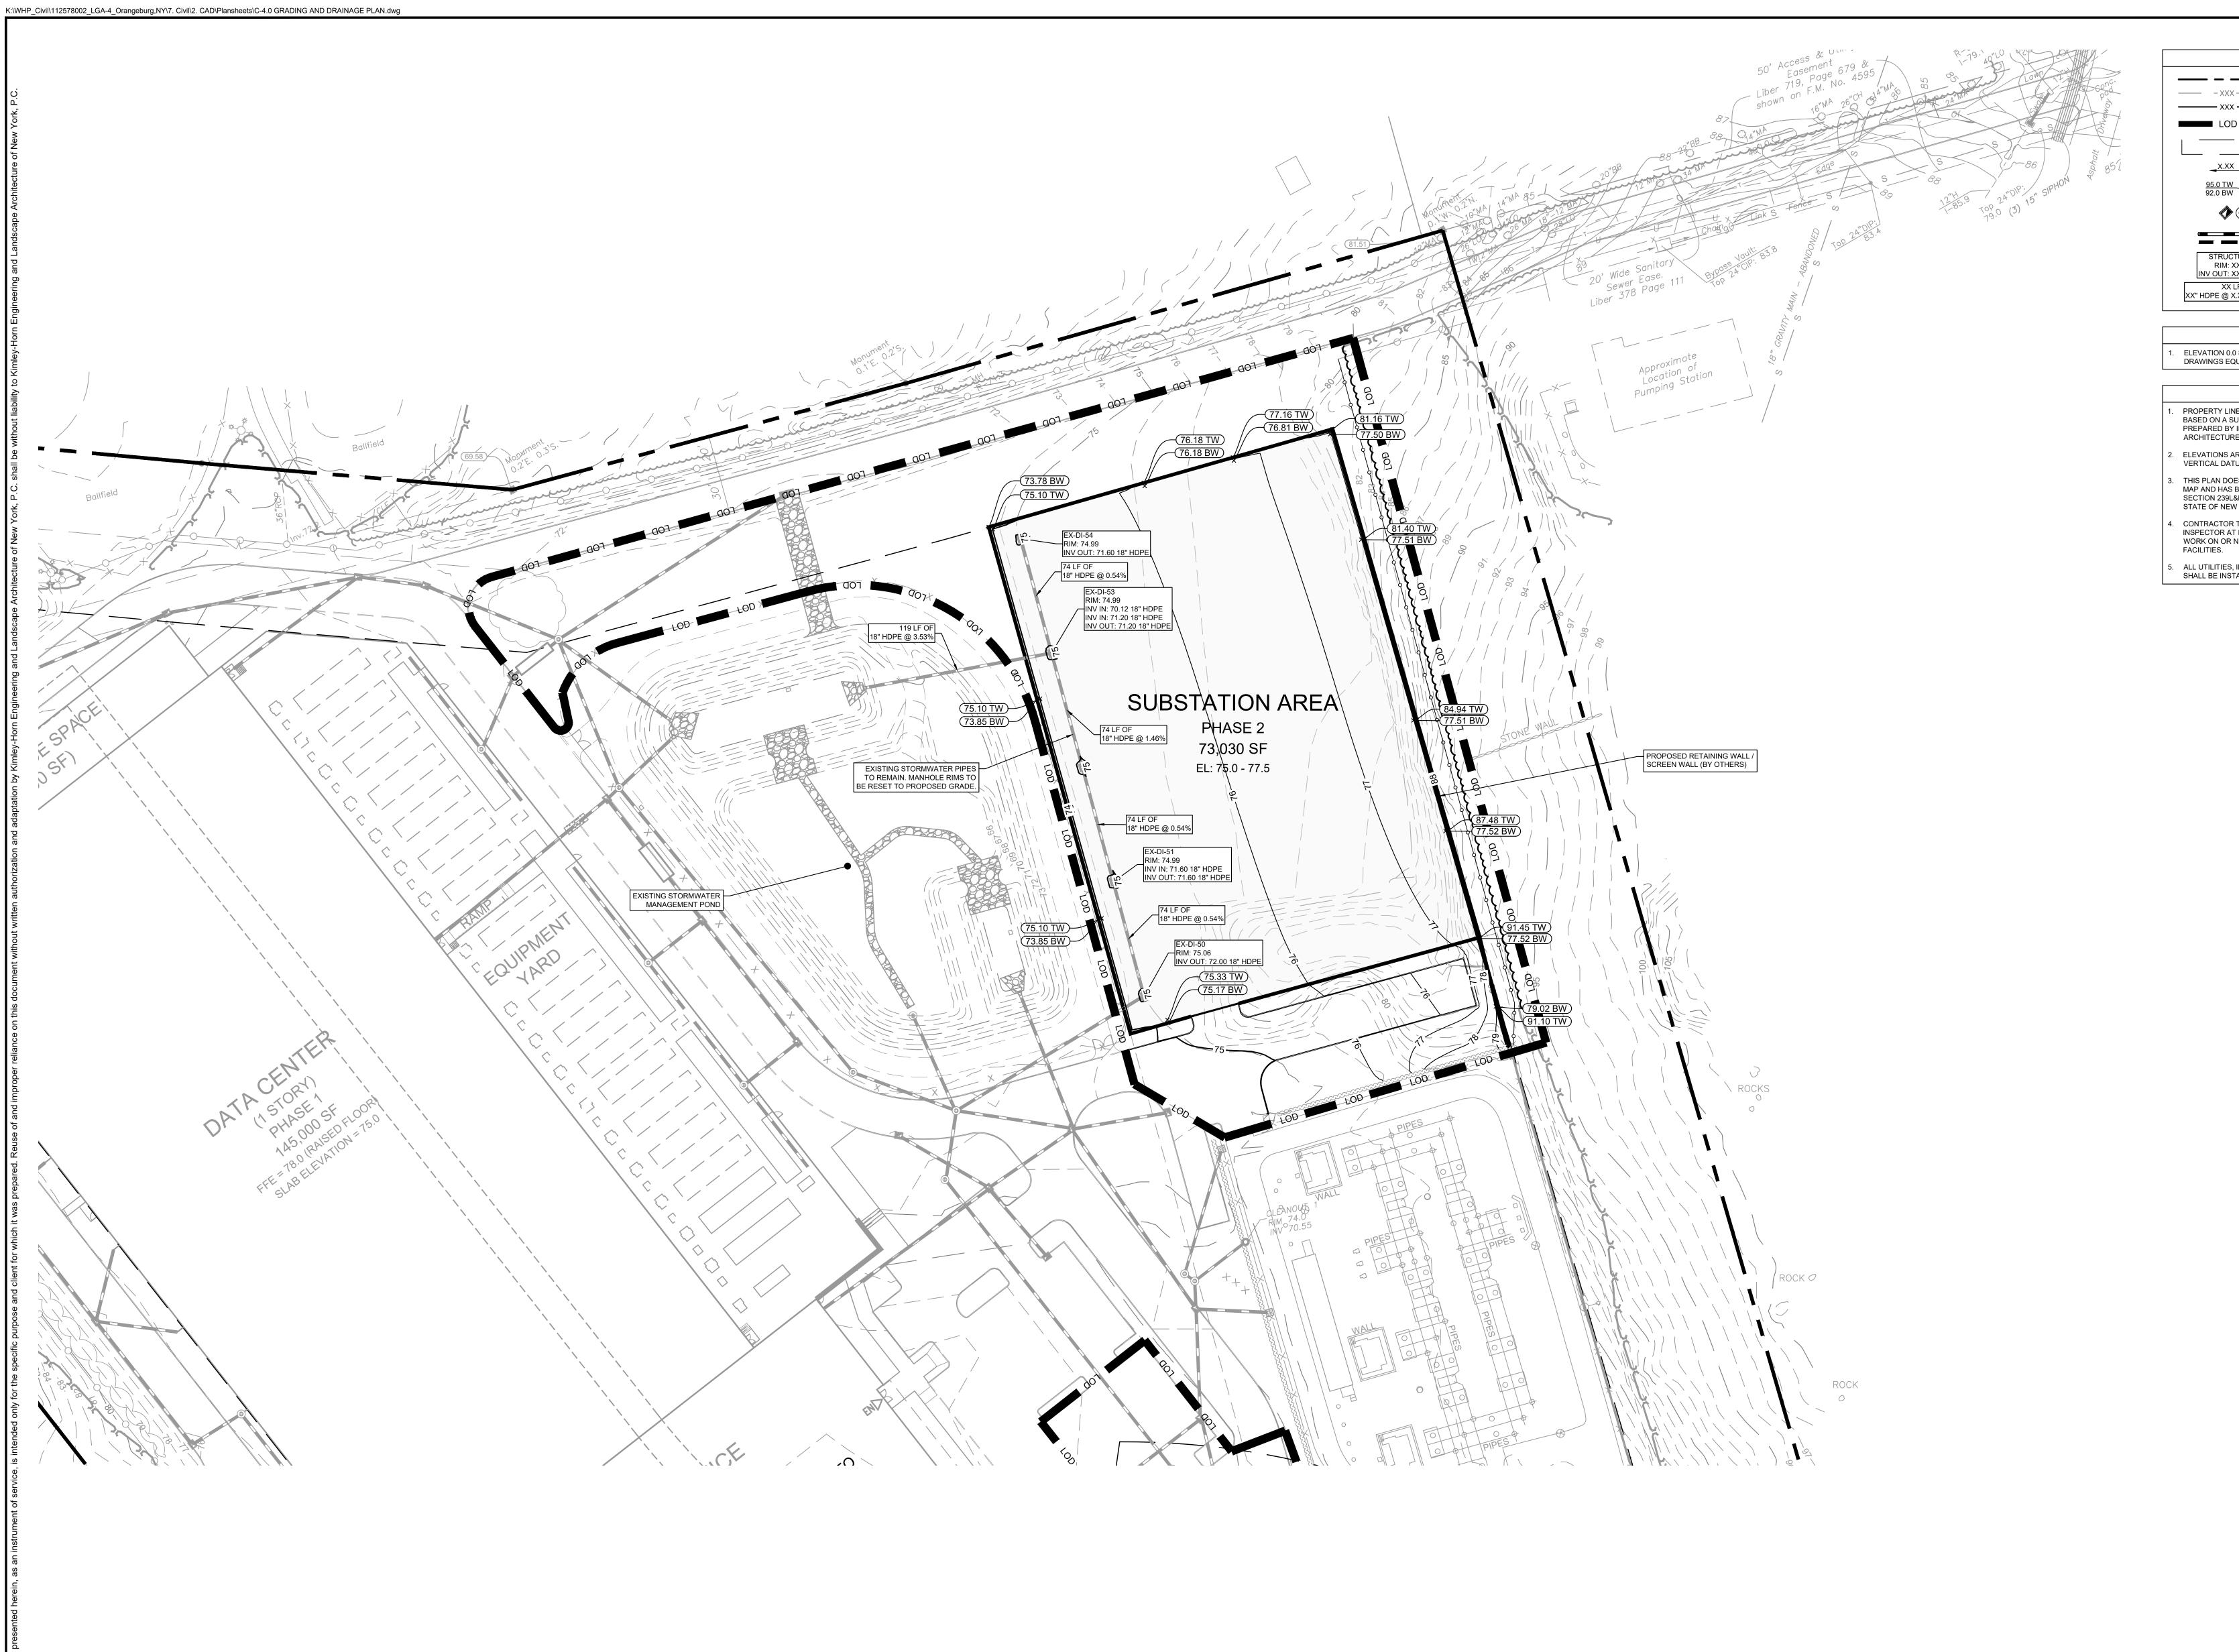
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PERMIT REVIEW



11/18/2024



LEGEND PROPERTY LINE ------**EXISTING CONTOUR** \_\_\_\_\_ xxx \_\_\_\_\_ PROPOSED CONTOUR TOTAL AREA OF DISTURBANCE 12' WIDE DRAINAGE EASEMENT PROPOSED SLOPE PROPOSED ELEVATION PROPOSED STORM DRAINAGE STRUCTURES PROPOSED STORM DRAINAGE PIPE STRUCTURE RIM: XX.XX INV OUT: XX.XX DRAINAGE STRUCTURE INFORMATION XX LF OF DRAINAGE PIPE XX" HDPE @ X.XX% INFORMATION

> **ELEVATION NOTE** I. ELEVATION 0.0 SHOWN ON ARCHITECTURAL AND STRUCTURAL DRAWINGS EQUALS ELEVATION 78.0 ON CIVIL DRAWINGS.

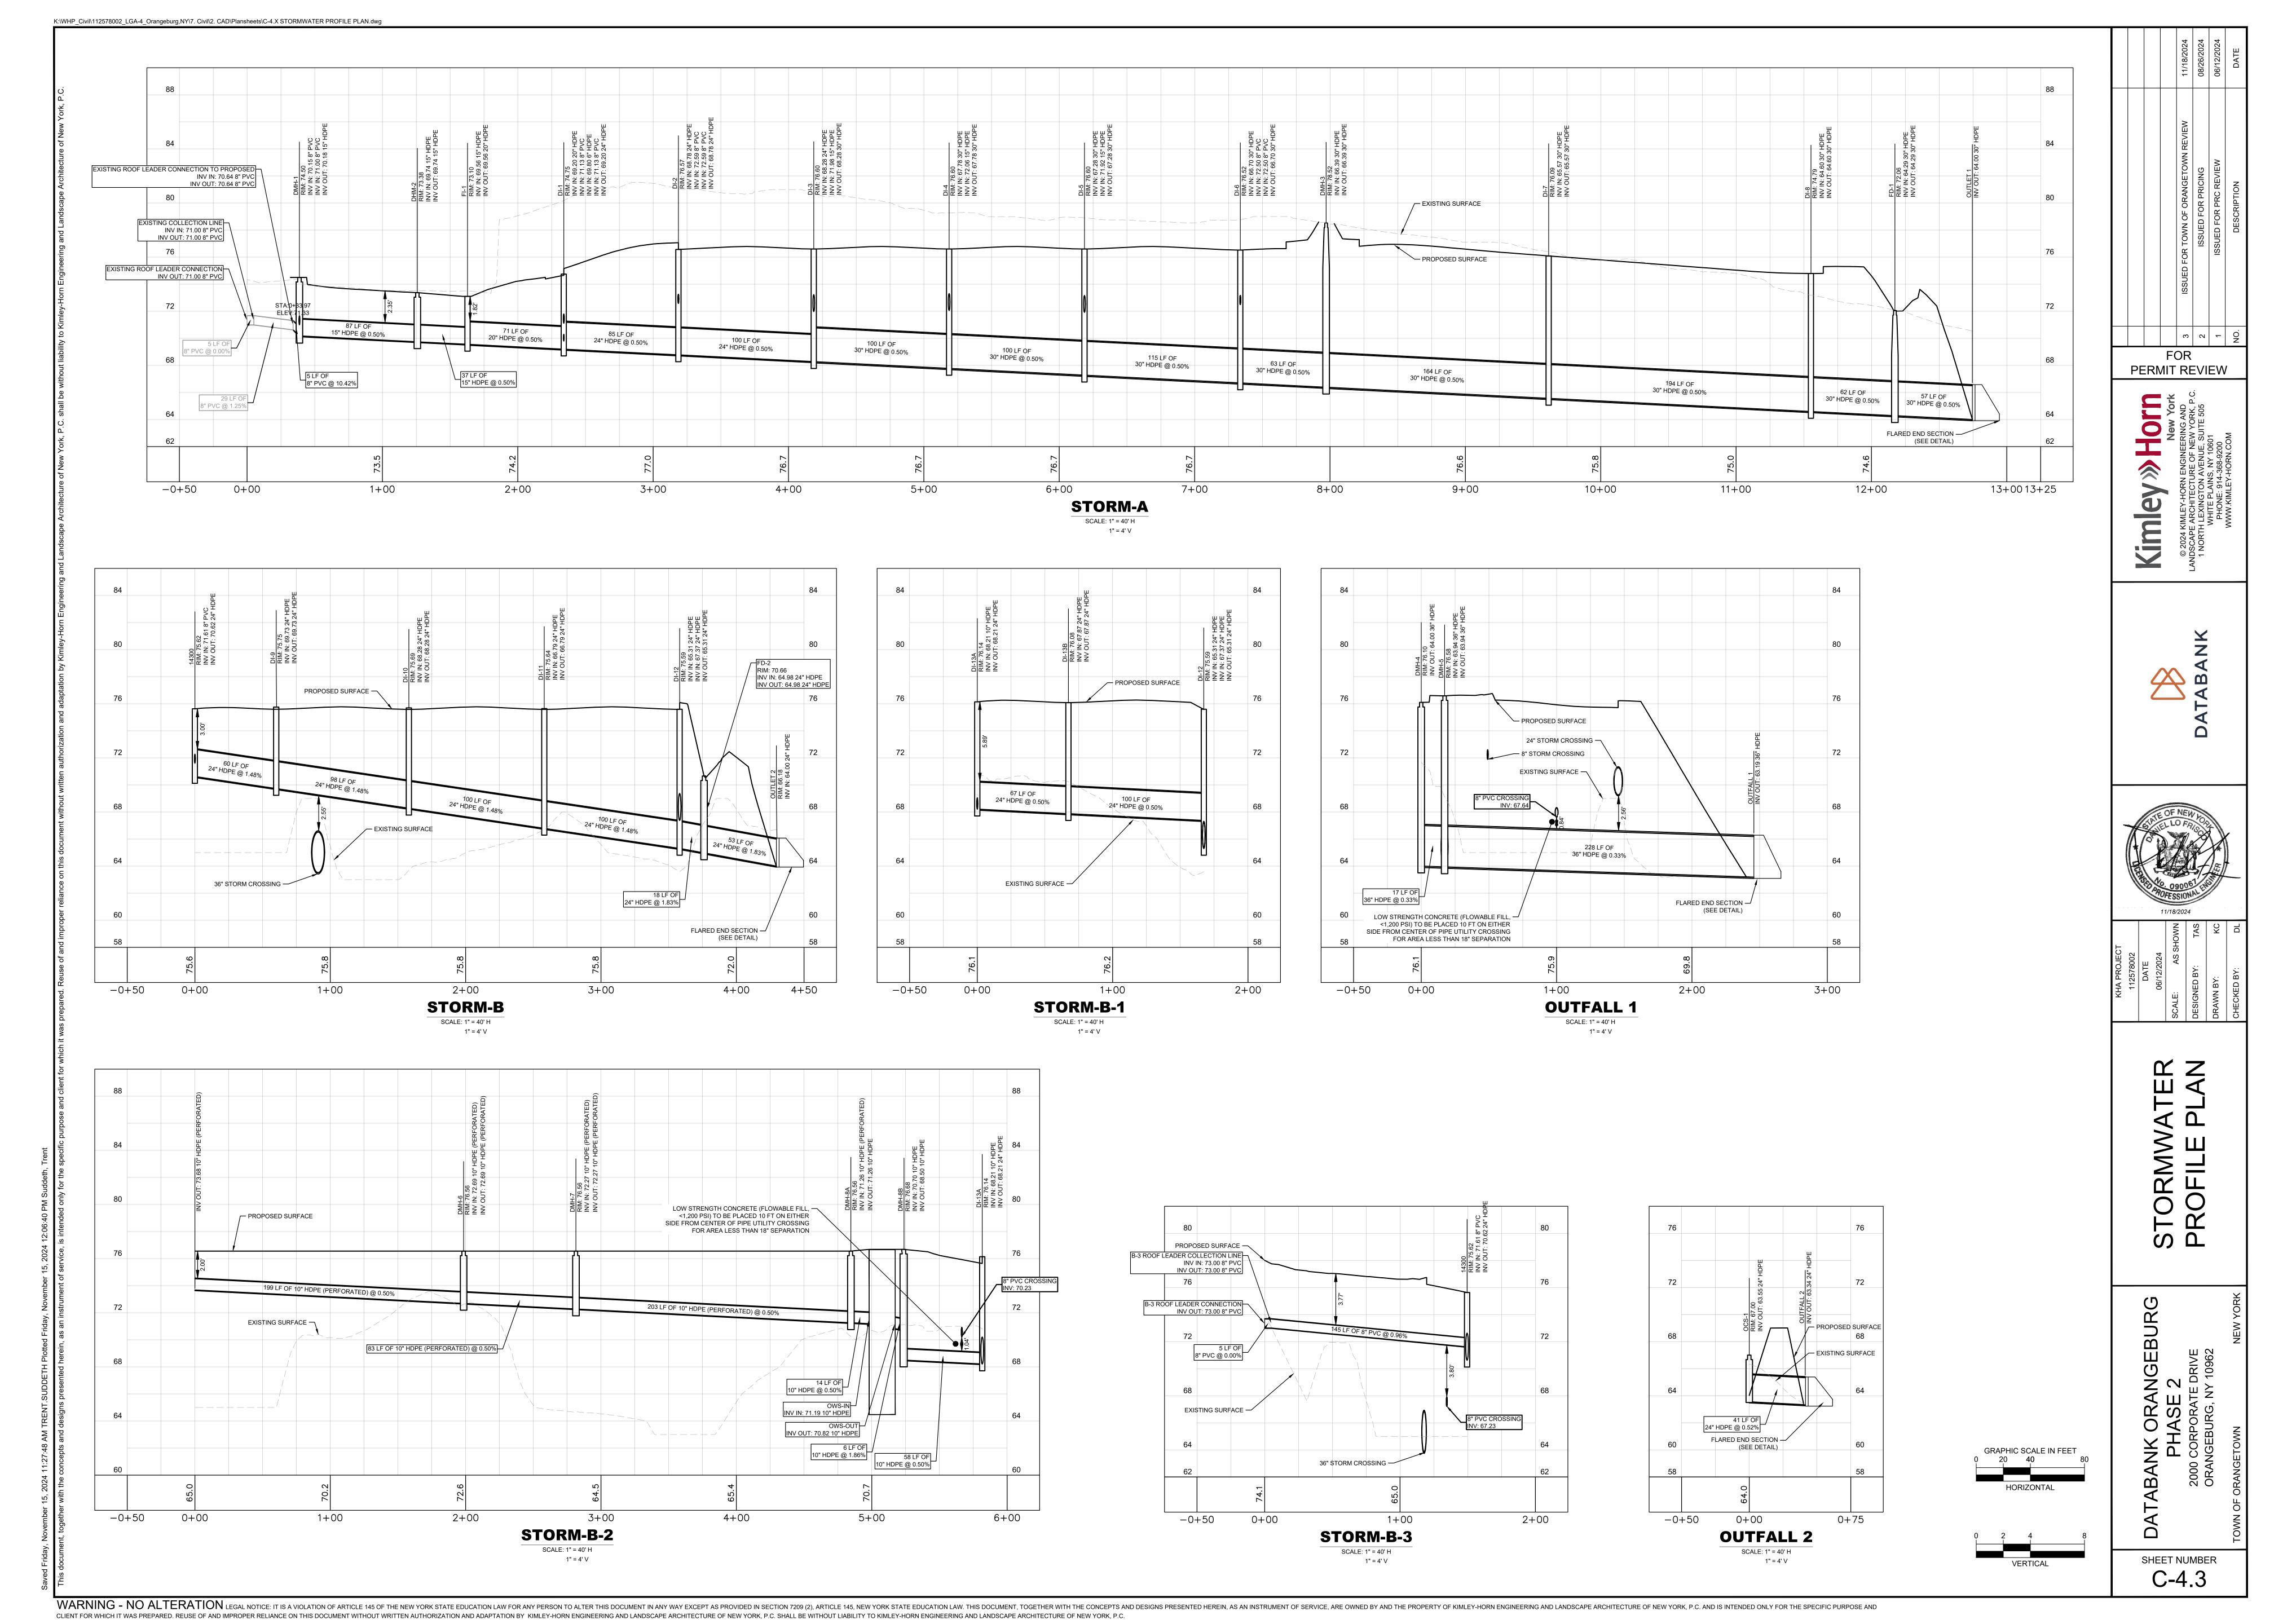
> GENERAL NOTES PROPERTY LINES AND EXISTING CONDITIONS SHOWN ARE BASED ON A SURVEY MAP ENTITLED "TOPOGRAPHY SURVEY," PREPARED BY INSITE ENGINEERING, SURVEY, AND LANDSCAPE ARCHITECTURE, P.C., LAST REVISED JANUARY 4TH, 2023.

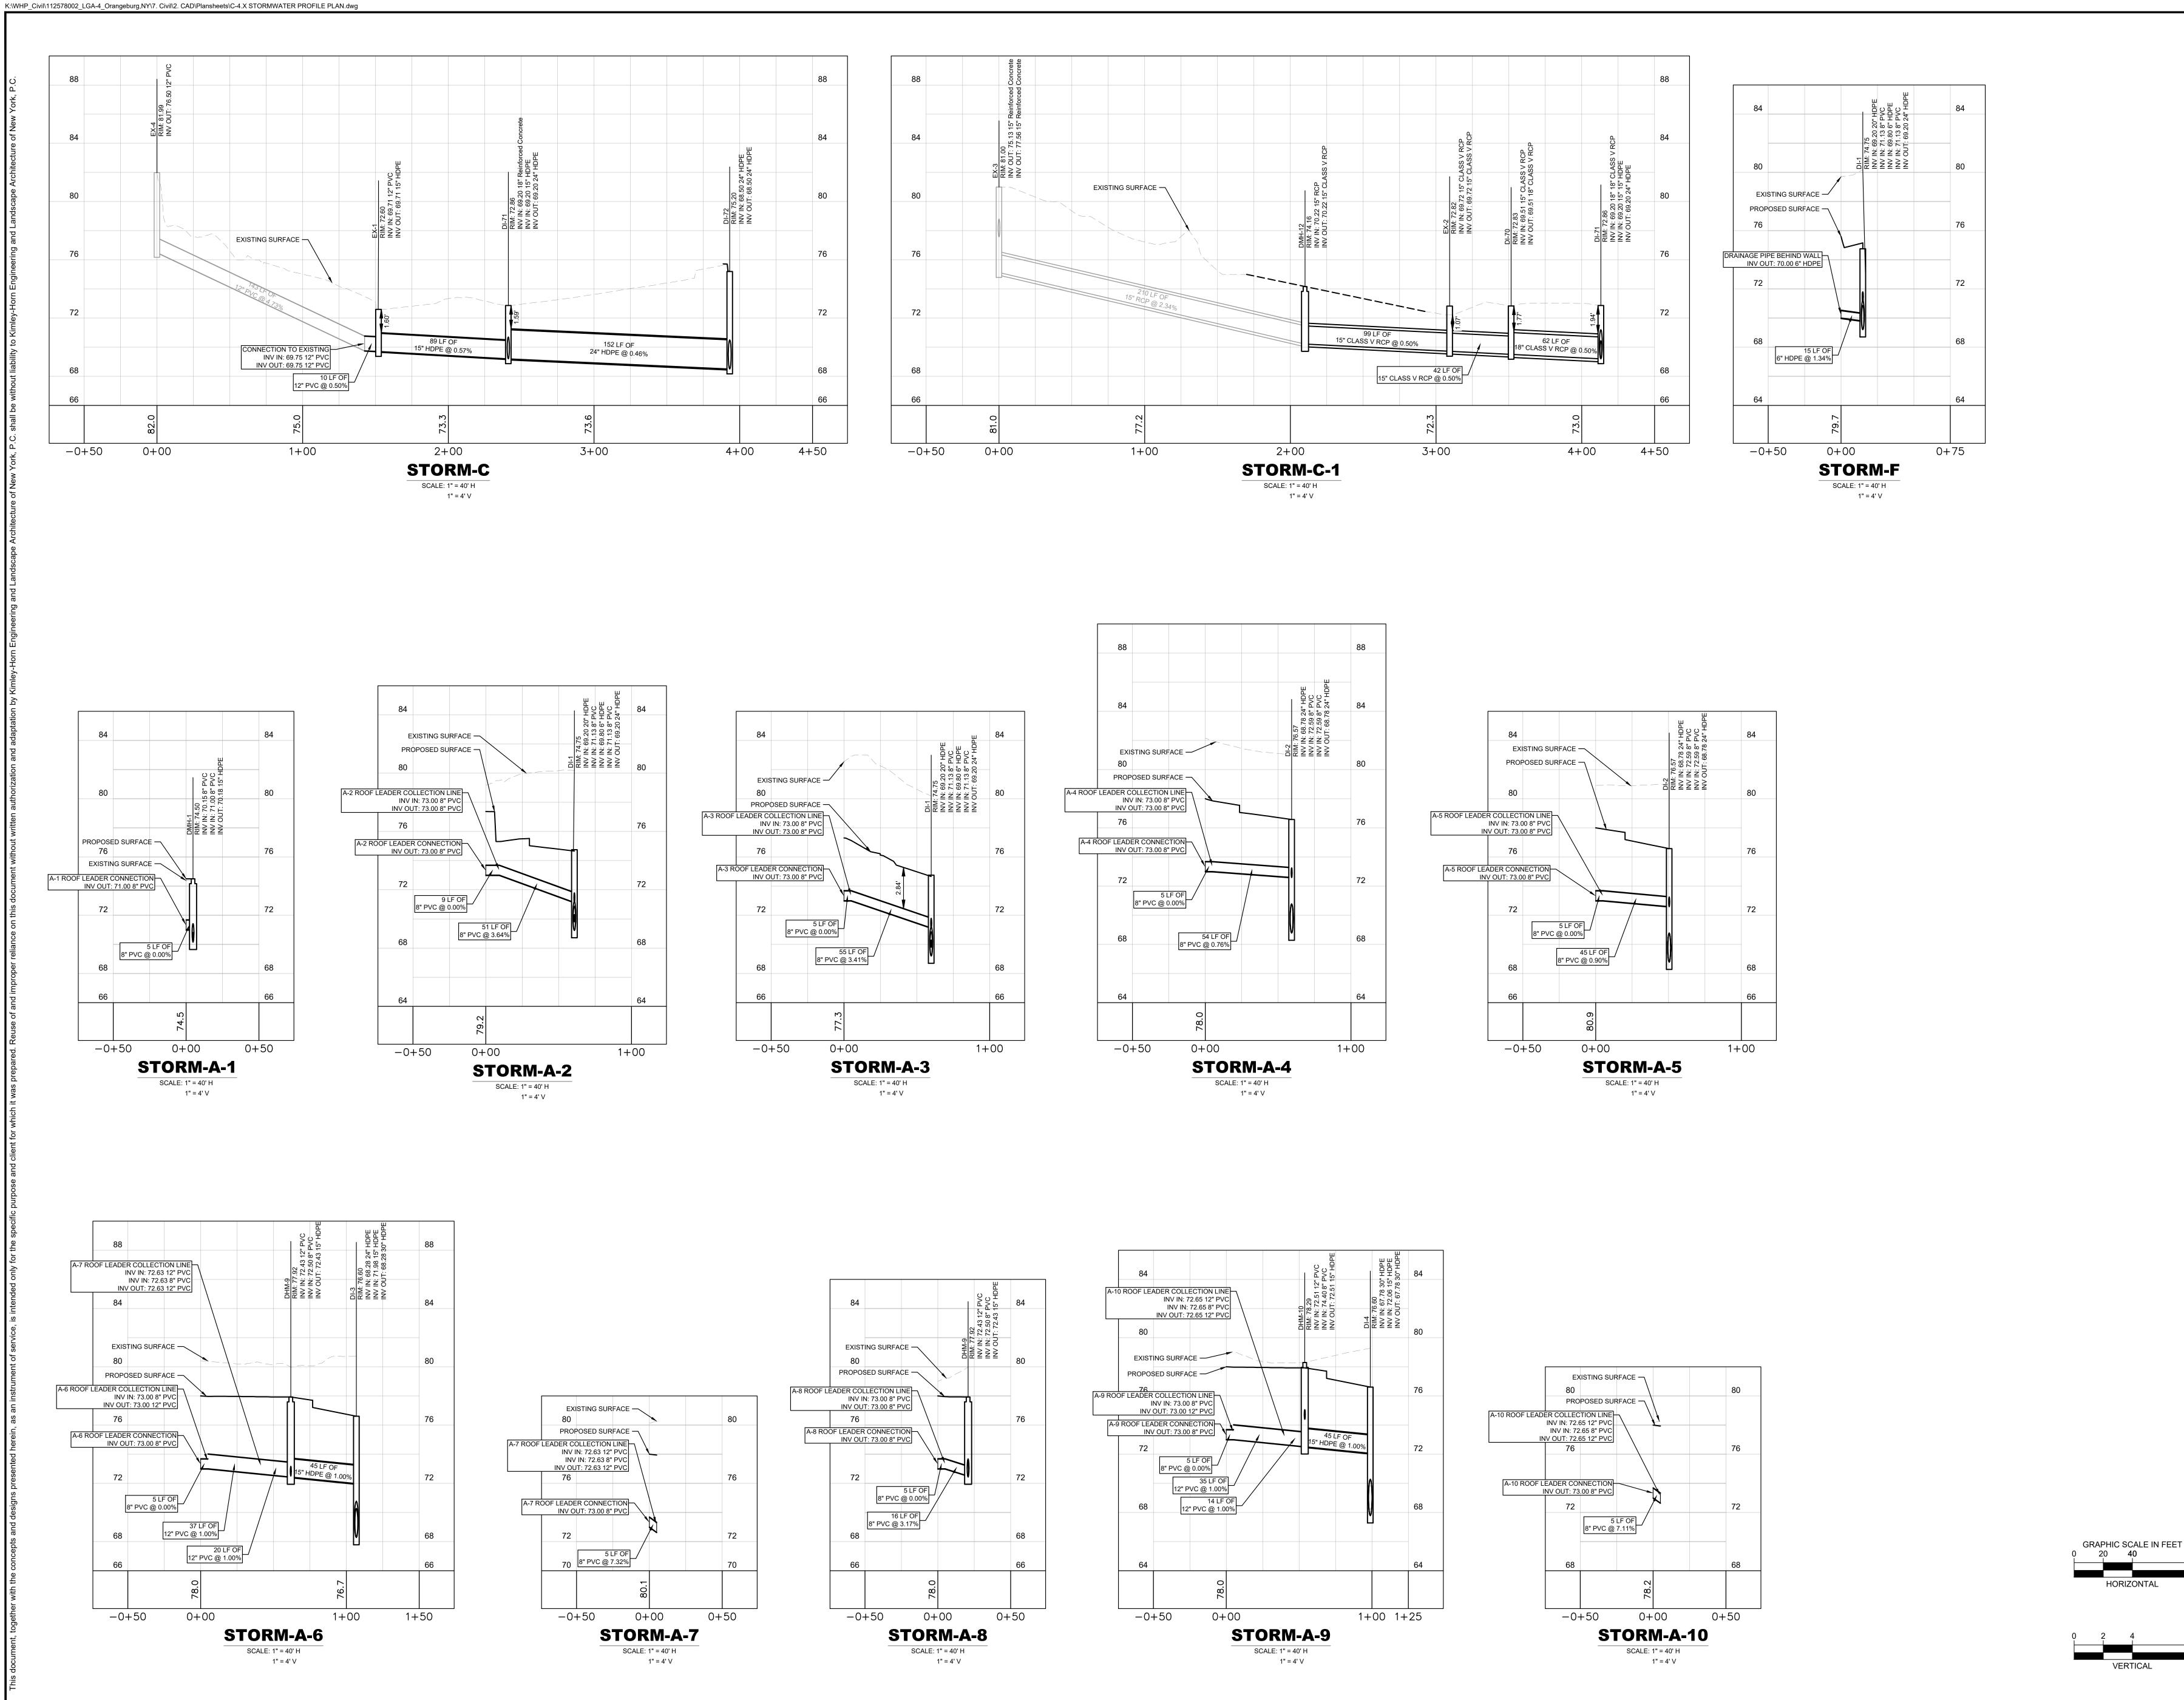
- . ELEVATIONS ARE REFERENCED TO THE NORTH AMERICAN VERTICAL DATUM OF 1988 (NAVD88). 3. THIS PLAN DOES NOT CONFLICT WITH THE COUNTY OFFICIAL MAP AND HAS BEEN APPROVED IN THE MANNER SPECIFIED BY SECTION 239L&M OF THE GENERAL MUNICIPAL LAW OF THE
- STATE OF NEW YORK. I. CONTRACTOR TO NOTIFY TOWN OF ORANGETOWN SEWER INSPECTOR AT LEAST 48 HOURS IN ADVANCE OF CONSTRUCTION WORK ON OR NEAR EXISTING OR PROPOSED SANITARY SEWER
- ALL UTILITIES, INCLUDING ELECTRIC AND TELEPHONE SERVICE, SHALL BE INSTALLED UNDERGROUND.

PERMIT REVIEW



SHEET NUMBER





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PERMIT REVIEW

Kimley





STORMW/ PROFILE

ABANK ORA
PHASE
2000 CORPORAT
ORANGEBURG,

HORIZONTAL SHEET NUMBER C-4.4

0+50

-0+50

0+00

STORM-A-14

SCALE: 1" = 40' H

1" = 4' V

0+50

-0+50

0+00

STORM-A-15

1" = 4' V

1+00

-0+50

0+00

STORM-A-16

SCALE: 1" = 40' H

1" = 4' V

1+00

-0+50

0+00

STORM-A-12

1" = 4' V

1+00 1+25

-0+50

0+00

STORM-A-13

SCALE: 1" = 40' H

1" = 4' V

1+00

-0+50

0+00

STORM-A-11

SCALE: 1" = 40' H

1" = 4' V

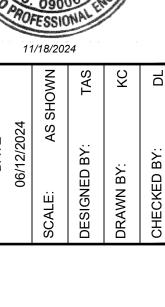


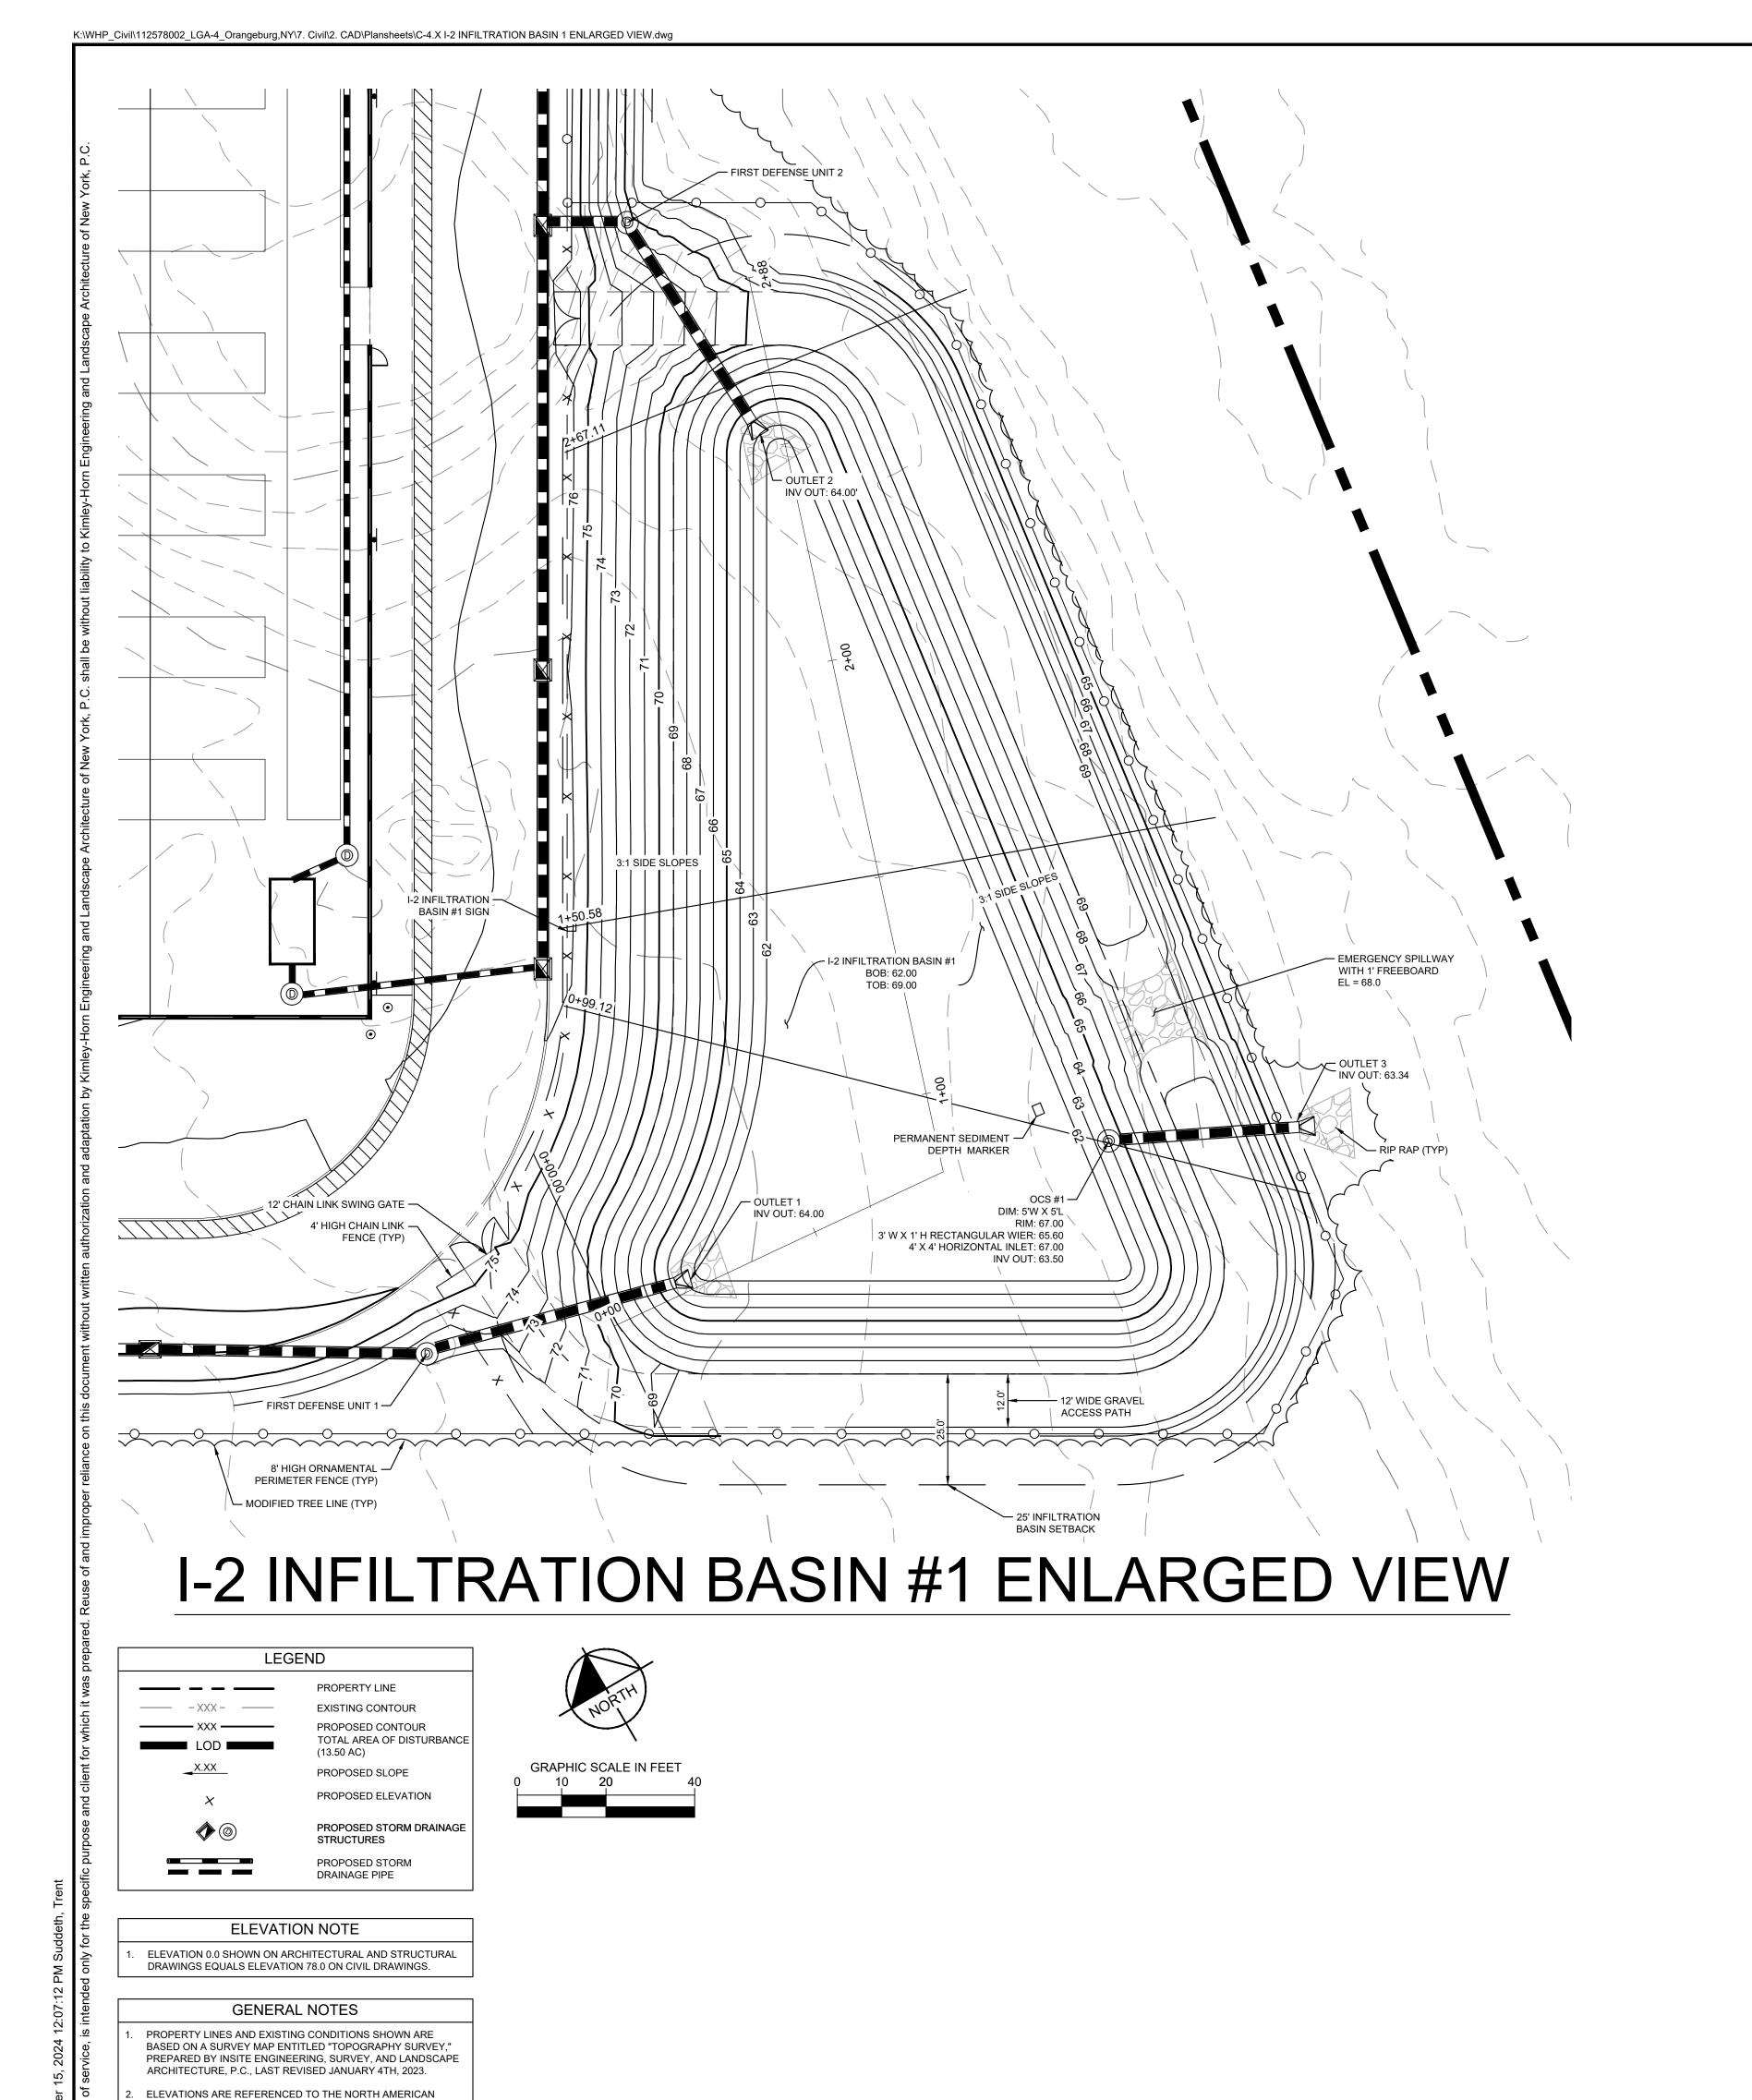
PERMIT REVIEW

New York
RN ENGINEERING AND
STURE OF NEW YORK, P.C.
NA AVENUE, SUITE 505

Kimley





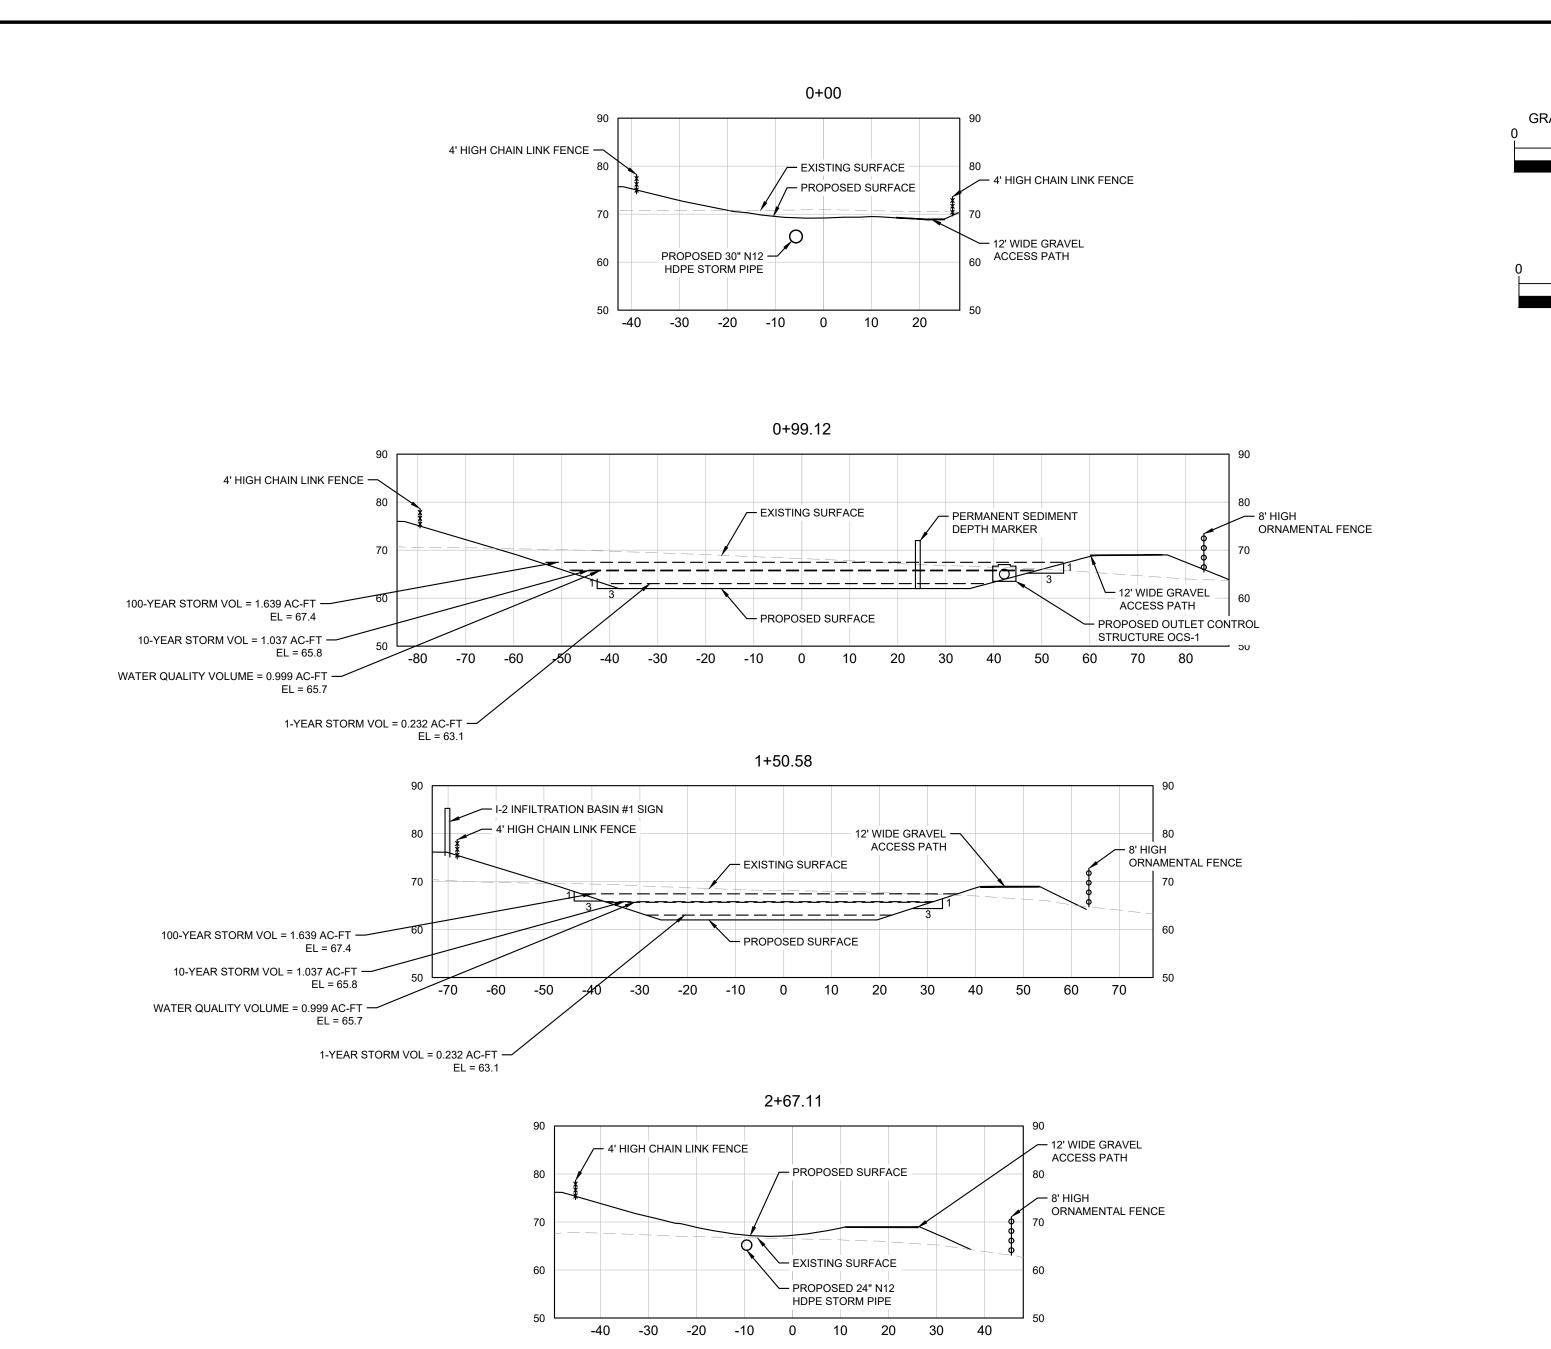


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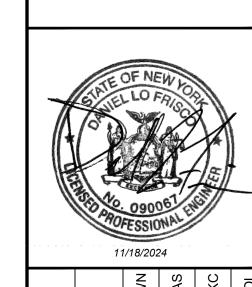
CONTRACTOR TO NOTIFY TOWN OF ORANGETOWN SEWER INSPECTOR AT LEAST 48 HOURS IN ADVANCE OF CONSTRUCTION

ALL UTILITIES, INCLUDING ELECTRIC AND TELEPHONE SERVICE,

SHALL BE INSTALLED UNDERGROUND.



I-2 INFILTRATION BASIN #1 CROSS SECTIONS



PERMIT REVIEW

HORIZONTAL

112578002

DATE

06/12/2024

SCALE: AS SHOWN

DESIGNED BY: TAS

DRAWN BY: KC

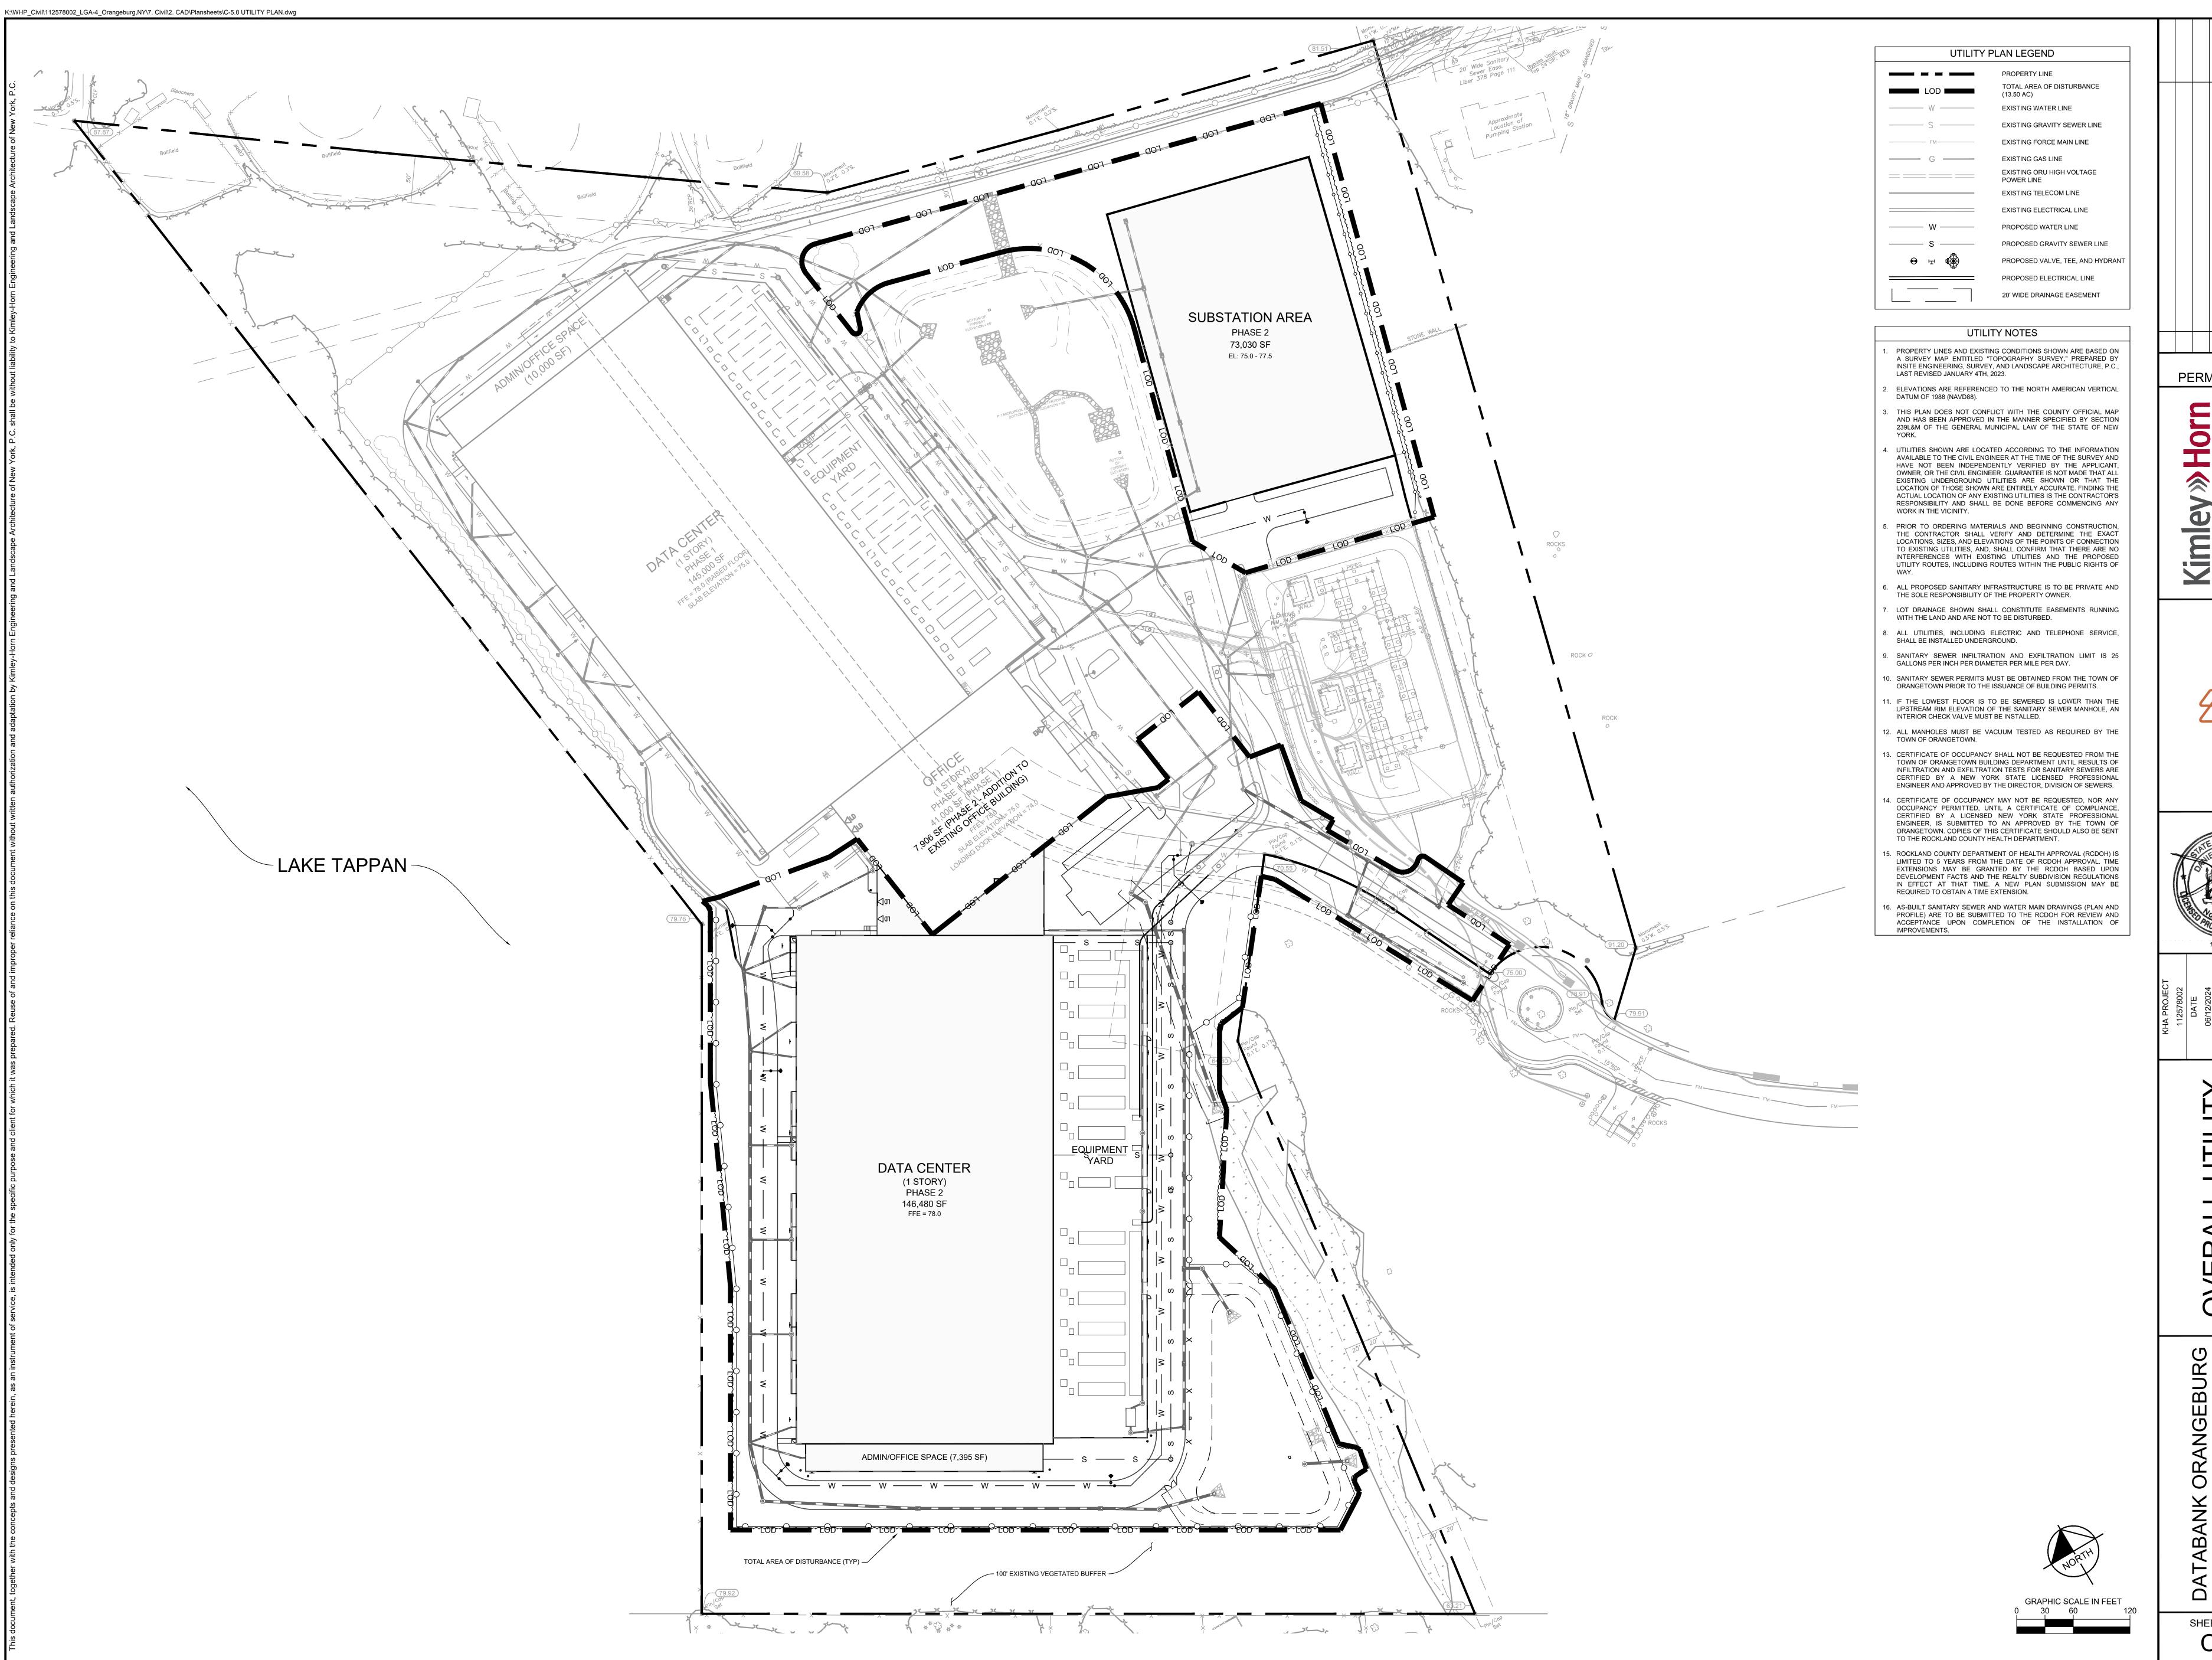
INFILTRATION
BASIN
ENLARGED VIEW

DAIABANK OKANGEBUK
PHASE 2
2000 CORPORATE DRIVE
ORANGEBURG, NY 10962
TOWN OF ORANGETOWN

SHEET NUMBER

C-4.6

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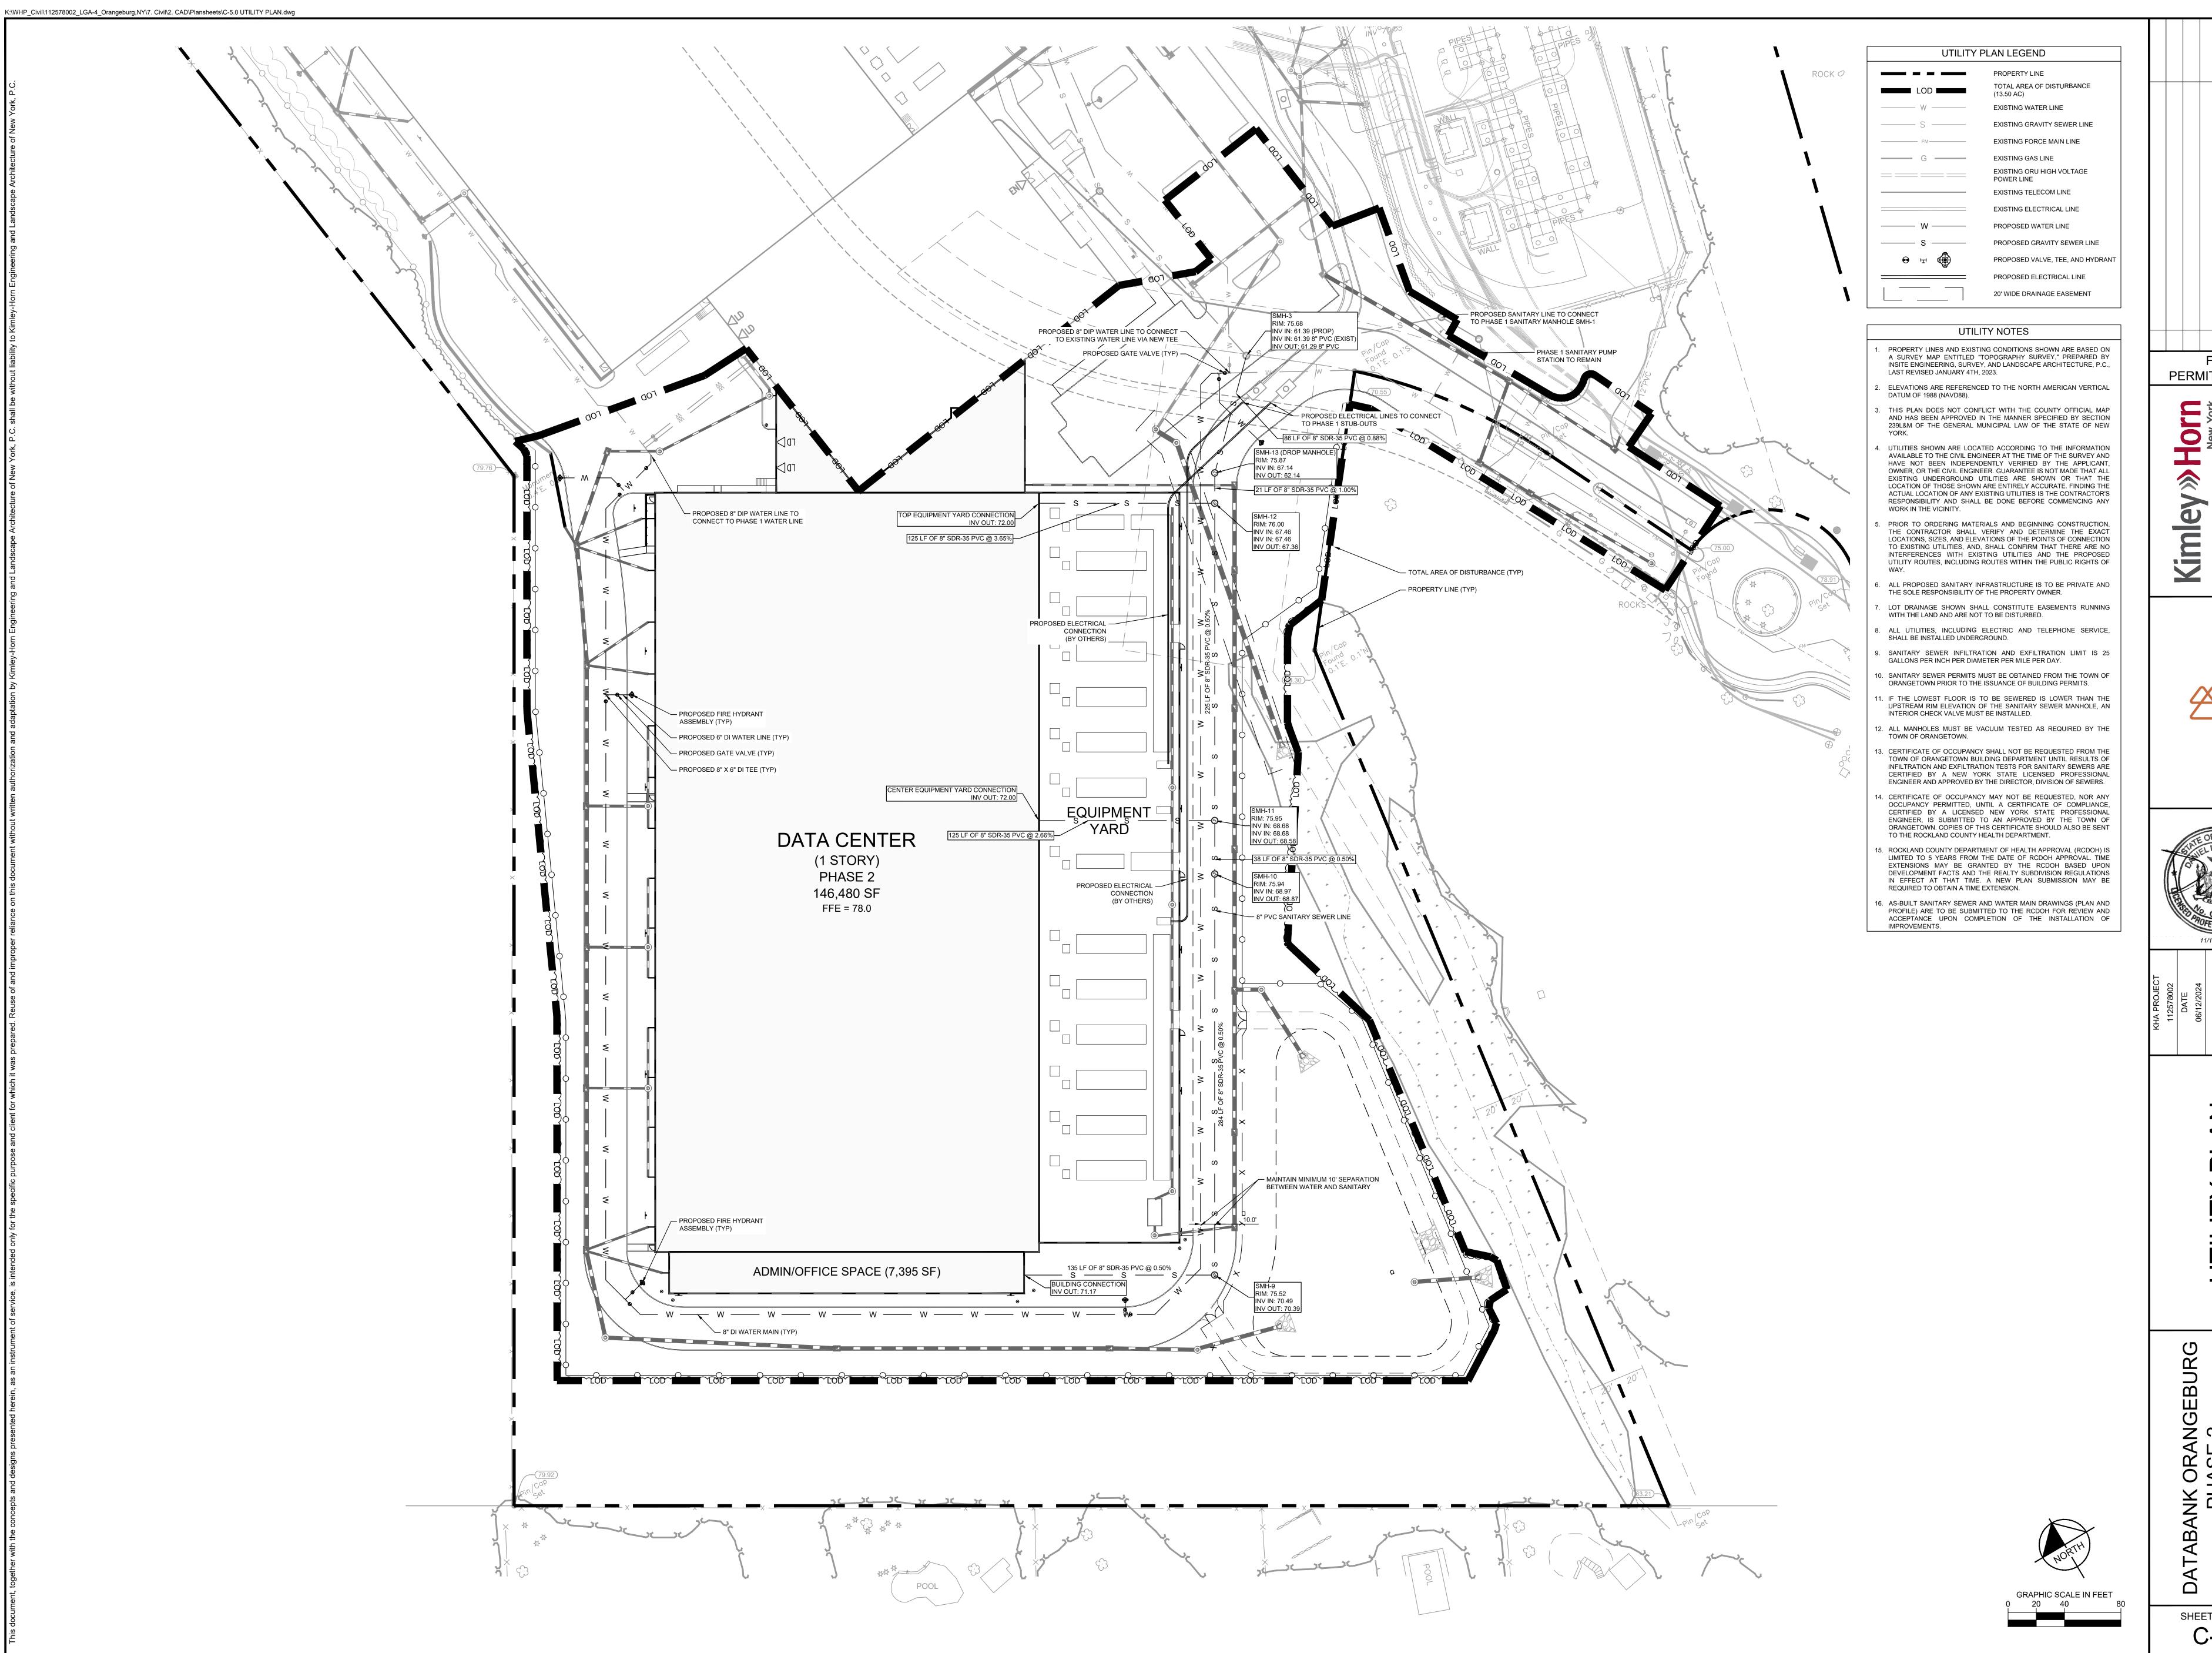


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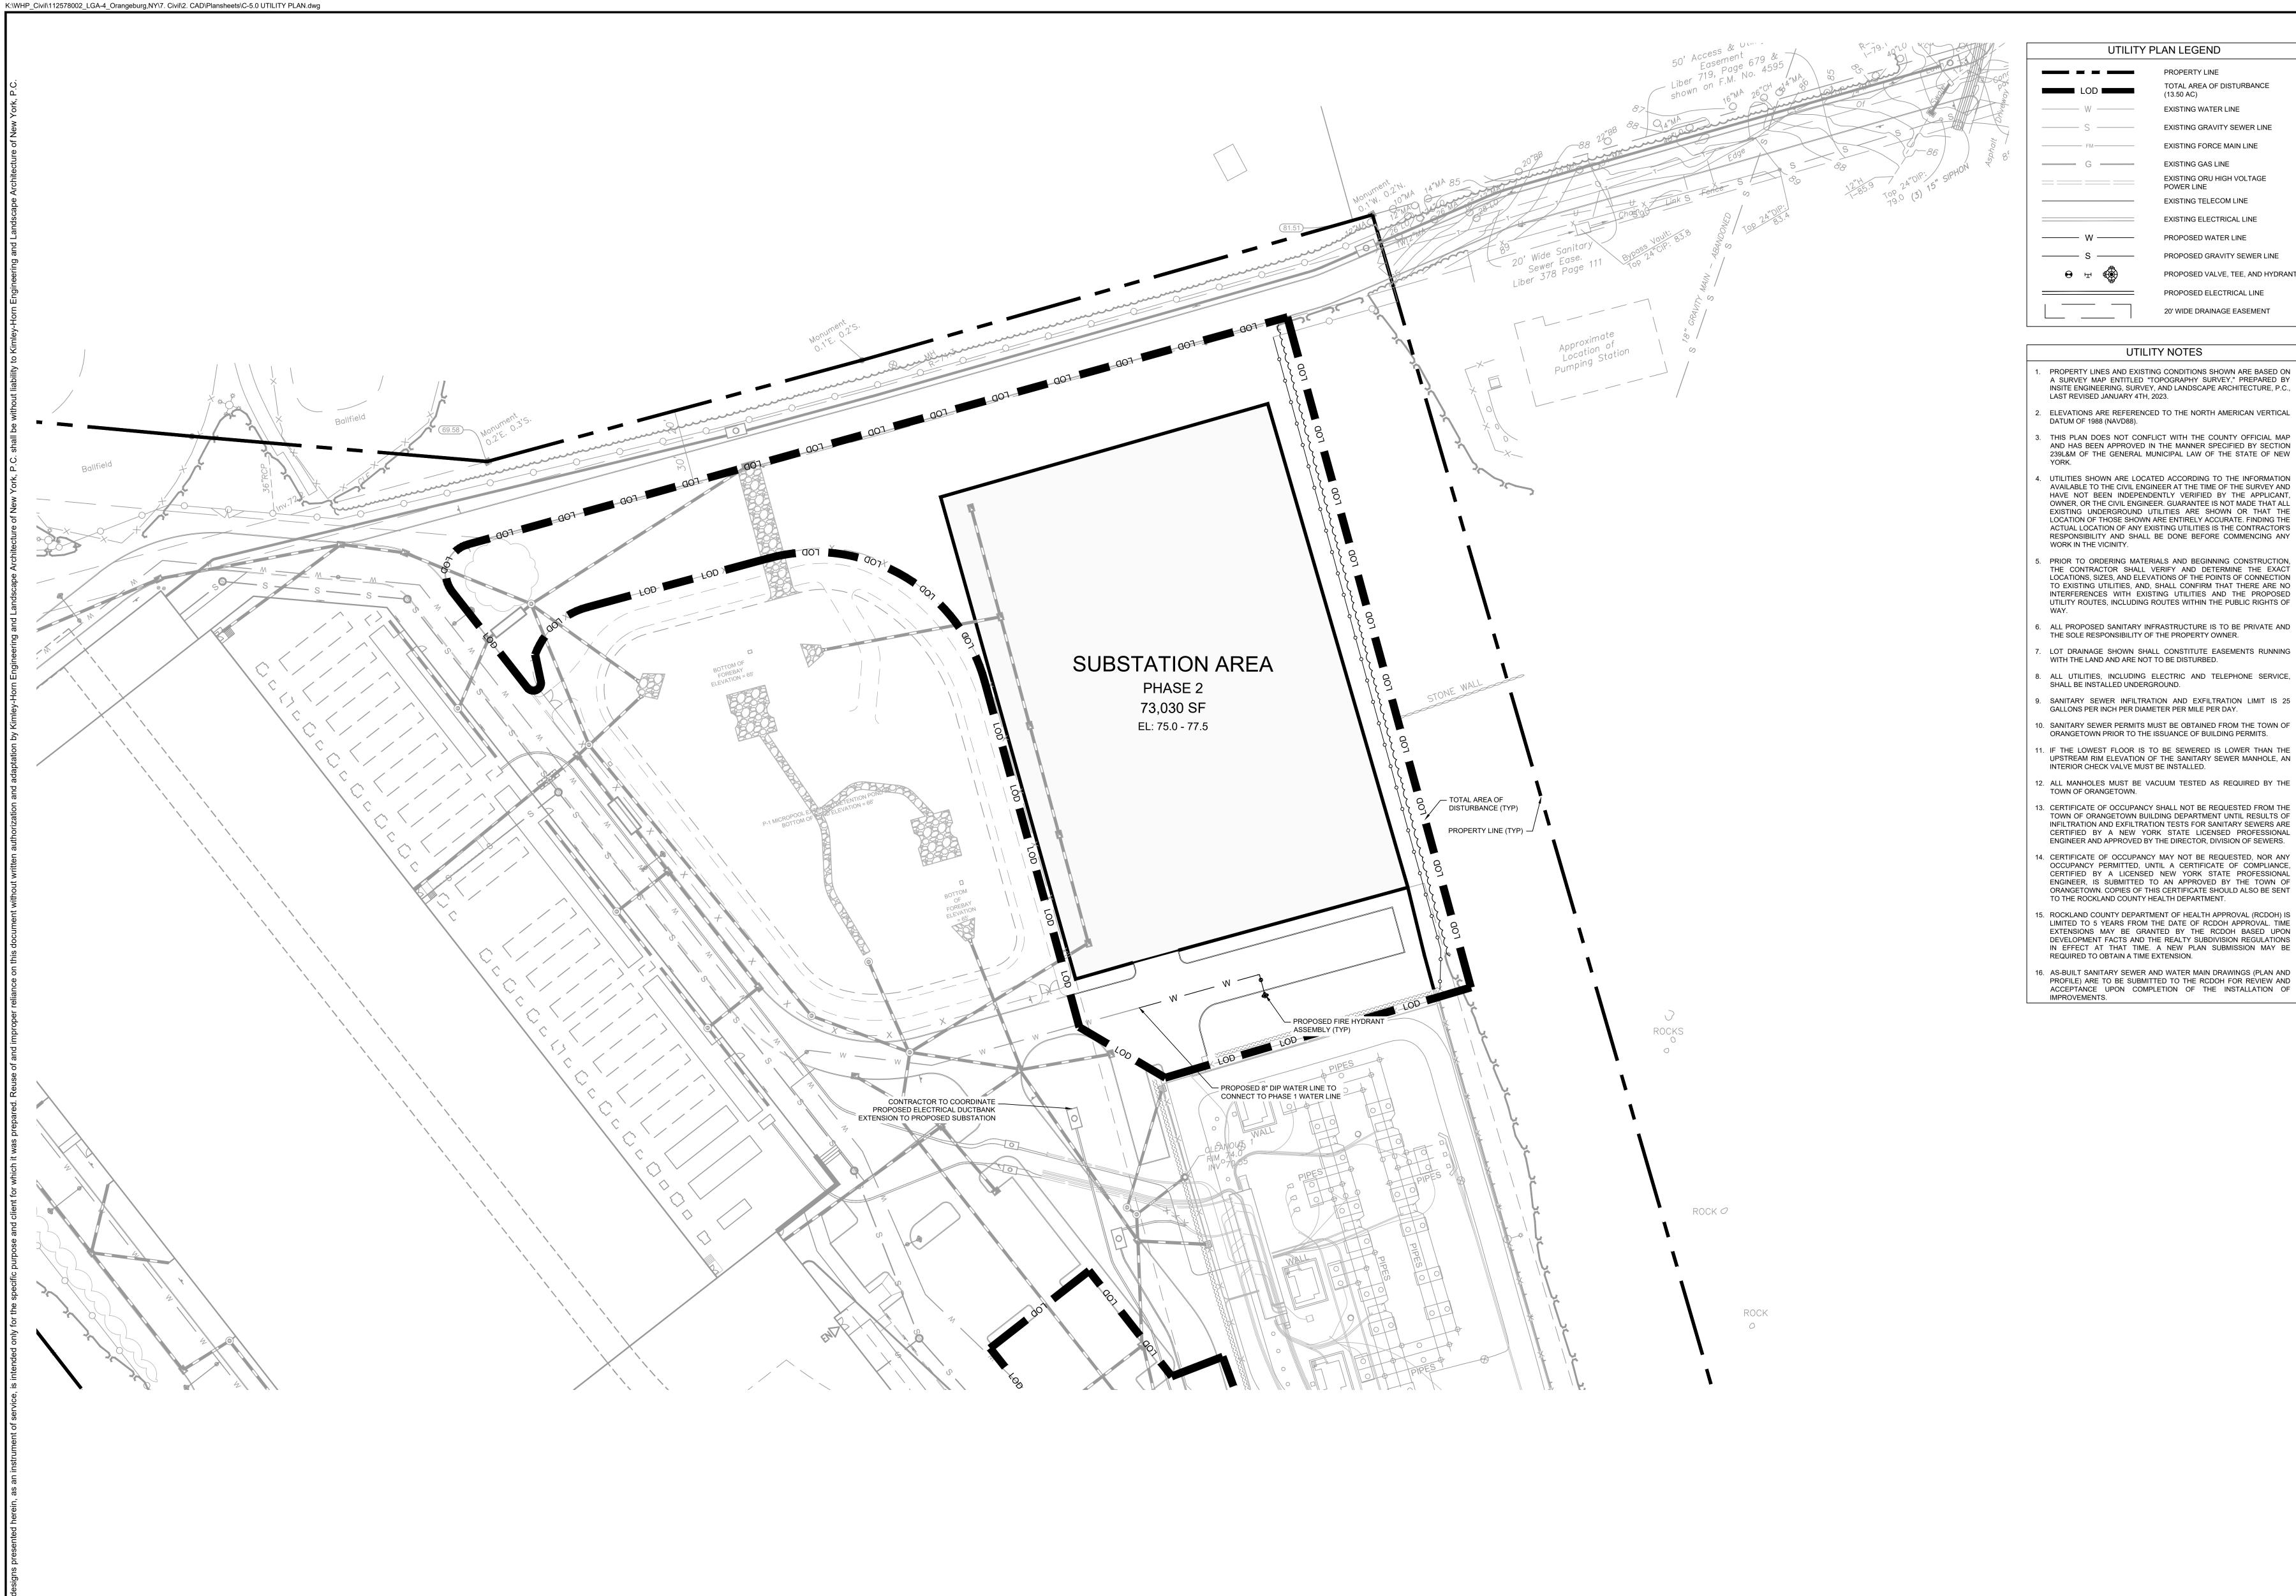
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SHEET NUMBER

C-5.1



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UTILITY PLAN LEGEND PROPERTY LINE TOTAL AREA OF DISTURBANCE EXISTING WATER LINE EXISTING GRAVITY SEWER LINE EXISTING FORCE MAIN LINE EXISTING GAS LINE EXISTING ORU HIGH VOLTAGE POWER LINE EXISTING TELECOM LINE EXISTING ELECTRICAL LINE PROPOSED WATER LINE PROPOSED GRAVITY SEWER LINE PROPOSED VALVE, TEE, AND HYDRANT PROPOSED ELECTRICAL LINE 20' WIDE DRAINAGE EASEMENT

PROPERTY LINES AND EXISTING CONDITIONS SHOWN ARE BASED ON

ELEVATIONS ARE REFERENCED TO THE NORTH AMERICAN VERTICAL

THIS PLAN DOES NOT CONFLICT WITH THE COUNTY OFFICIAL MAP

239L&M OF THE GENERAL MUNICIPAL LAW OF THE STATE OF NEW . UTILITIES SHOWN ARE LOCATED ACCORDING TO THE INFORMATION

OWNER, OR THE CIVIL ENGINEER. GUARANTEE IS NOT MADE THAT ALL EXISTING UNDERGROUND UTILITIES ARE SHOWN OR THAT THE LOCATION OF THOSE SHOWN ARE ENTIRELY ACCURATE. FINDING THE ACTUAL LOCATION OF ANY EXISTING UTILITIES IS THE CONTRACTOR'S RESPONSIBILITY AND SHALL BE DONE BEFORE COMMENCING ANY

LOCATIONS, SIZES, AND ELEVATIONS OF THE POINTS OF CONNECTION TO EXISTING UTILITIES, AND, SHALL CONFIRM THAT THERE ARE NO INTERFERENCES WITH EXISTING UTILITIES AND THE PROPOSED UTILITY ROUTES, INCLUDING ROUTES WITHIN THE PUBLIC RIGHTS OF

ALL PROPOSED SANITARY INFRASTRUCTURE IS TO BE PRIVATE AND THE SOLE RESPONSIBILITY OF THE PROPERTY OWNER.

LOT DRAINAGE SHOWN SHALL CONSTITUTE EASEMENTS RUNNING WITH THE LAND AND ARE NOT TO BE DISTURBED.

SANITARY SEWER INFILTRATION AND EXFILTRATION LIMIT IS 25

1. IF THE LOWEST FLOOR IS TO BE SEWERED IS LOWER THAN THE UPSTREAM RIM ELEVATION OF THE SANITARY SEWER MANHOLE, AN

TOWN OF ORANGETOWN BUILDING DEPARTMENT UNTIL RESULTS OF INFILTRATION AND EXFILTRATION TESTS FOR SANITARY SEWERS ARE CERTIFIED BY A NEW YORK STATE LICENSED PROFESSIONAL ENGINEER AND APPROVED BY THE DIRECTOR, DIVISION OF SEWERS. 14. CERTIFICATE OF OCCUPANCY MAY NOT BE REQUESTED, NOR ANY

OCCUPANCY PERMITTED, UNTIL A CERTIFICATE OF COMPLIANCE, CERTIFIED BY A LICENSED NEW YORK STATE PROFESSIONAL ENGINEER, IS SUBMITTED TO AN APPROVED BY THE TOWN OF ORANGETOWN. COPIES OF THIS CERTIFICATE SHOULD ALSO BE SENT TO THE ROCKLAND COUNTY HEALTH DEPARTMENT.

LIMITED TO 5 YEARS FROM THE DATE OF RCDOH APPROVAL. TIME EXTENSIONS MAY BE GRANTED BY THE RCDOH BASED UPON DEVELOPMENT FACTS AND THE REALTY SUBDIVISION REGULATIONS IN EFFECT AT THAT TIME. A NEW PLAN SUBMISSION MAY BE

A SURVEY MAP ENTITLED "TOPOGRAPHY SURVEY," PREPARED BY INSITE ENGINEERING, SURVEY, AND LANDSCAPE ARCHITECTURE, P.C.,

AND HAS BEEN APPROVED IN THE MANNER SPECIFIED BY SECTION

AVAILABLE TO THE CIVIL ENGINEER AT THE TIME OF THE SURVEY AND HAVE NOT BEEN INDEPENDENTLY VERIFIED BY THE APPLICANT,

THE CONTRACTOR SHALL VERIFY AND DETERMINE THE EXACT

ALL UTILITIES, INCLUDING ELECTRIC AND TELEPHONE SERVICE,

GALLONS PER INCH PER DIAMETER PER MILE PER DAY.

ORANGETOWN PRIOR TO THE ISSUANCE OF BUILDING PERMITS.

INTERIOR CHECK VALVE MUST BE INSTALLED. 12. ALL MANHOLES MUST BE VACUUM TESTED AS REQUIRED BY THE

13. CERTIFICATE OF OCCUPANCY SHALL NOT BE REQUESTED FROM THE


5. ROCKLAND COUNTY DEPARTMENT OF HEALTH APPROVAL (RCDOH) IS

REQUIRED TO OBTAIN A TIME EXTENSION.

16. AS-BUILT SANITARY SEWER AND WATER MAIN DRAWINGS (PLAN AND PROFILE) ARE TO BE SUBMITTED TO THE RCDOH FOR REVIEW AND ACCEPTANCE UPON COMPLETION OF THE INSTALLATION OF

PERMIT REVIEW

## SANITARY SEWER: PROFILE VIEW

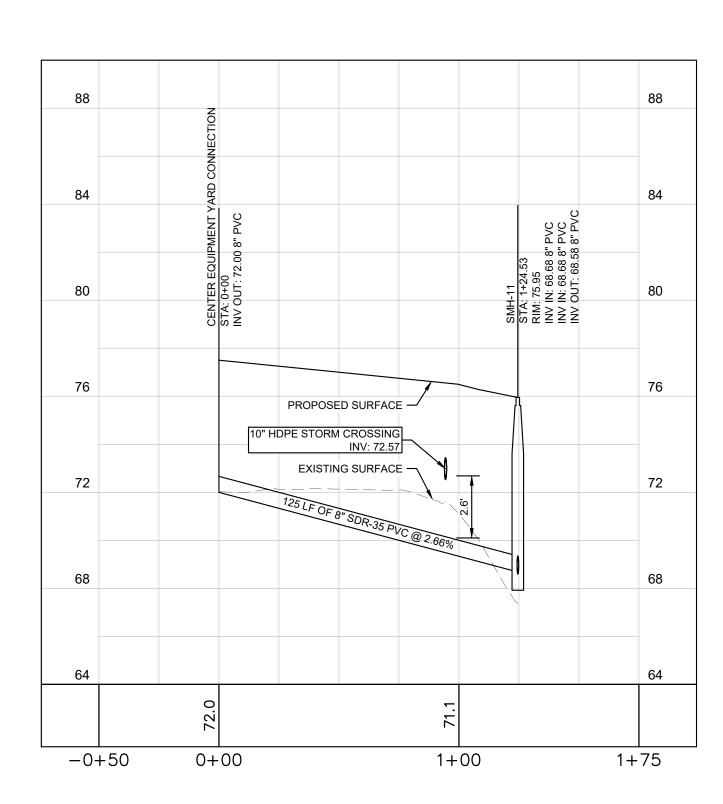

2+00

1+00


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-0+50

K:\WHP\_Civil\112578002\_LGA-4\_Orangeburg,NY\7. Civil\2. CAD\Plansheets\C-5.X SANITARY PROFILE PLAN.dwg

SANITARY SEWER:
CENTER EQUIPMENT YARD
PROFILE VIEW

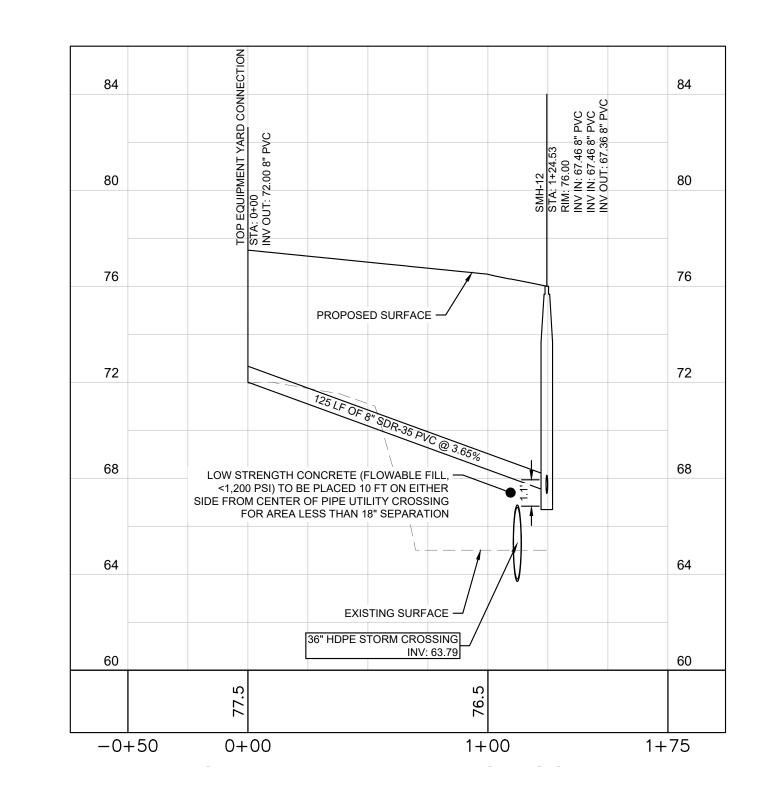WARNING - NO ALTERATION LEGAL NOTICE: IT IS A VIOLATION OF ARTICLE 145 OF THE NEW YORK, P.C. AND IS INTENDED ONLY FOR THE SPECIFIC PURPOSE AND





7+00

8+00 8+25


5+00

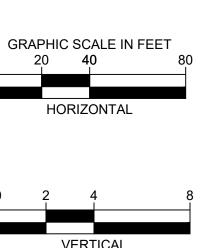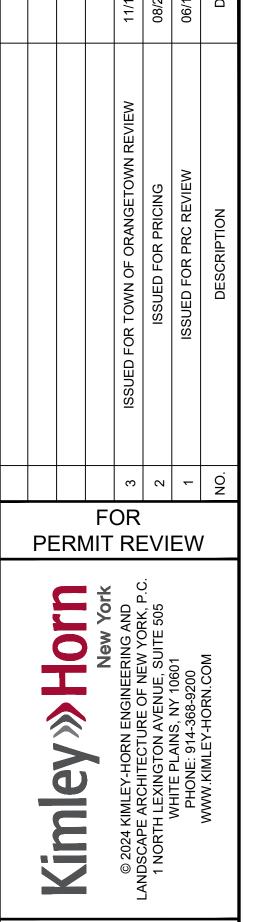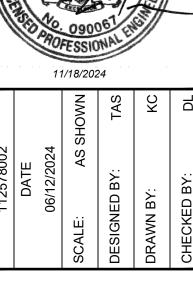SANITARY SEWER:
TOP EQUIPMENT YARD PROFILE
VIEW










SANITARY SEWER PROFILES


DATABANK ORANGEBUF
PHASE 2
2000 CORPORATE DRIVE
ORANGEBURG, NY 10962
TOWN OF ORANGETOWN
NEW TOWN

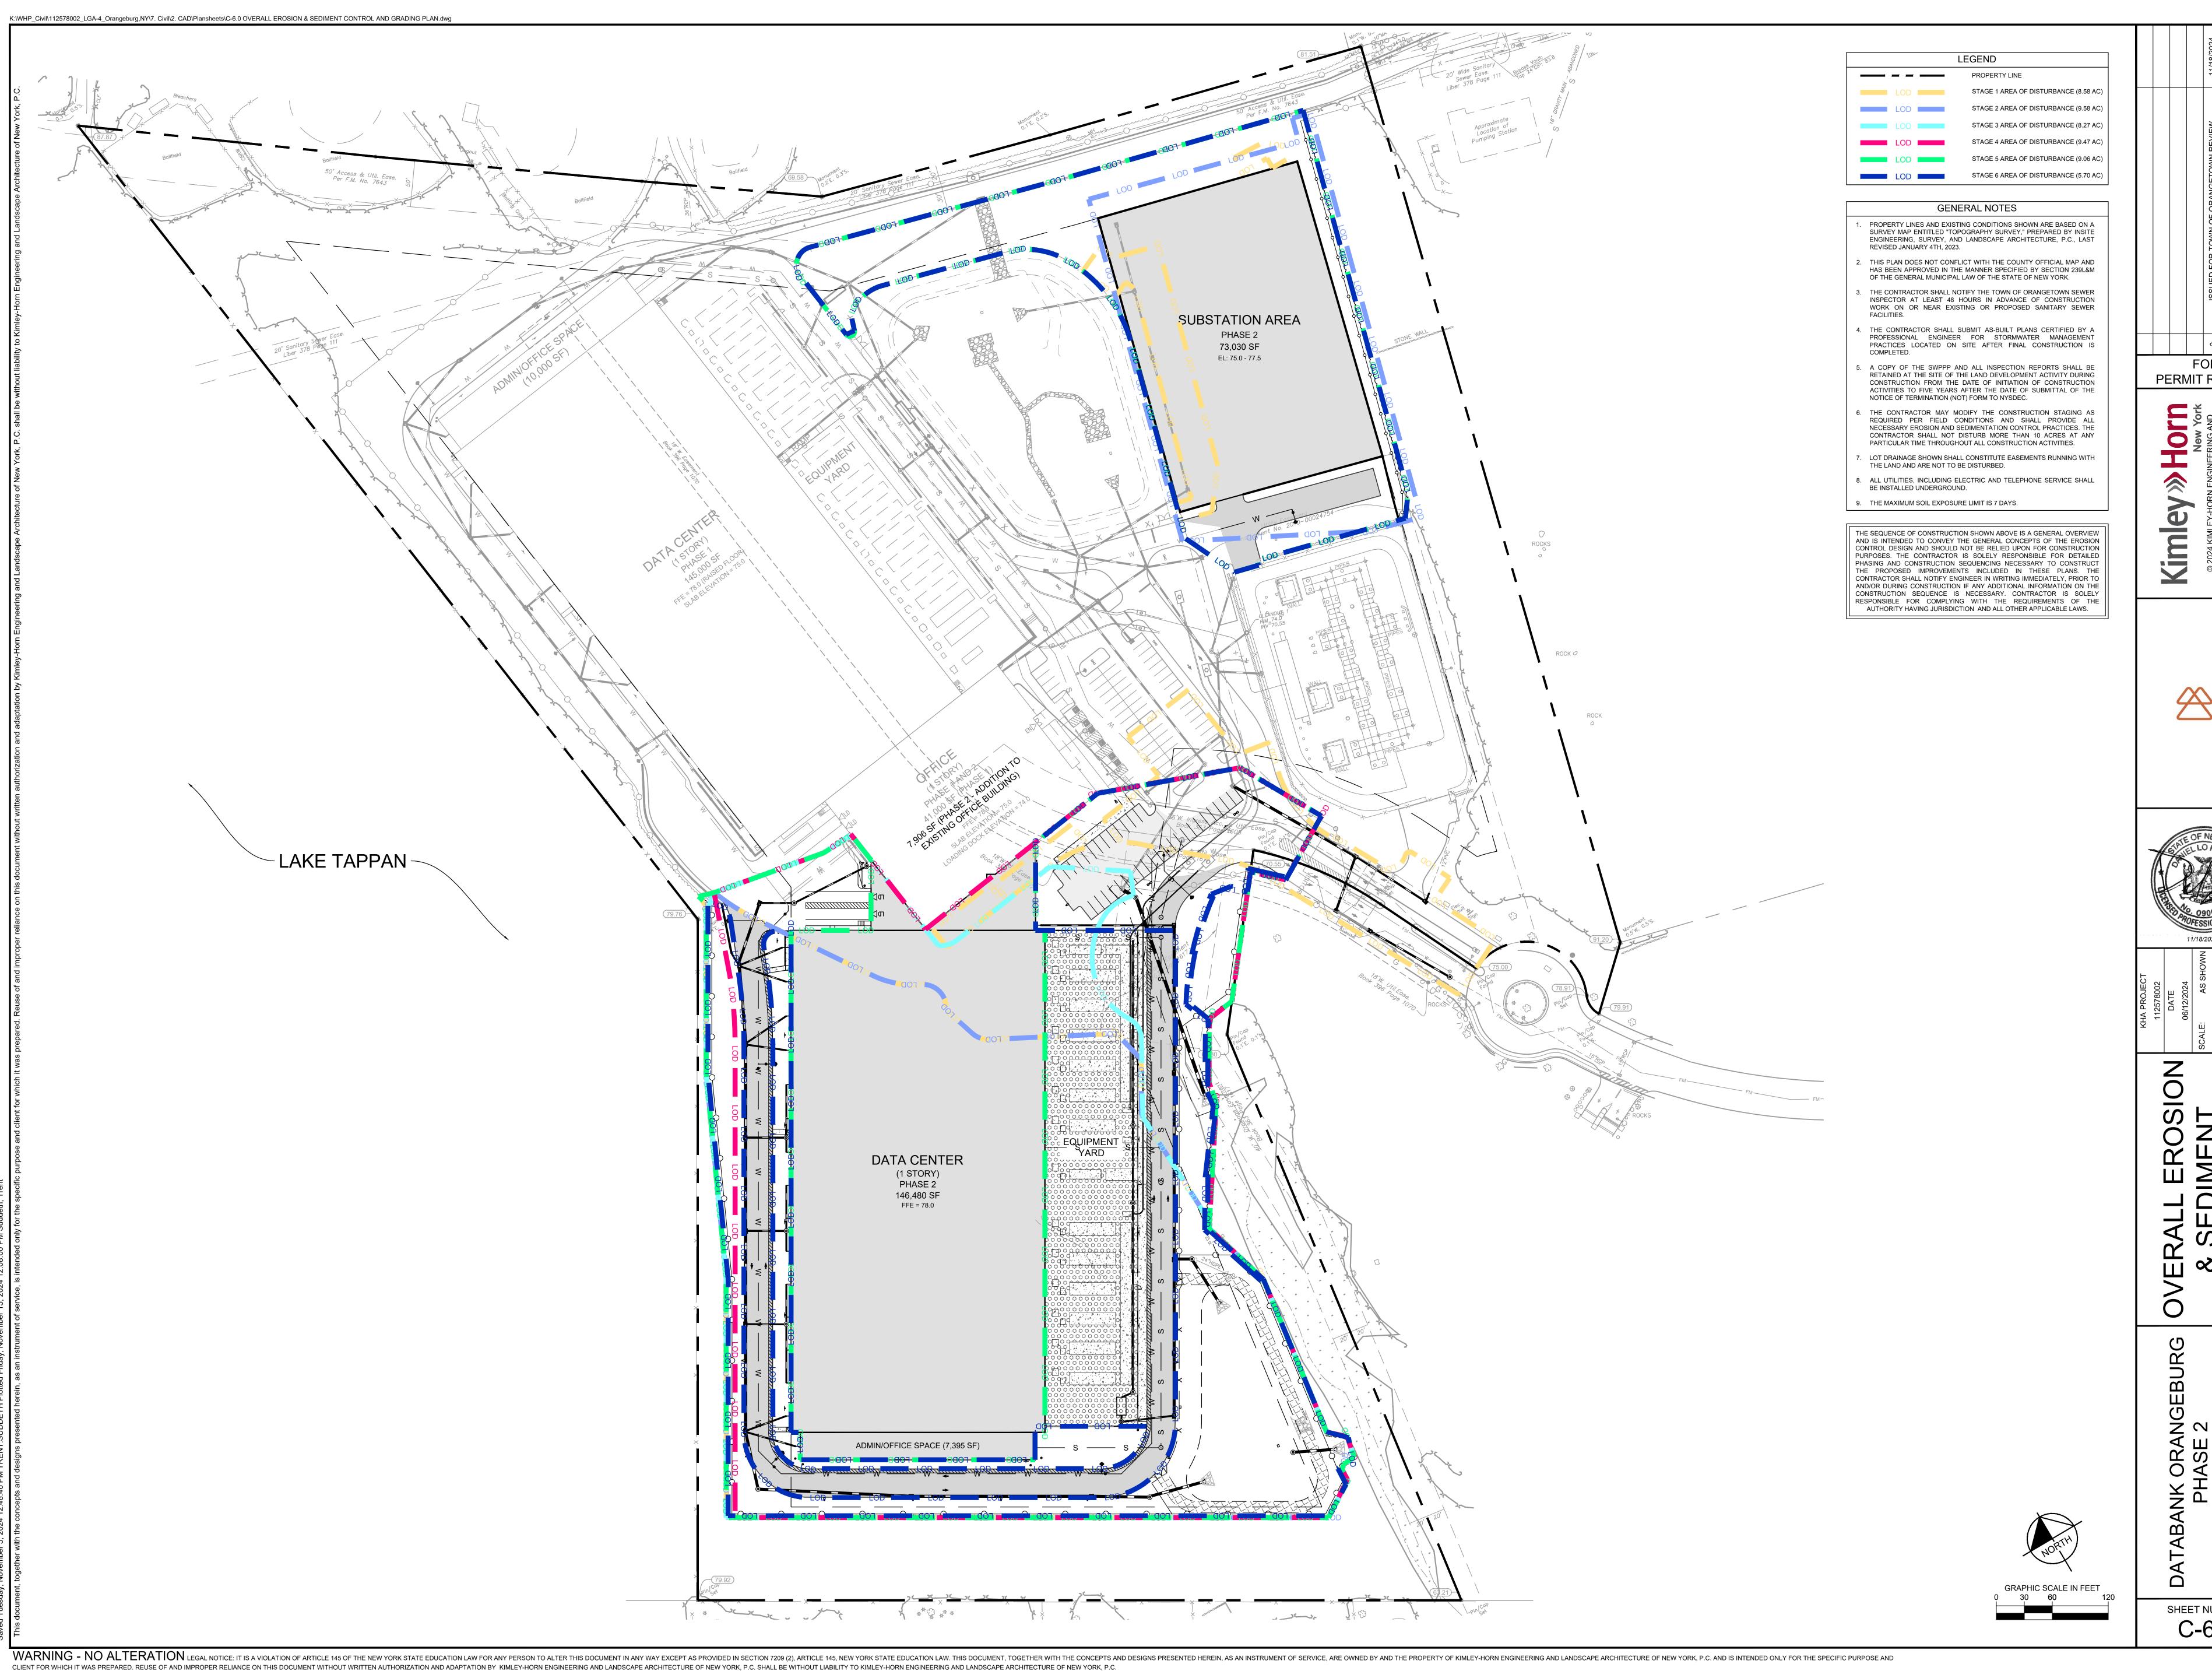sheet number C-5.3



PERMIT REVIEW




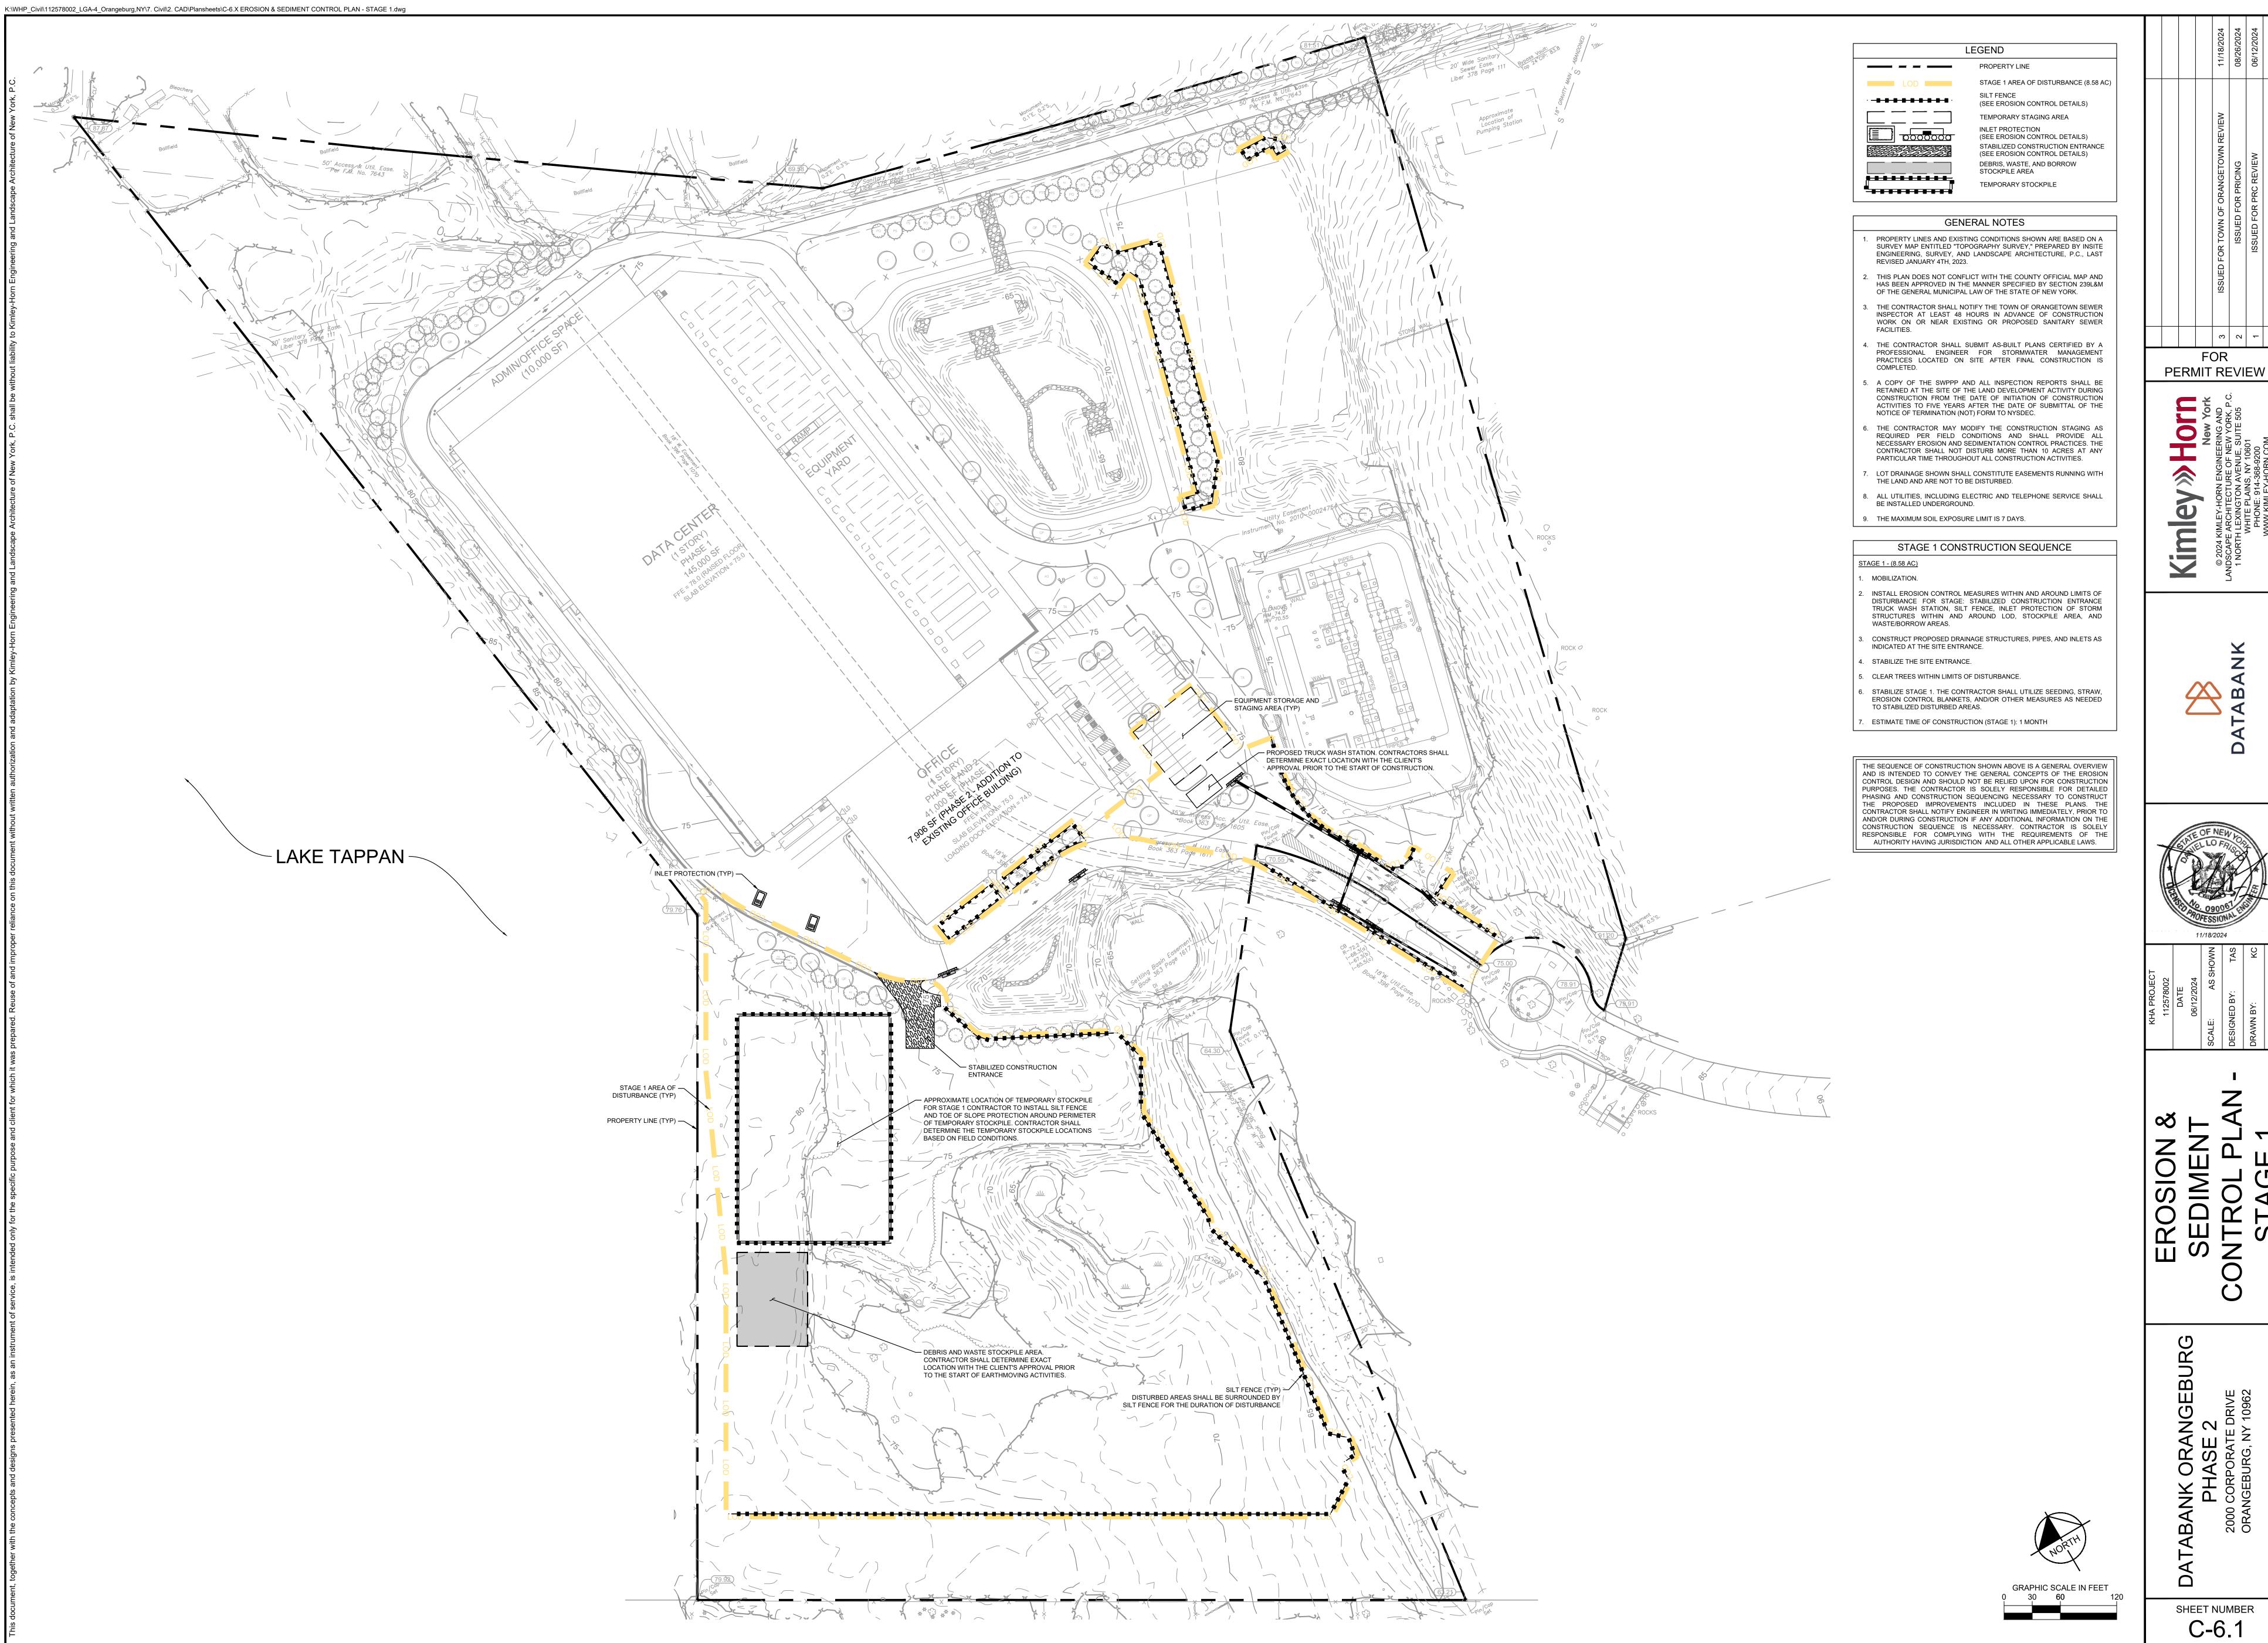

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STABILIZED CONSTRUCTION ENTRANCE (SEE EROSION CONTROL DETAILS)

(TO BE DETERMINED BY CONTRACTOR) DEBRIS, WASTE, AND BORROW TEMPORARY STOCKPILE

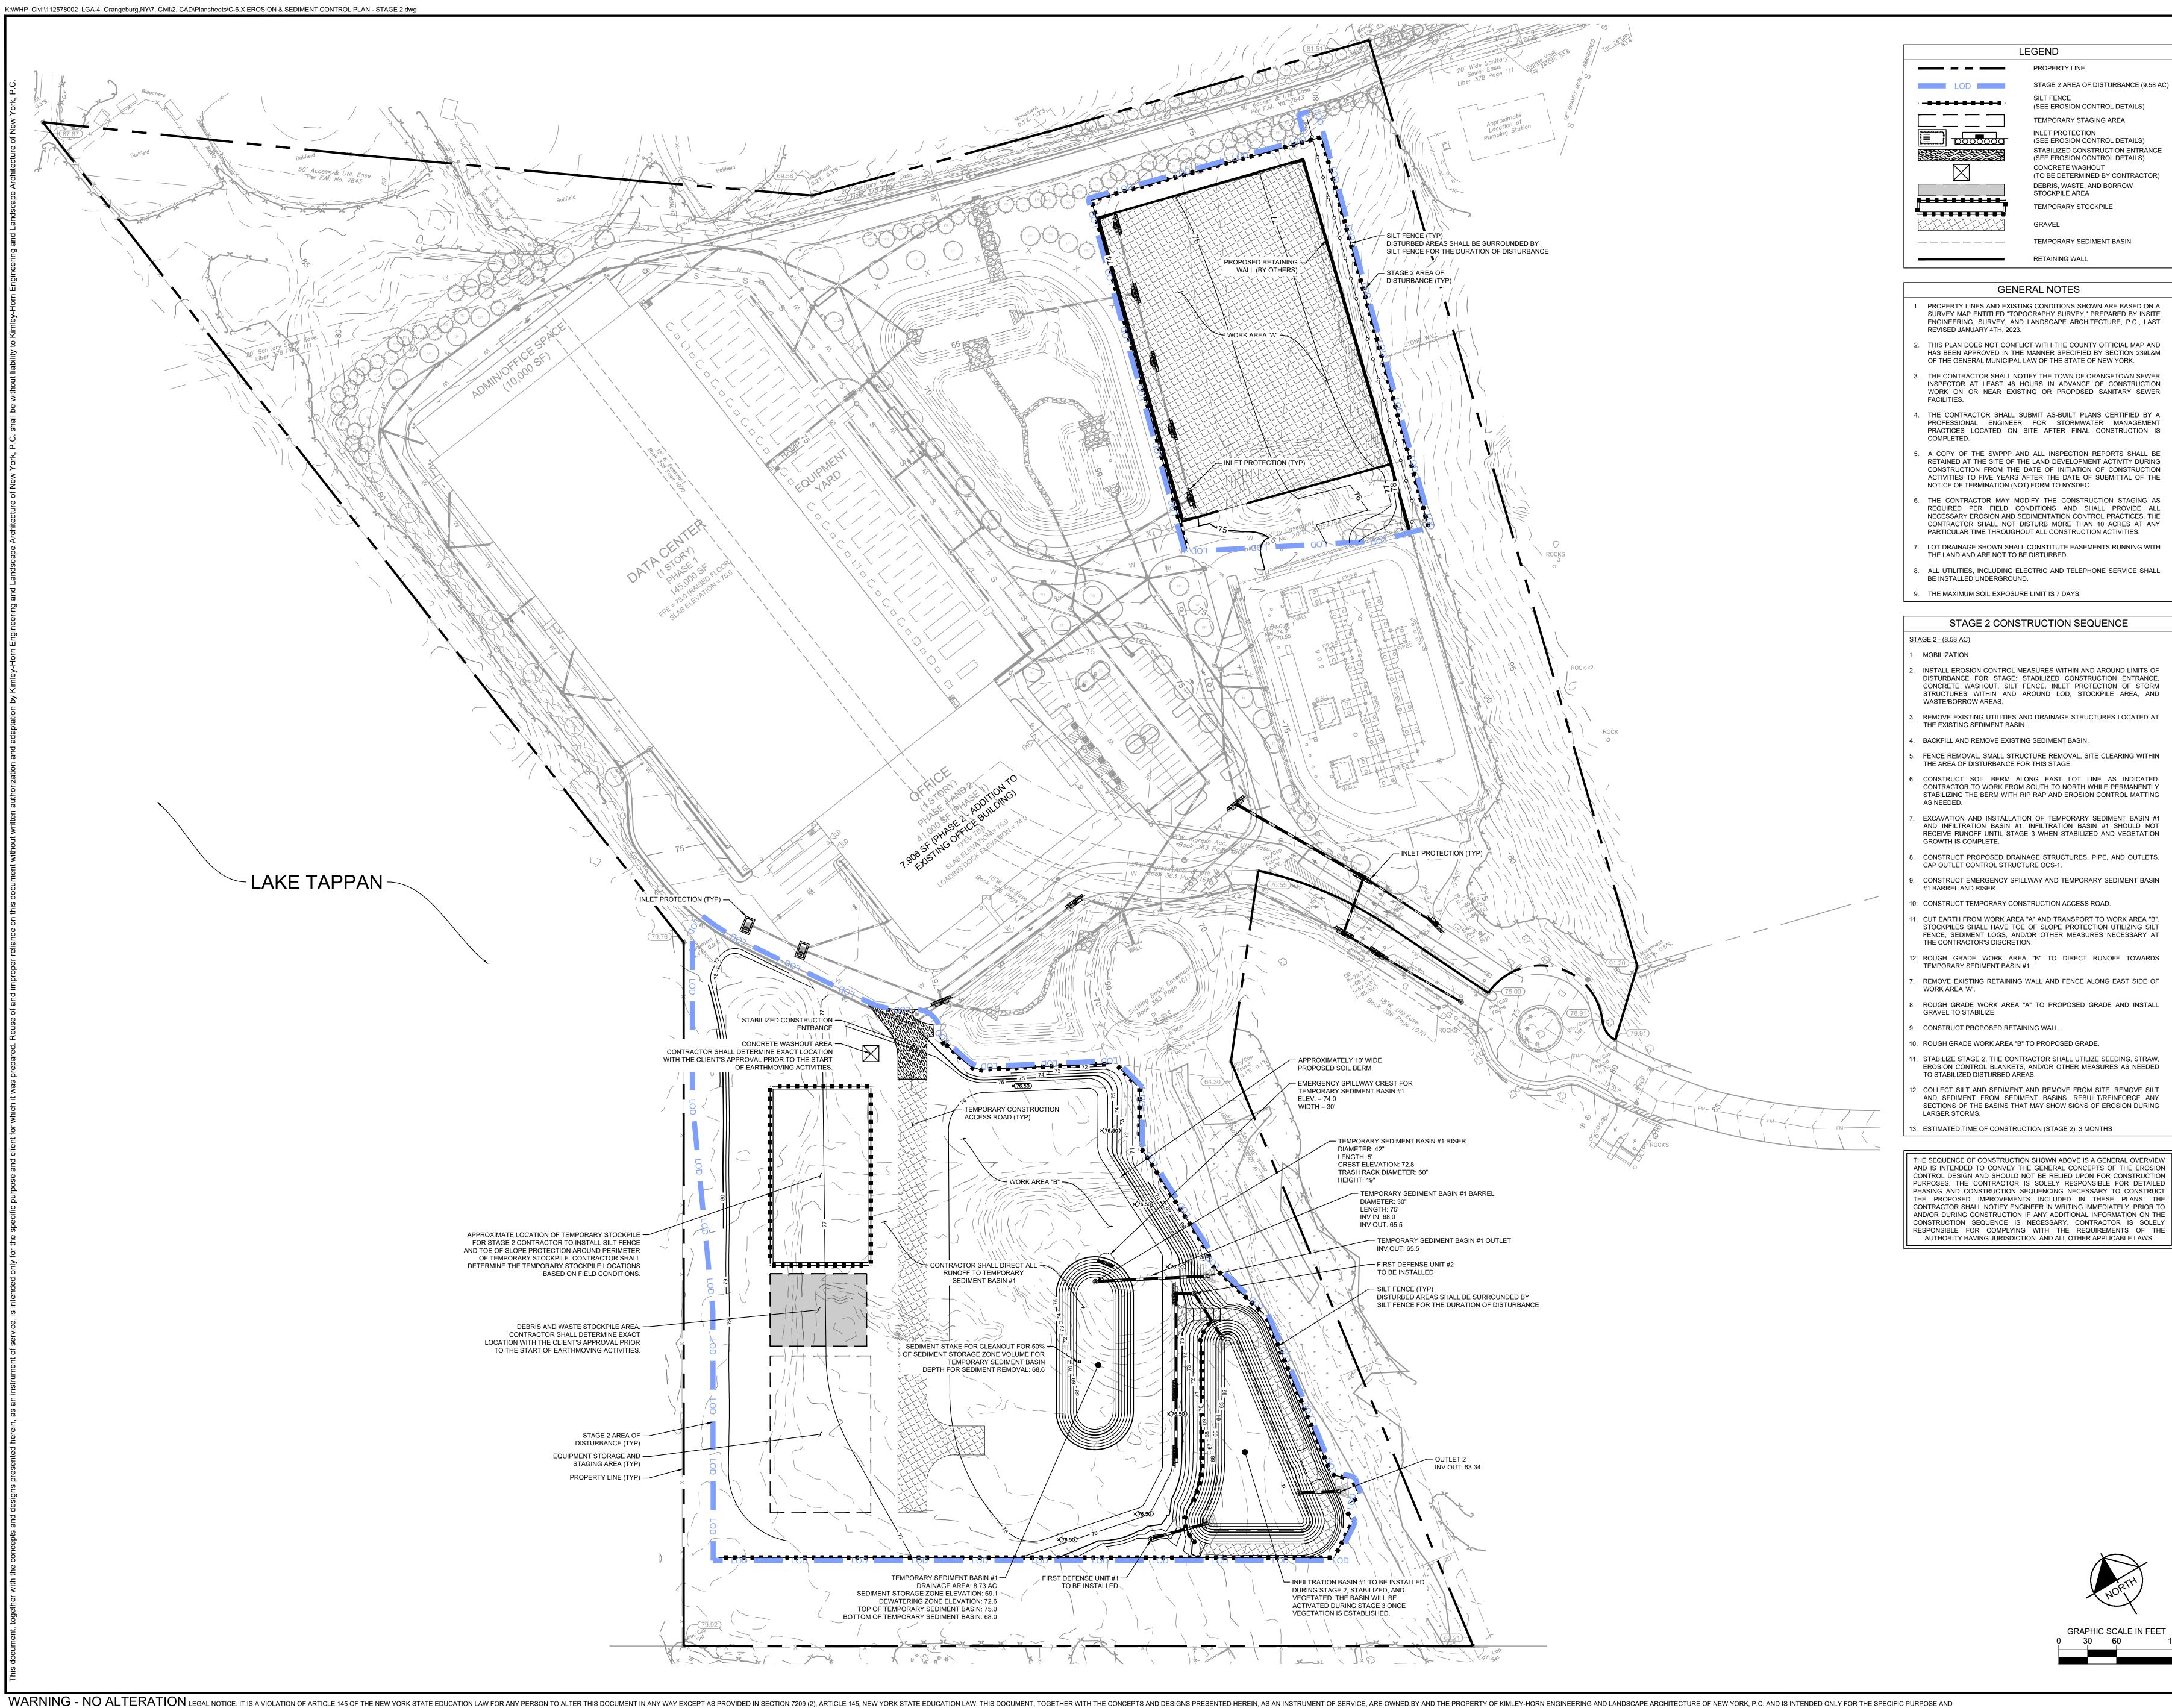TEMPORARY SEDIMENT BASIN

PERMIT REVIEW

SURVEY MAP ENTITLED "TOPOGRAPHY SURVEY," PREPARED BY INSITE ENGINEERING, SURVEY, AND LANDSCAPE ARCHITECTURE, P.C., LAST

#### THIS PLAN DOES NOT CONFLICT WITH THE COUNTY OFFICIAL MAP AND HAS BEEN APPROVED IN THE MANNER SPECIFIED BY SECTION 239L&M

- THE CONTRACTOR SHALL NOTIFY THE TOWN OF ORANGETOWN SEWER INSPECTOR AT LEAST 48 HOURS IN ADVANCE OF CONSTRUCTION
- THE CONTRACTOR SHALL SUBMIT AS-BUILT PLANS CERTIFIED BY A PROFESSIONAL ENGINEER FOR STORMWATER MANAGEMENT
- . A COPY OF THE SWPPP AND ALL INSPECTION REPORTS SHALL BE RETAINED AT THE SITE OF THE LAND DEVELOPMENT ACTIVITY DURING
- THE CONTRACTOR MAY MODIFY THE CONSTRUCTION STAGING AS REQUIRED PER FIELD CONDITIONS AND SHALL PROVIDE ALL
- LOT DRAINAGE SHOWN SHALL CONSTITUTE EASEMENTS RUNNING WITH
- . ALL UTILITIES, INCLUDING ELECTRIC AND TELEPHONE SERVICE SHALL

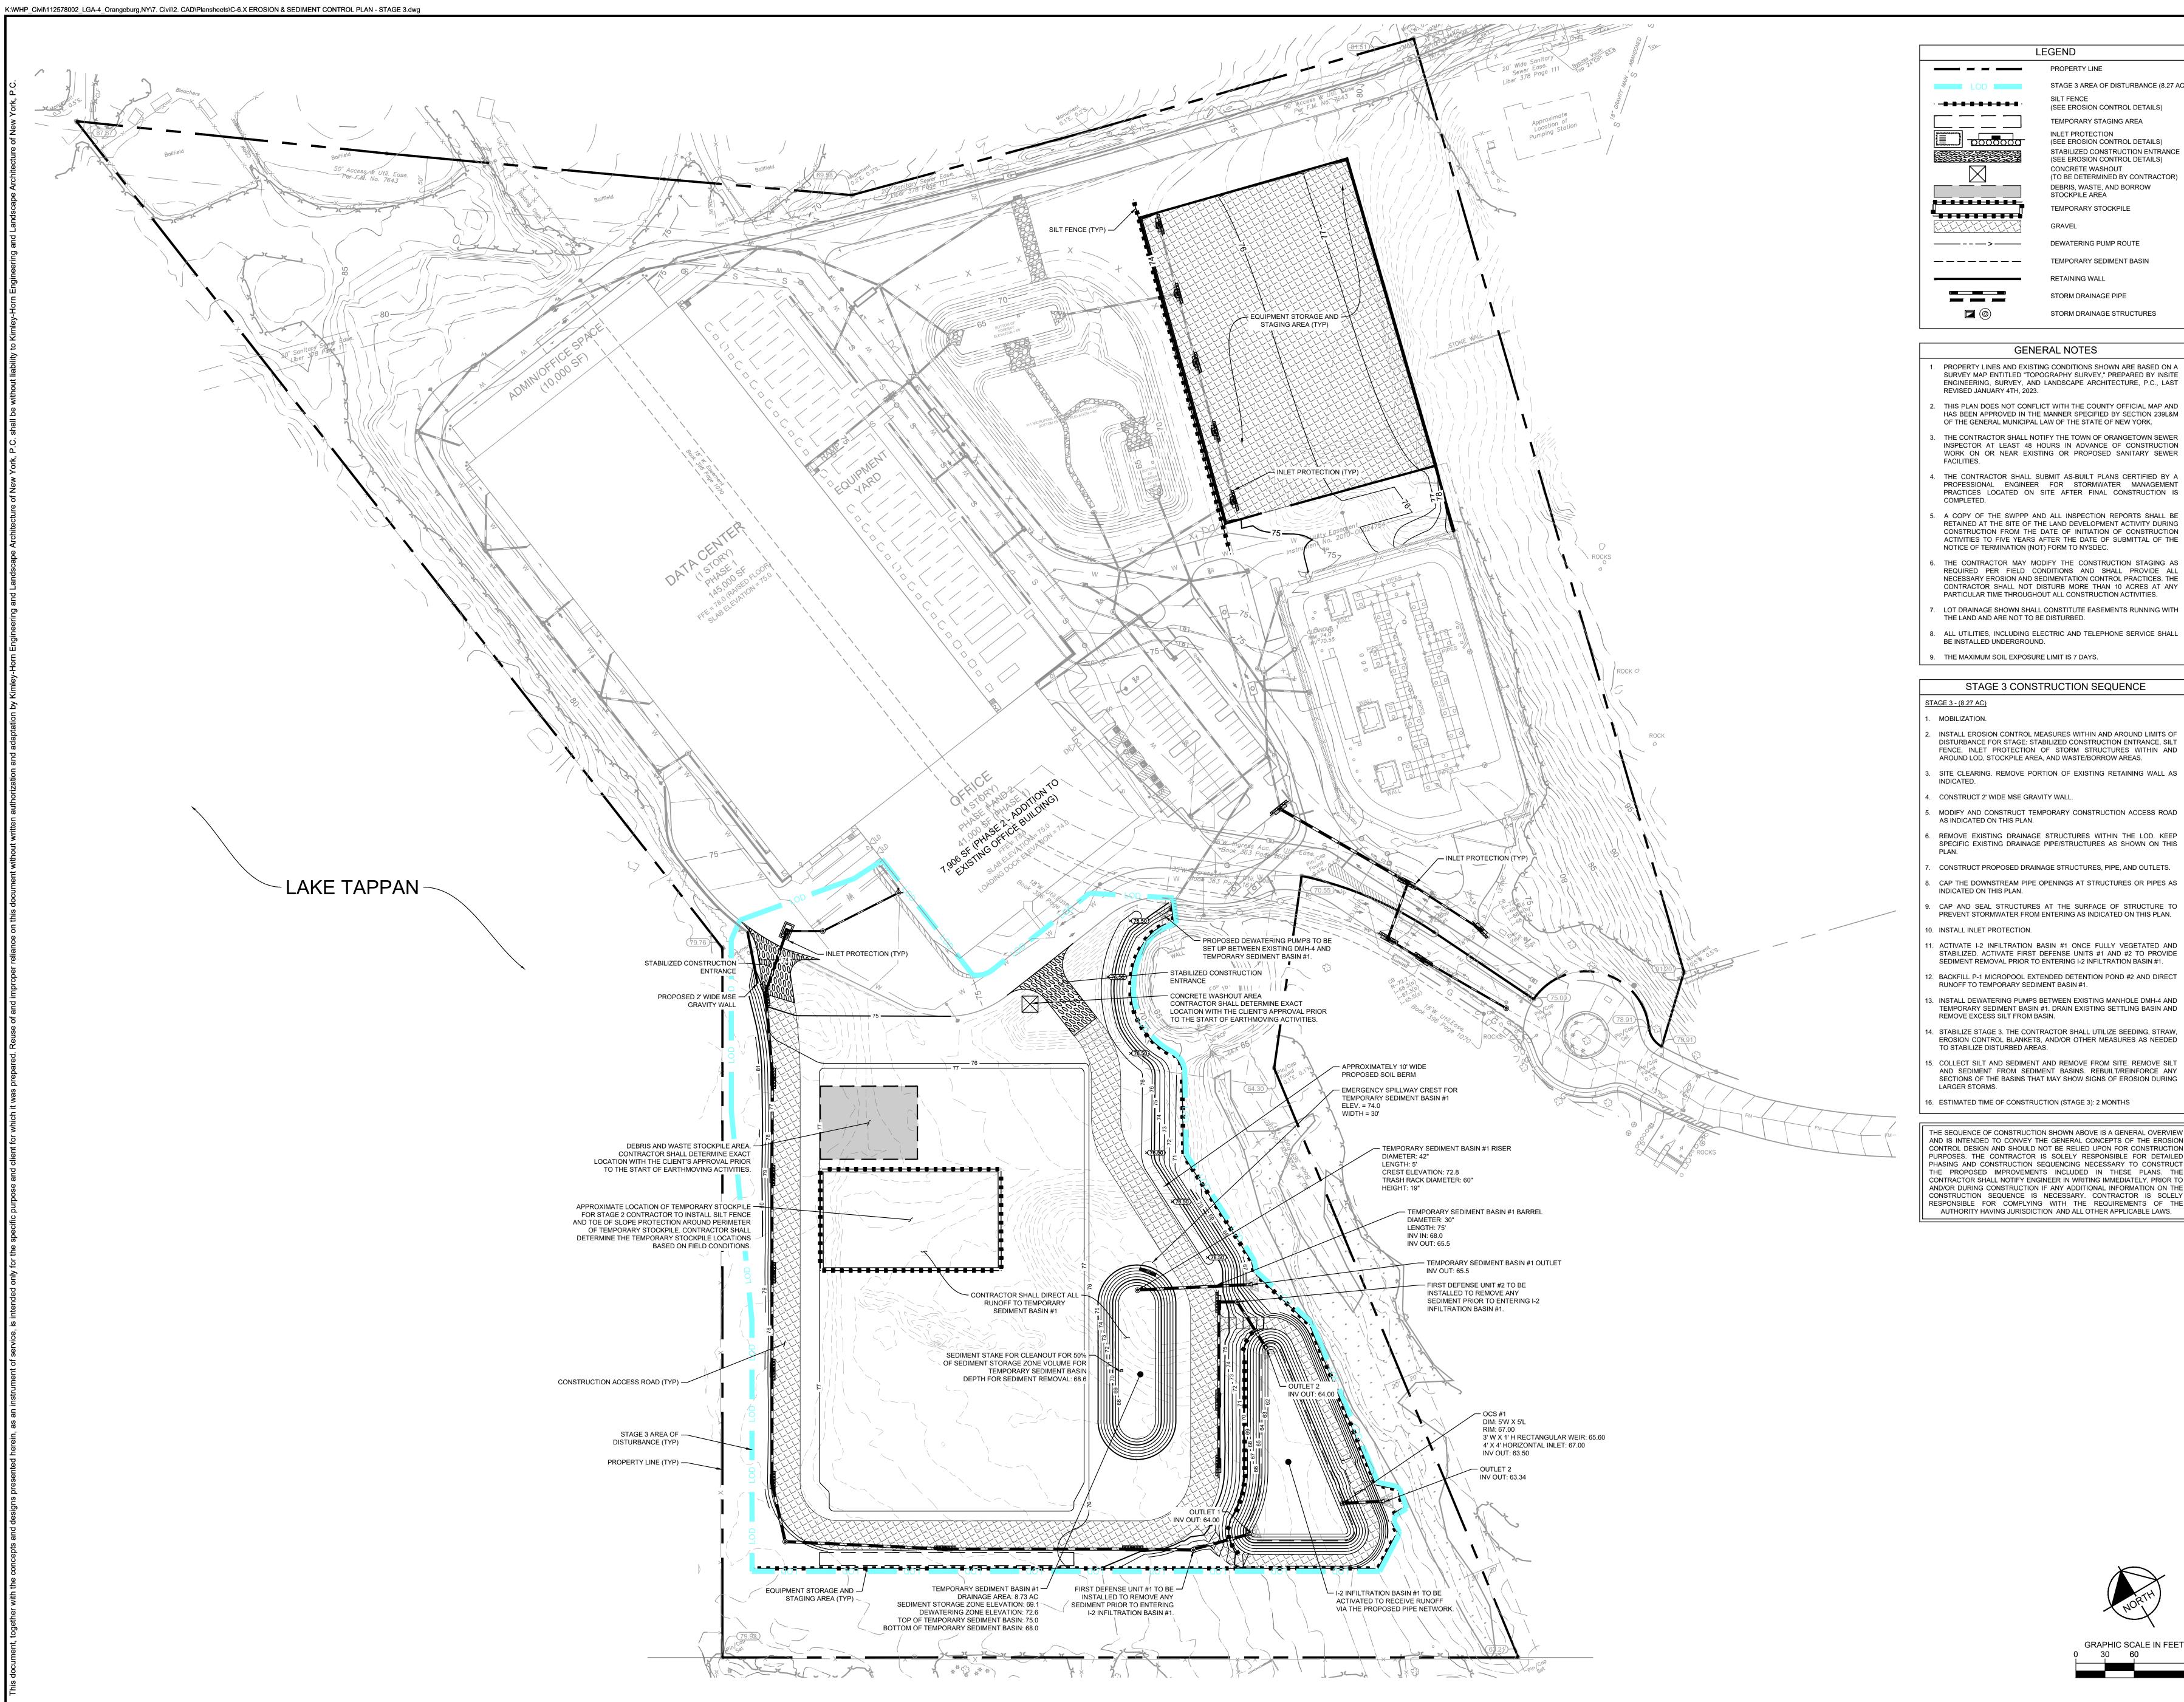
- DISTURBANCE FOR STAGE: STABILIZED CONSTRUCTION ENTRANCE, CONCRETE WASHOUT, SILT FENCE, INLET PROTECTION OF STORM STRUCTURES WITHIN AND AROUND LOD, STOCKPILE AREA, AND
- REMOVE EXISTING UTILITIES AND DRAINAGE STRUCTURES LOCATED AT
- CONSTRUCT SOIL BERM ALONG EAST LOT LINE AS INDICATED.
- CONTRACTOR TO WORK FROM SOUTH TO NORTH WHILE PERMANENTLY STABILIZING THE BERM WITH RIP RAP AND EROSION CONTROL MATTING
- AND INFILTRATION BASIN #1. INFILTRATION BASIN #1 SHOULD NOT RECEIVE RUNOFF UNTIL STAGE 3 WHEN STABILIZED AND VEGETATION
- CONSTRUCT PROPOSED DRAINAGE STRUCTURES, PIPE, AND OUTLETS.
- CONSTRUCT EMERGENCY SPILLWAY AND TEMPORARY SEDIMENT BASIN
- STOCKPILES SHALL HAVE TOE OF SLOPE PROTECTION UTILIZING SILT FENCE, SEDIMENT LOGS, AND/OR OTHER MEASURES NECESSARY AT
- ROUGH GRADE WORK AREA "B" TO DIRECT RUNOFF TOWARDS
- REMOVE EXISTING RETAINING WALL AND FENCE ALONG EAST SIDE OF

- EROSION CONTROL BLANKETS, AND/OR OTHER MEASURES AS NEEDED 2. COLLECT SILT AND SEDIMENT AND REMOVE FROM SITE. REMOVE SILT
- AND SEDIMENT FROM SEDIMENT BASINS. REBUILT/REINFORCE ANY SECTIONS OF THE BASINS THAT MAY SHOW SIGNS OF EROSION DURING

AND IS INTENDED TO CONVEY THE GENERAL CONCEPTS OF THE EROSION CONTROL DESIGN AND SHOULD NOT BE RELIED UPON FOR CONSTRUCTION PURPOSES. THE CONTRACTOR IS SOLELY RESPONSIBLE FOR DETAILED PHASING AND CONSTRUCTION SEQUENCING NECESSARY TO CONSTRUCT THE PROPOSED IMPROVEMENTS INCLUDED IN THESE PLANS. THE CONTRACTOR SHALL NOTIFY ENGINEER IN WRITING IMMEDIATELY, PRIOR TO AND/OR DURING CONSTRUCTION IF ANY ADDITIONAL INFORMATION ON THE CONSTRUCTION SEQUENCE IS NECESSARY. CONTRACTOR IS SOLELY

SHEET NUMBER

C-6.2



LEGEND PROPERTY LINE STAGE 3 AREA OF DISTURBANCE (8.27 AC) (SEE EROSION CONTROL DETAILS) TEMPORARY STAGING AREA

INLET PROTECTION (SEE EROSION CONTROL DETAILS) STABILIZED CONSTRUCTION ENTRANCE (SEE EROSION CONTROL DETAILS) CONCRETE WASHOUT (TO BE DETERMINED BY CONTRACTOR) DEBRIS, WASTE, AND BORROW

STOCKPILE AREA TEMPORARY STOCKPILE

- PROPERTY LINES AND EXISTING CONDITIONS SHOWN ARE BASED ON A SURVEY MAP ENTITLED "TOPOGRAPHY SURVEY," PREPARED BY INSITE ENGINEERING, SURVEY, AND LANDSCAPE ARCHITECTURE, P.C., LAST
- THIS PLAN DOES NOT CONFLICT WITH THE COUNTY OFFICIAL MAP AND HAS BEEN APPROVED IN THE MANNER SPECIFIED BY SECTION 239L&M OF THE GENERAL MUNICIPAL LAW OF THE STATE OF NEW YORK.

DEWATERING PUMP ROUTE

RETAINING WALL

STORM DRAINAGE PIPE

TEMPORARY SEDIMENT BASIN

STORM DRAINAGE STRUCTURES

- THE CONTRACTOR SHALL NOTIFY THE TOWN OF ORANGETOWN SEWER INSPECTOR AT LEAST 48 HOURS IN ADVANCE OF CONSTRUCTION WORK ON OR NEAR EXISTING OR PROPOSED SANITARY SEWER
- THE CONTRACTOR SHALL SUBMIT AS-BUILT PLANS CERTIFIED BY A PROFESSIONAL ENGINEER FOR STORMWATER MANAGEMENT PRACTICES LOCATED ON SITE AFTER FINAL CONSTRUCTION IS
- . A COPY OF THE SWPPP AND ALL INSPECTION REPORTS SHALL BE RETAINED AT THE SITE OF THE LAND DEVELOPMENT ACTIVITY DURING CONSTRUCTION FROM THE DATE OF INITIATION OF CONSTRUCTION
- THE CONTRACTOR MAY MODIFY THE CONSTRUCTION STAGING AS REQUIRED PER FIELD CONDITIONS AND SHALL PROVIDE ALL NECESSARY EROSION AND SEDIMENTATION CONTROL PRACTICES. THE
- LOT DRAINAGE SHOWN SHALL CONSTITUTE EASEMENTS RUNNING WITH THE LAND AND ARE NOT TO BE DISTURBED.
- ALL UTILITIES, INCLUDING ELECTRIC AND TELEPHONE SERVICE SHALL

#### STAGE 3 CONSTRUCTION SEQUENCE

INSTALL EROSION CONTROL MEASURES WITHIN AND AROUND LIMITS OF DISTURBANCE FOR STAGE: STABILIZED CONSTRUCTION ENTRANCE, SILT FENCE, INLET PROTECTION OF STORM STRUCTURES WITHIN AND AROUND LOD, STOCKPILE AREA, AND WASTE/BORROW AREAS.

- SITE CLEARING. REMOVE PORTION OF EXISTING RETAINING WALL AS
- MODIFY AND CONSTRUCT TEMPORARY CONSTRUCTION ACCESS ROAD
- REMOVE EXISTING DRAINAGE STRUCTURES WITHIN THE LOD. KEEP SPECIFIC EXISTING DRAINAGE PIPE/STRUCTURES AS SHOWN ON THIS
- CONSTRUCT PROPOSED DRAINAGE STRUCTURES, PIPE, AND OUTLETS. CAP THE DOWNSTREAM PIPE OPENINGS AT STRUCTURES OR PIPES AS
- CAP AND SEAL STRUCTURES AT THE SURFACE OF STRUCTURE TO PREVENT STORMWATER FROM ENTERING AS INDICATED ON THIS PLAN.
- ). INSTALL INLET PROTECTION.
- ACTIVATE I-2 INFILTRATION BASIN #1 ONCE FULLY VEGETATED AND STABILIZED. ACTIVATE FIRST DEFENSE UNITS #1 AND #2 TO PROVIDE SEDIMENT REMOVAL PRIOR TO ENTERING I-2 INFILTRATION BASIN #1.
- RUNOFF TO TEMPORARY SEDIMENT BASIN #1.
- INSTALL DEWATERING PUMPS BETWEEN EXISTING MANHOLE DMH-4 AND TEMPORARY SEDIMENT BASIN #1. DRAIN EXISTING SETTLING BASIN AND
- STABILIZE STAGE 3. THE CONTRACTOR SHALL UTILIZE SEEDING, STRAW, EROSION CONTROL BLANKETS, AND/OR OTHER MEASURES AS NEEDED
- 5. COLLECT SILT AND SEDIMENT AND REMOVE FROM SITE. REMOVE SILT
- AND SEDIMENT FROM SEDIMENT BASINS. REBUILT/REINFORCE ANY SECTIONS OF THE BASINS THAT MAY SHOW SIGNS OF EROSION DURING
- 6. ESTIMATED TIME OF CONSTRUCTION (STAGE 3): 2 MONTHS

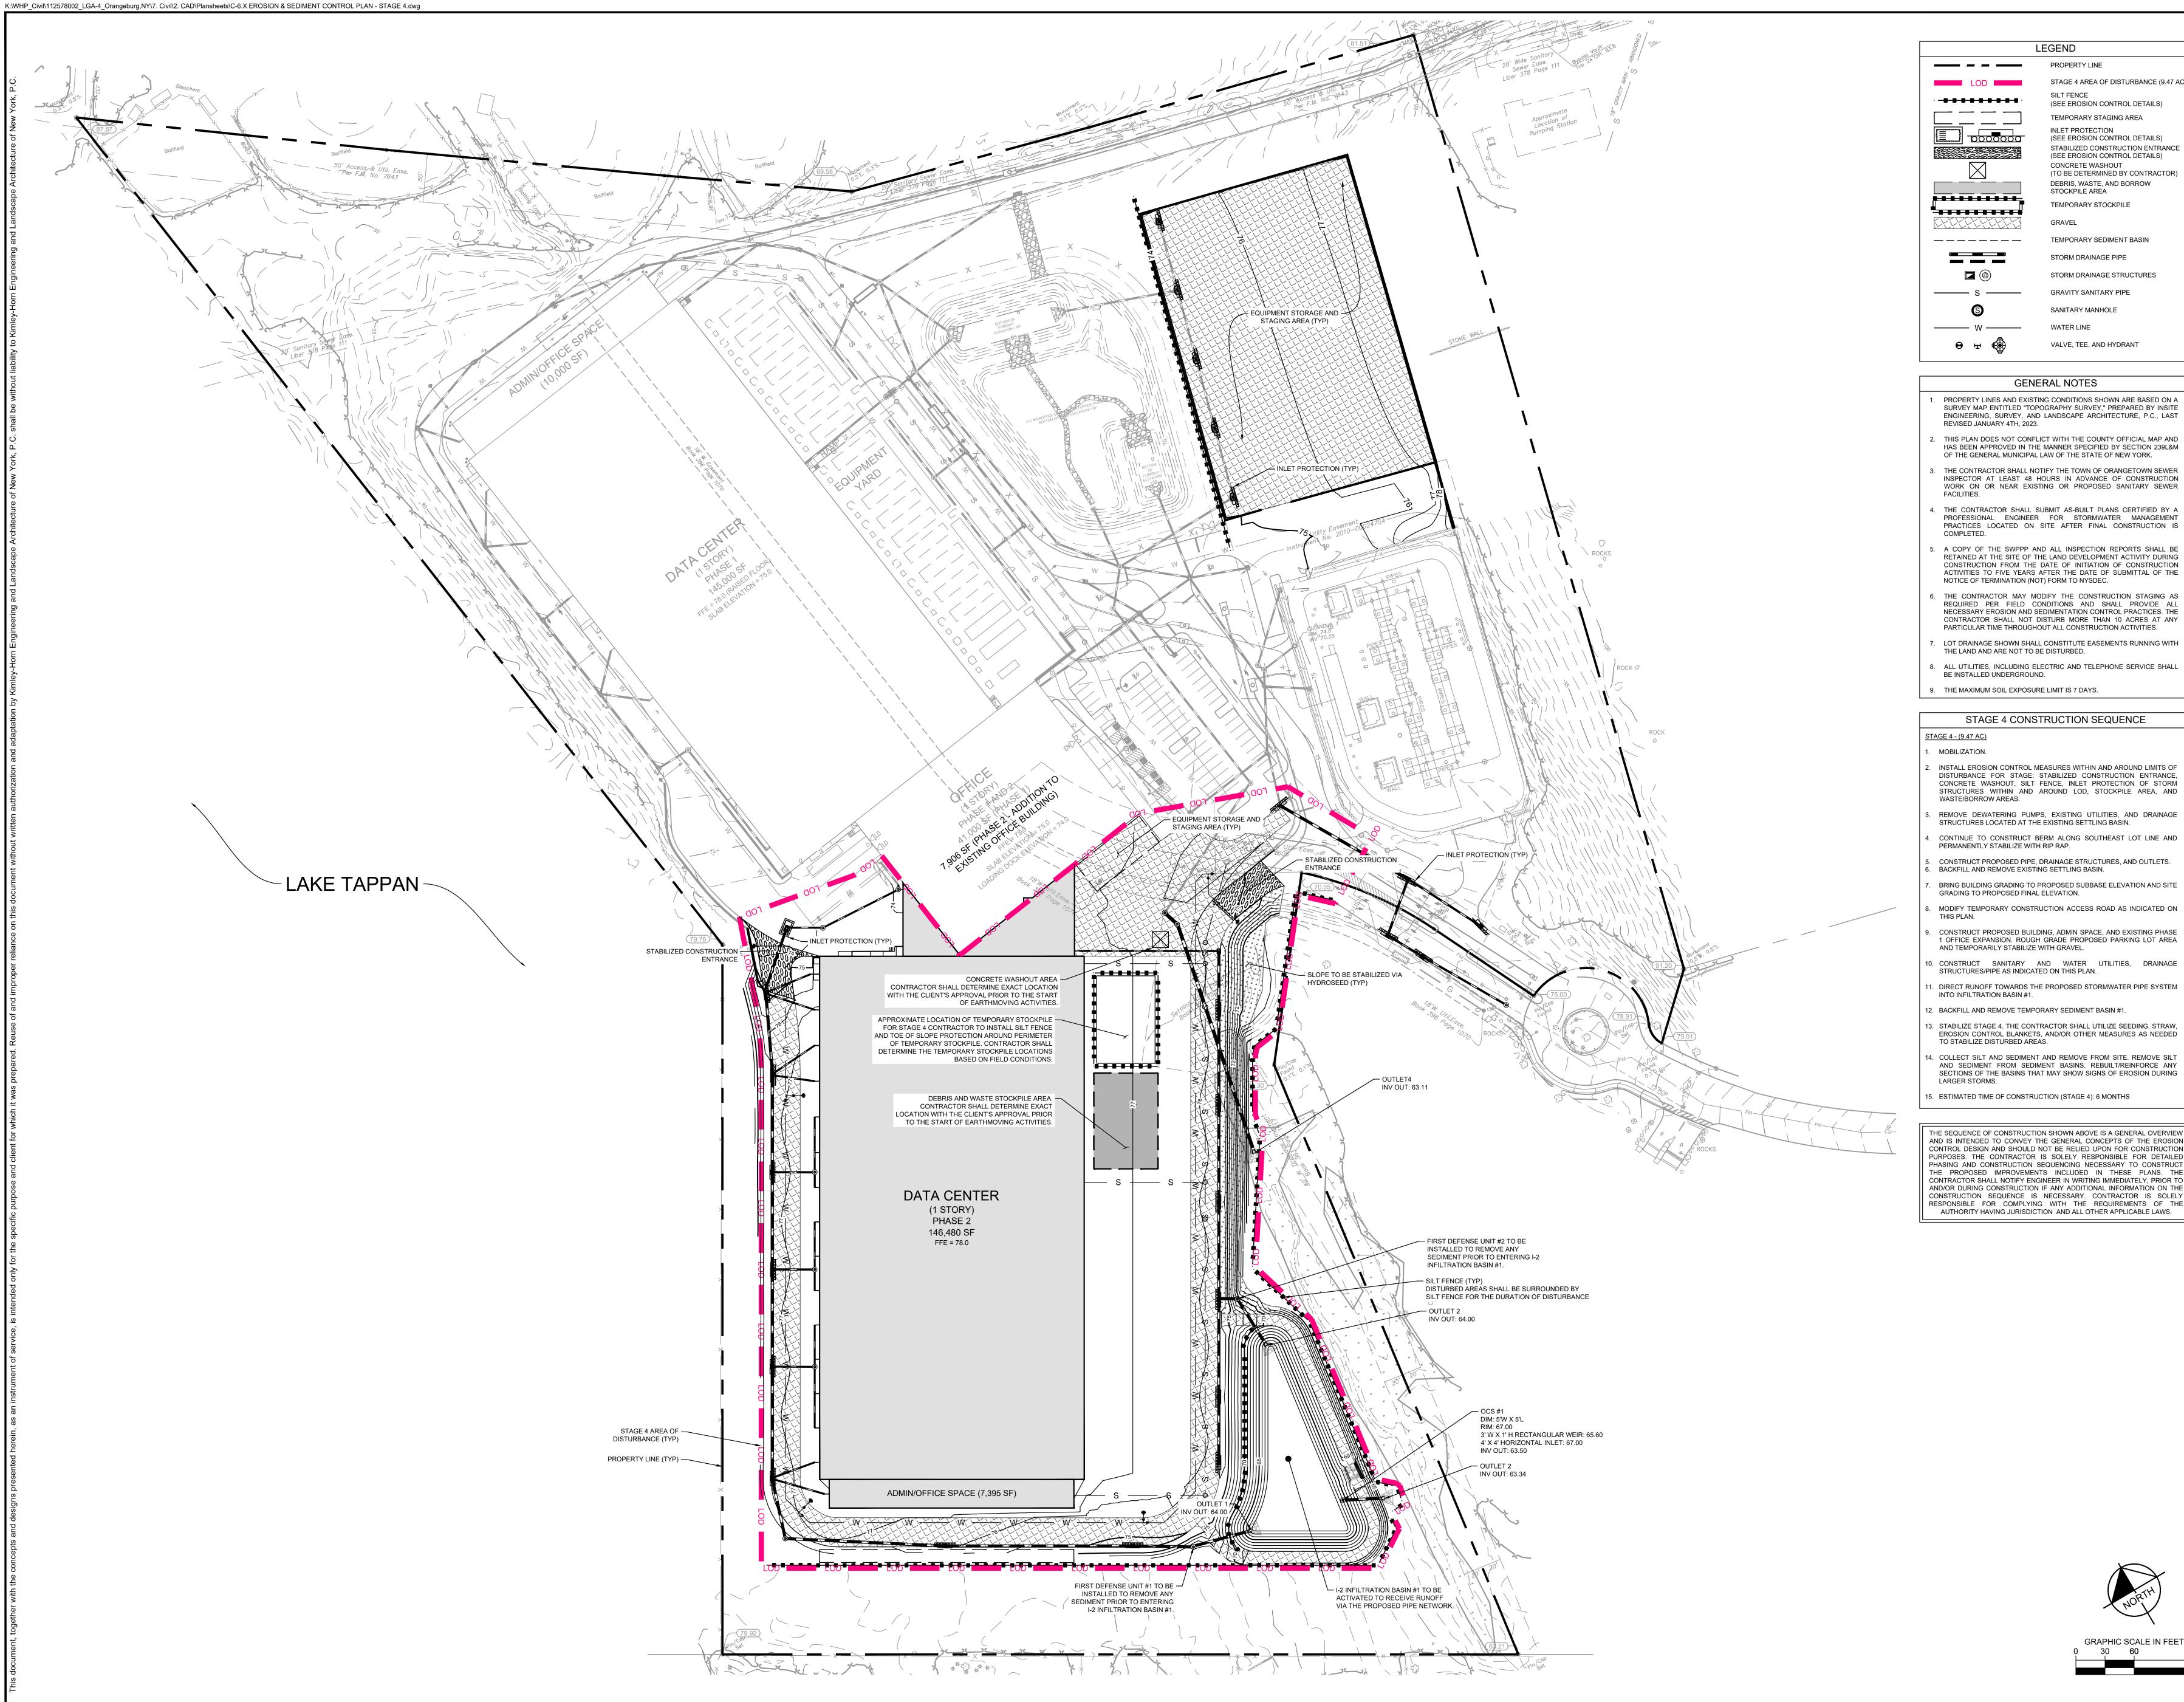
THE SEQUENCE OF CONSTRUCTION SHOWN ABOVE IS A GENERAL OVERVIEW AND IS INTENDED TO CONVEY THE GENERAL CONCEPTS OF THE EROSION CONTROL DESIGN AND SHOULD NOT BE RELIED UPON FOR CONSTRUCTION PURPOSES. THE CONTRACTOR IS SOLELY RESPONSIBLE FOR DETAILED PHASING AND CONSTRUCTION SEQUENCING NECESSARY TO CONSTRUCT THE PROPOSED IMPROVEMENTS INCLUDED IN THESE PLANS. THE CONTRACTOR SHALL NOTIFY ENGINEER IN WRITING IMMEDIATELY, PRIOR TO AND/OR DURING CONSTRUCTION IF ANY ADDITIONAL INFORMATION ON THE CONSTRUCTION SEQUENCE IS NECESSARY. CONTRACTOR IS SOLELY RESPONSIBLE FOR COMPLYING WITH THE REQUIREMENTS OF THE



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STAGE 4 AREA OF DISTURBANCE (9.47 AC) (SEE EROSION CONTROL DETAILS) TEMPORARY STAGING AREA (SEE EROSION CONTROL DETAILS) STABILIZED CONSTRUCTION ENTRANCE (SEE EROSION CONTROL DETAILS) CONCRETE WASHOUT (TO BE DETERMINED BY CONTRACTOR) DEBRIS, WASTE, AND BORROW TEMPORARY STOCKPILE TEMPORARY SEDIMENT BASIN STORM DRAINAGE PIPE STORM DRAINAGE STRUCTURES GRAVITY SANITARY PIPE VALVE, TEE, AND HYDRANT

> PROPERTY LINES AND EXISTING CONDITIONS SHOWN ARE BASED ON A SURVEY MAP ENTITLED "TOPOGRAPHY SURVEY," PREPARED BY INSITE ENGINEERING, SURVEY, AND LANDSCAPE ARCHITECTURE, P.C., LAST

- HAS BEEN APPROVED IN THE MANNER SPECIFIED BY SECTION 239L&M OF THE GENERAL MUNICIPAL LAW OF THE STATE OF NEW YORK.
- THE CONTRACTOR SHALL NOTIFY THE TOWN OF ORANGETOWN SEWER INSPECTOR AT LEAST 48 HOURS IN ADVANCE OF CONSTRUCTION
- WORK ON OR NEAR EXISTING OR PROPOSED SANITARY SEWER
- PROFESSIONAL ENGINEER FOR STORMWATER MANAGEMENT PRACTICES LOCATED ON SITE AFTER FINAL CONSTRUCTION IS
- 5. A COPY OF THE SWPPP AND ALL INSPECTION REPORTS SHALL BE RETAINED AT THE SITE OF THE LAND DEVELOPMENT ACTIVITY DURING CONSTRUCTION FROM THE DATE OF INITIATION OF CONSTRUCTION ACTIVITIES TO FIVE YEARS AFTER THE DATE OF SUBMITTAL OF THE
- THE CONTRACTOR MAY MODIFY THE CONSTRUCTION STAGING AS REQUIRED PER FIELD CONDITIONS AND SHALL PROVIDE ALL NECESSARY EROSION AND SEDIMENTATION CONTROL PRACTICES. THE CONTRACTOR SHALL NOT DISTURB MORE THAN 10 ACRES AT ANY
- LOT DRAINAGE SHOWN SHALL CONSTITUTE EASEMENTS RUNNING WITH
- 8. ALL UTILITIES, INCLUDING ELECTRIC AND TELEPHONE SERVICE SHALL


### STAGE 4 CONSTRUCTION SEQUENCE

INSTALL EROSION CONTROL MEASURES WITHIN AND AROUND LIMITS OF DISTURBANCE FOR STAGE: STABILIZED CONSTRUCTION ENTRANCE, CONCRETE WASHOUT, SILT FENCE, INLET PROTECTION OF STORM STRUCTURES WITHIN AND AROUND LOD, STOCKPILE AREA, AND

- REMOVE DEWATERING PUMPS, EXISTING UTILITIES, AND DRAINAGE STRUCTURES LOCATED AT THE EXISTING SETTLING BASIN.
- CONTINUE TO CONSTRUCT BERM ALONG SOUTHEAST LOT LINE AND
- BRING BUILDING GRADING TO PROPOSED SUBBASE ELEVATION AND SITE
- MODIFY TEMPORARY CONSTRUCTION ACCESS ROAD AS INDICATED ON
- DIRECT RUNOFF TOWARDS THE PROPOSED STORMWATER PIPE SYSTEM
- B. STABILIZE STAGE 4. THE CONTRACTOR SHALL UTILIZE SEEDING, STRAW, EROSION CONTROL BLANKETS, AND/OR OTHER MEASURES AS NEEDED
- . COLLECT SILT AND SEDIMENT AND REMOVE FROM SITE. REMOVE SILT
- SECTIONS OF THE BASINS THAT MAY SHOW SIGNS OF EROSION DURING

THE SEQUENCE OF CONSTRUCTION SHOWN ABOVE IS A GENERAL OVERVIEW AND IS INTENDED TO CONVEY THE GENERAL CONCEPTS OF THE EROSION CONTROL DESIGN AND SHOULD NOT BE RELIED UPON FOR CONSTRUCTION PURPOSES. THE CONTRACTOR IS SOLELY RESPONSIBLE FOR DETAILED PHASING AND CONSTRUCTION SEQUENCING NECESSARY TO CONSTRUCT THE PROPOSED IMPROVEMENTS INCLUDED IN THESE PLANS. THE CONTRACTOR SHALL NOTIFY ENGINEER IN WRITING IMMEDIATELY, PRIOR TO AND/OR DURING CONSTRUCTION IF ANY ADDITIONAL INFORMATION ON THE CONSTRUCTION SEQUENCE IS NECESSARY. CONTRACTOR IS SOLELY RESPONSIBLE FOR COMPLYING WITH THE REQUIREMENTS OF THE AUTHORITY HAVING JURISDICTION AND ALL OTHER APPLICABLE LAWS.

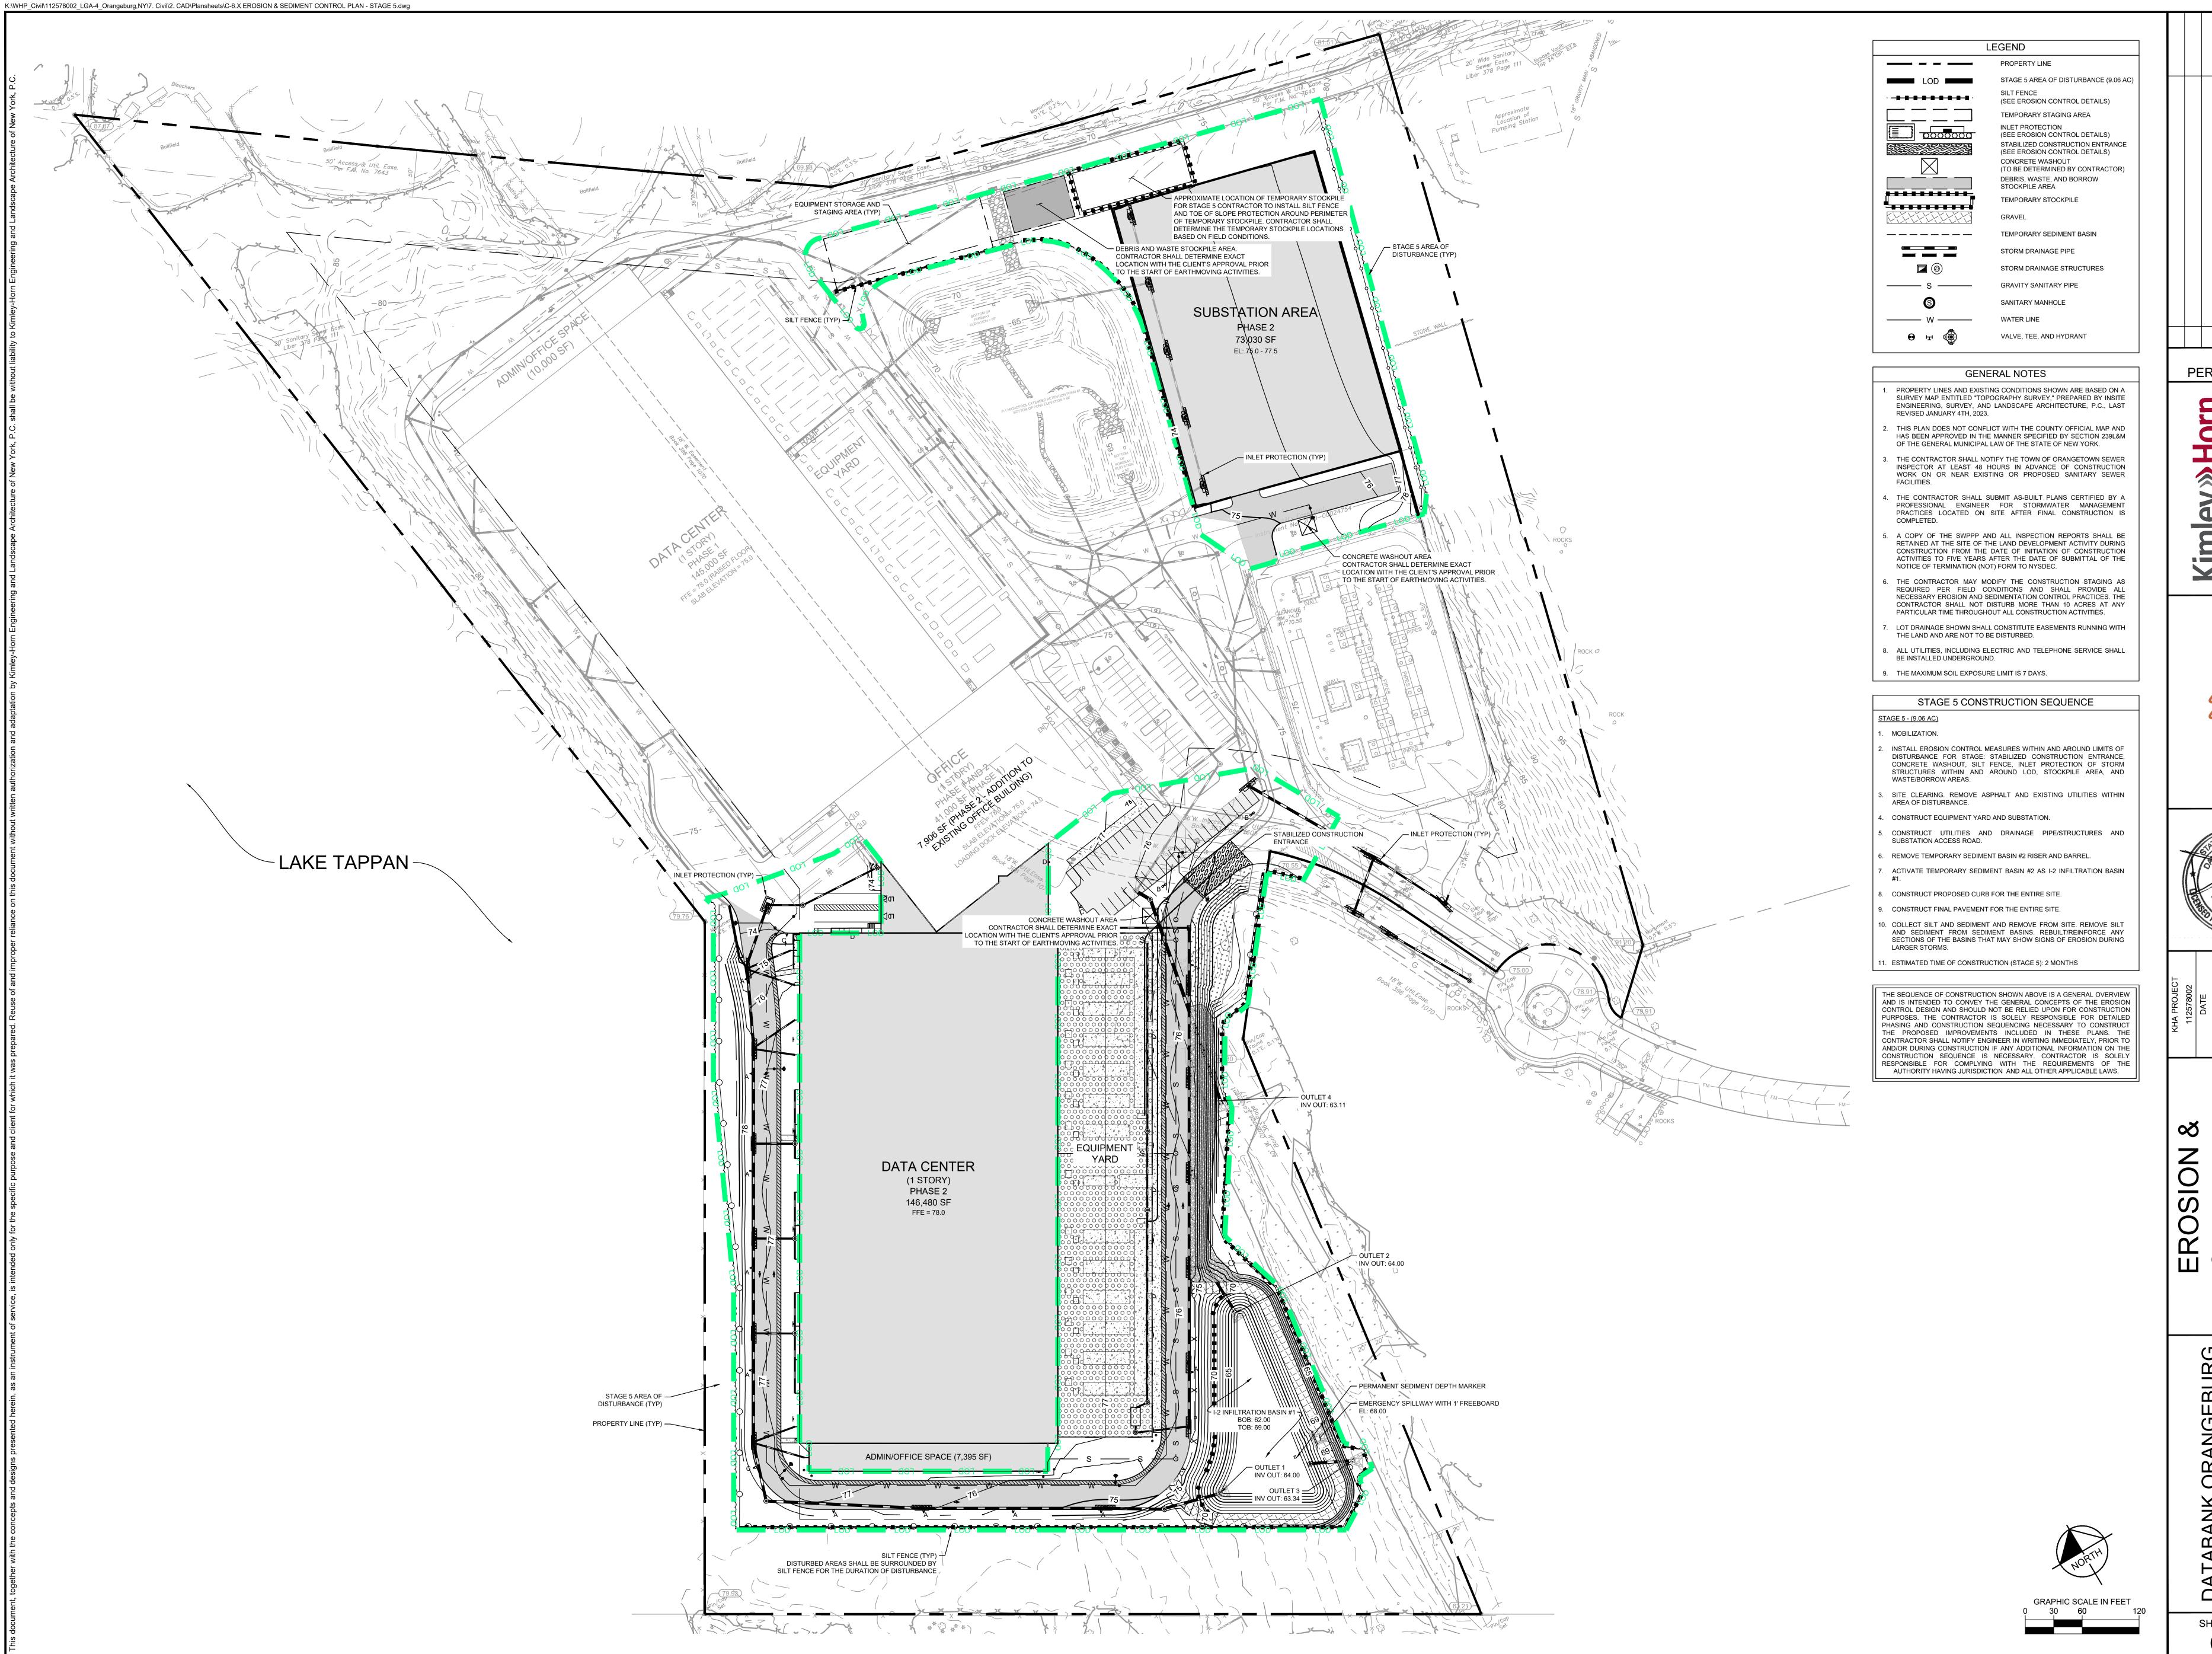PERMIT REVIEW

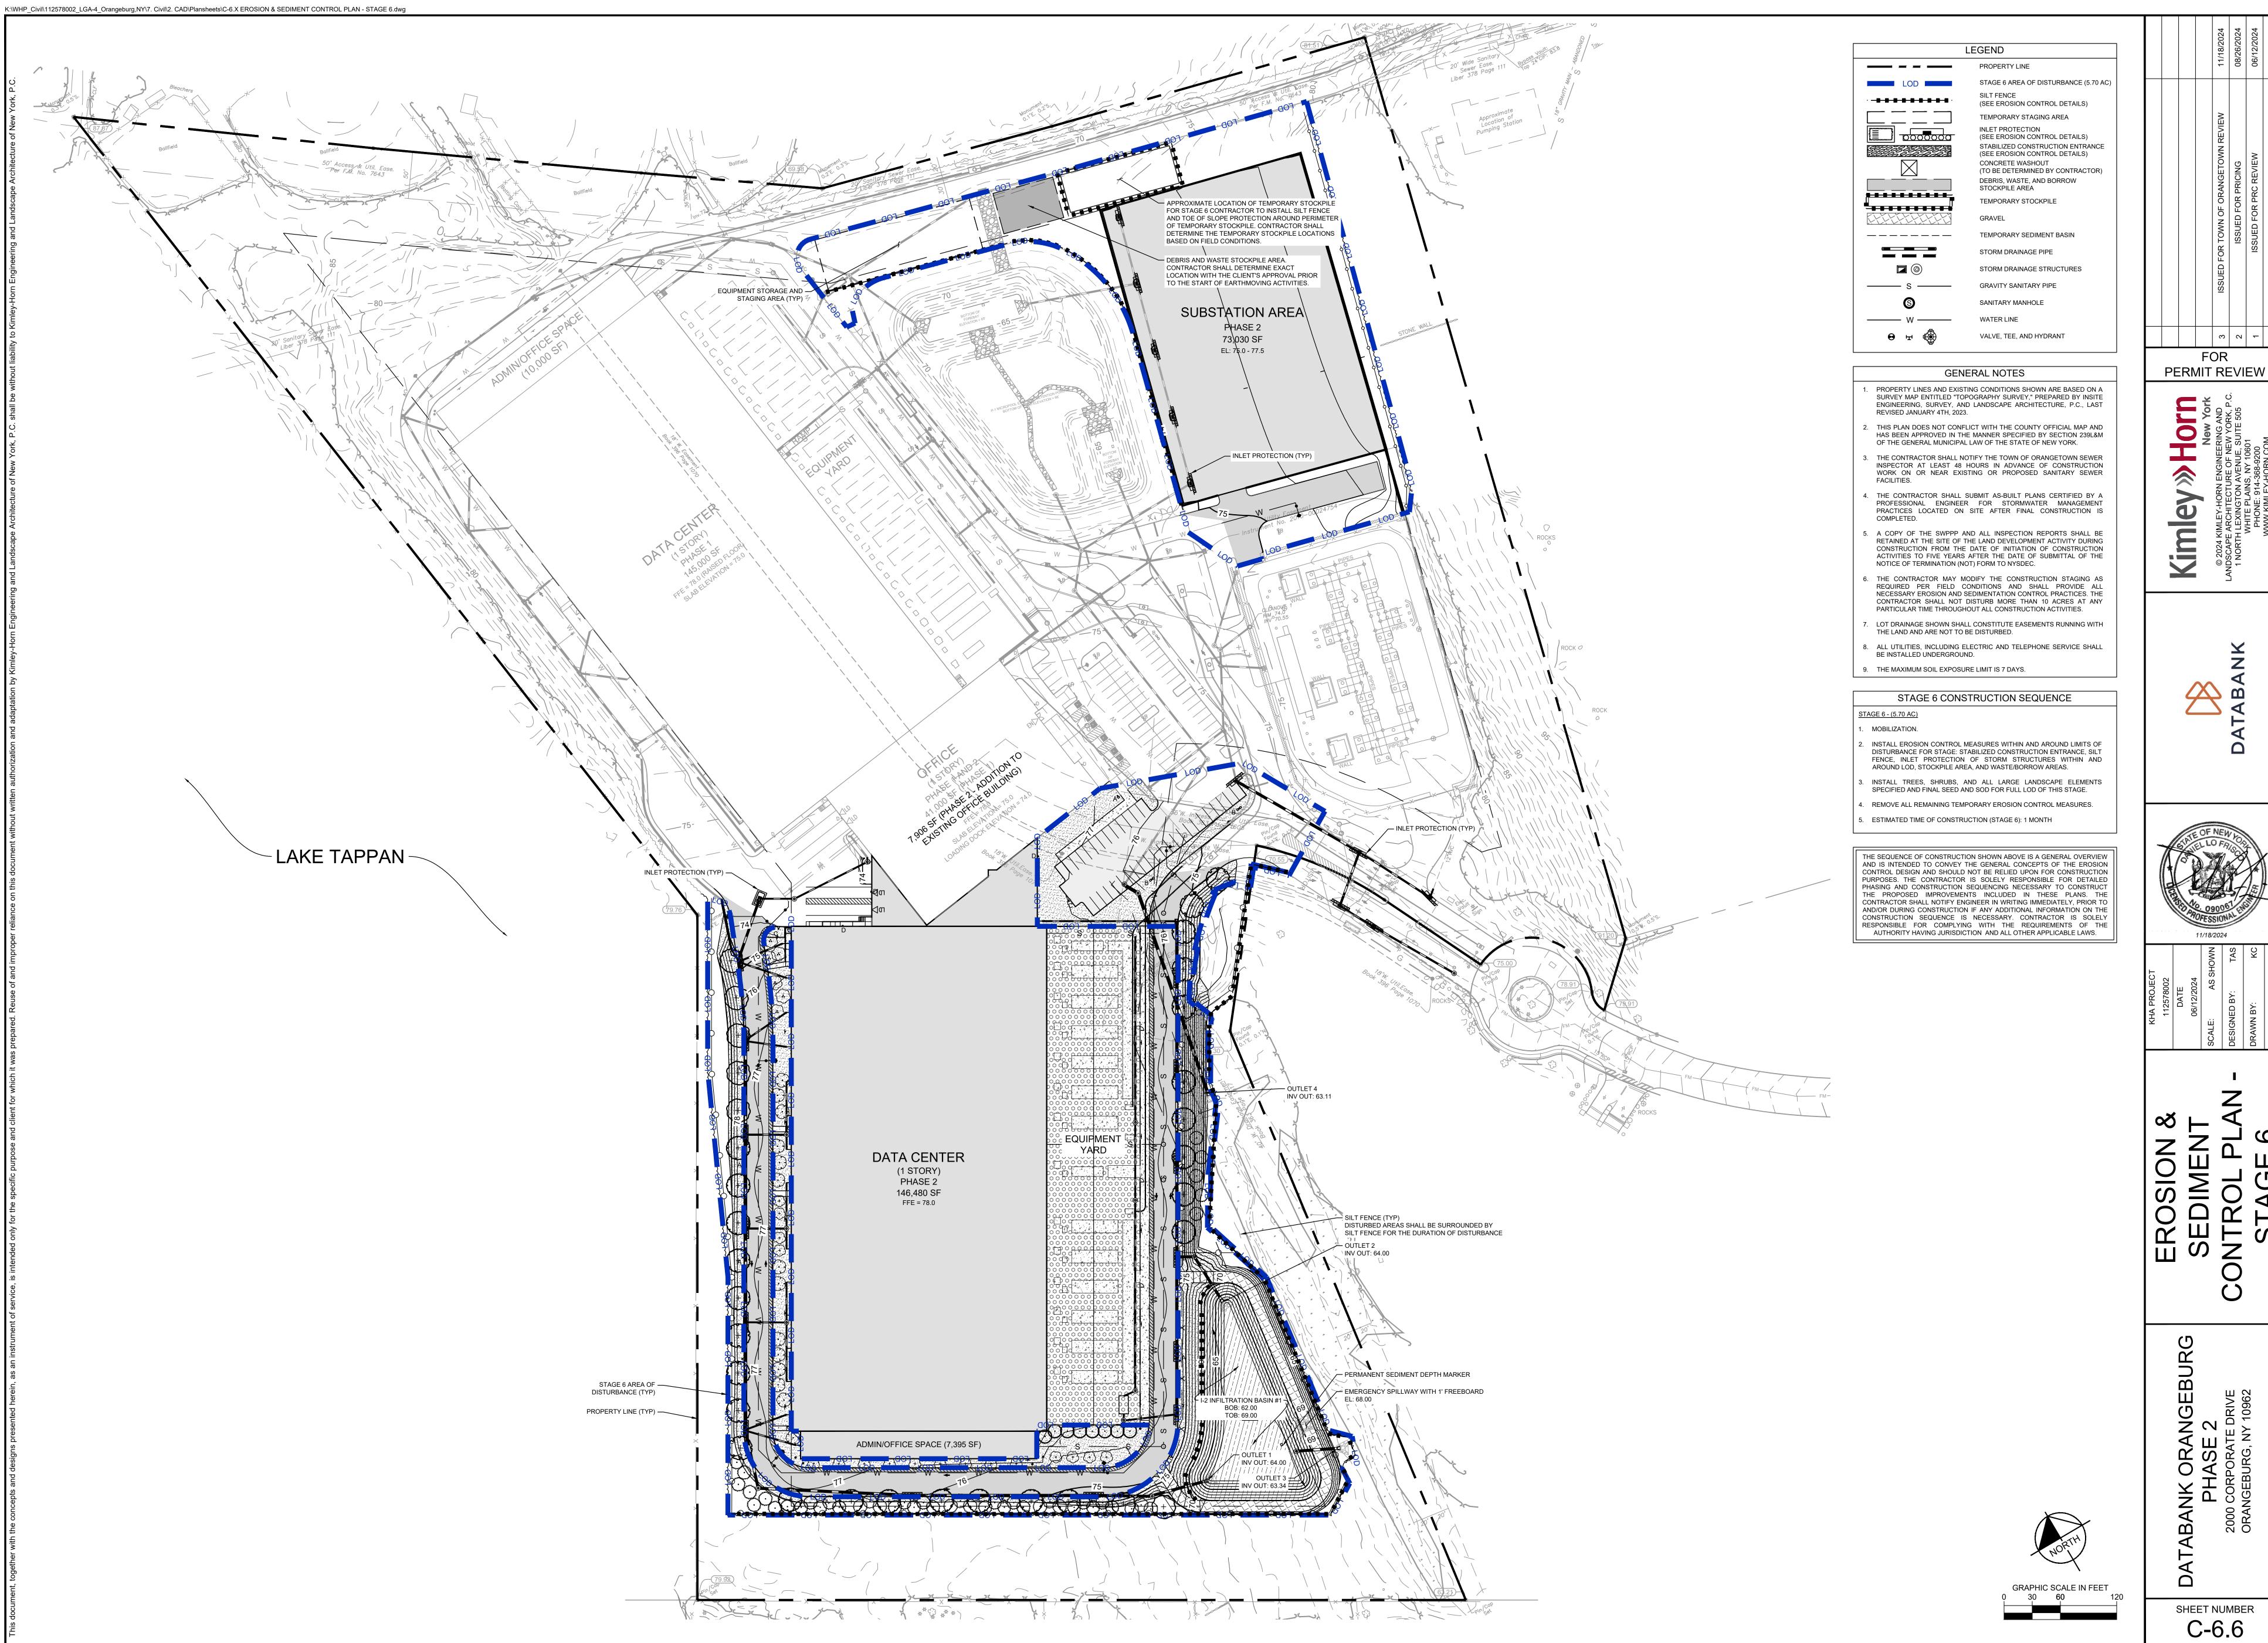


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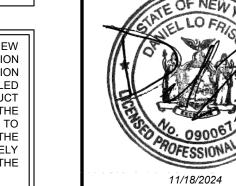
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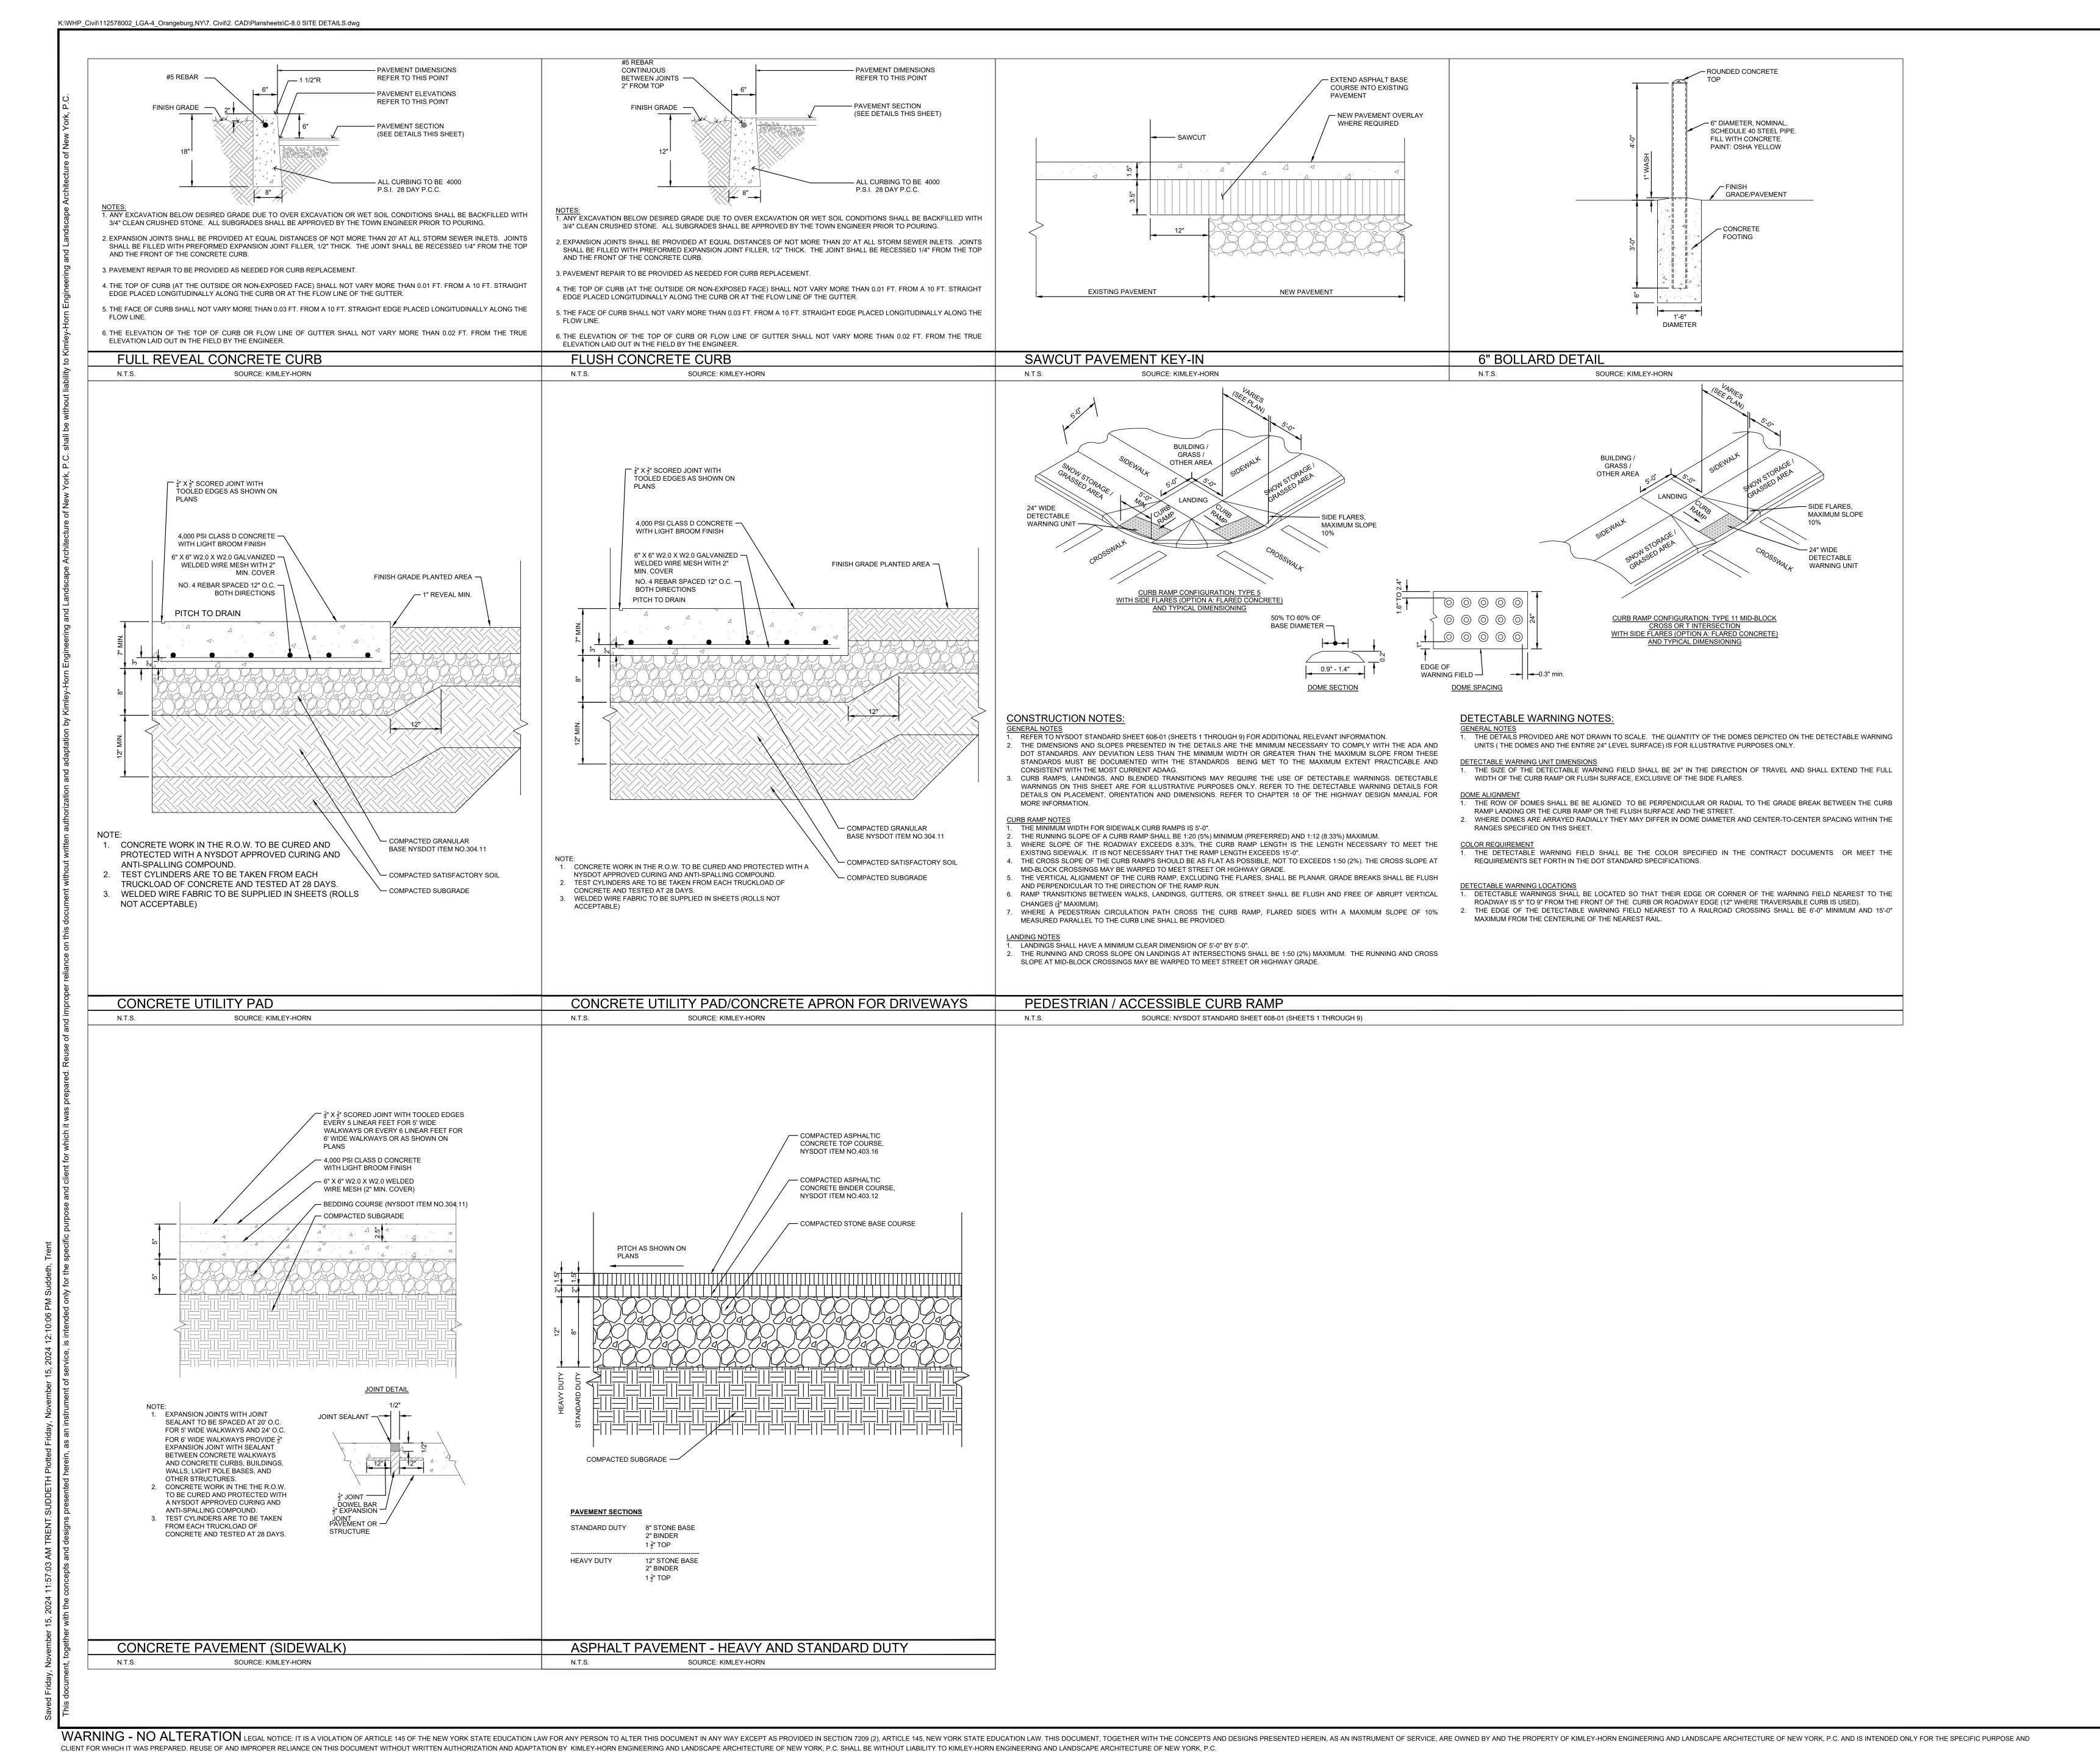




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HAD A ISSUED FOR TOWN OF ORANGETOWN REVIEW

ISSUED FOR PRICING

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NO. DESCRIPTION

New York

24 KIMLEY-HORN ENGINEERING AND
APE ARCHITECTURE OF NEW YORK, P.C.
RTH LEXINGTON AVENUE, SUITE 505
WHITE PLAINS, NY 10601
PHONE: 914-368-9200
WANNAK KIMI EY-HORN COM


ATABANK



DATE
06/12/2024
SCALE: AS SHOWN
DESIGNED BY: TAS
DRAWN BY: KC


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ORANGEBURG, NY 10962

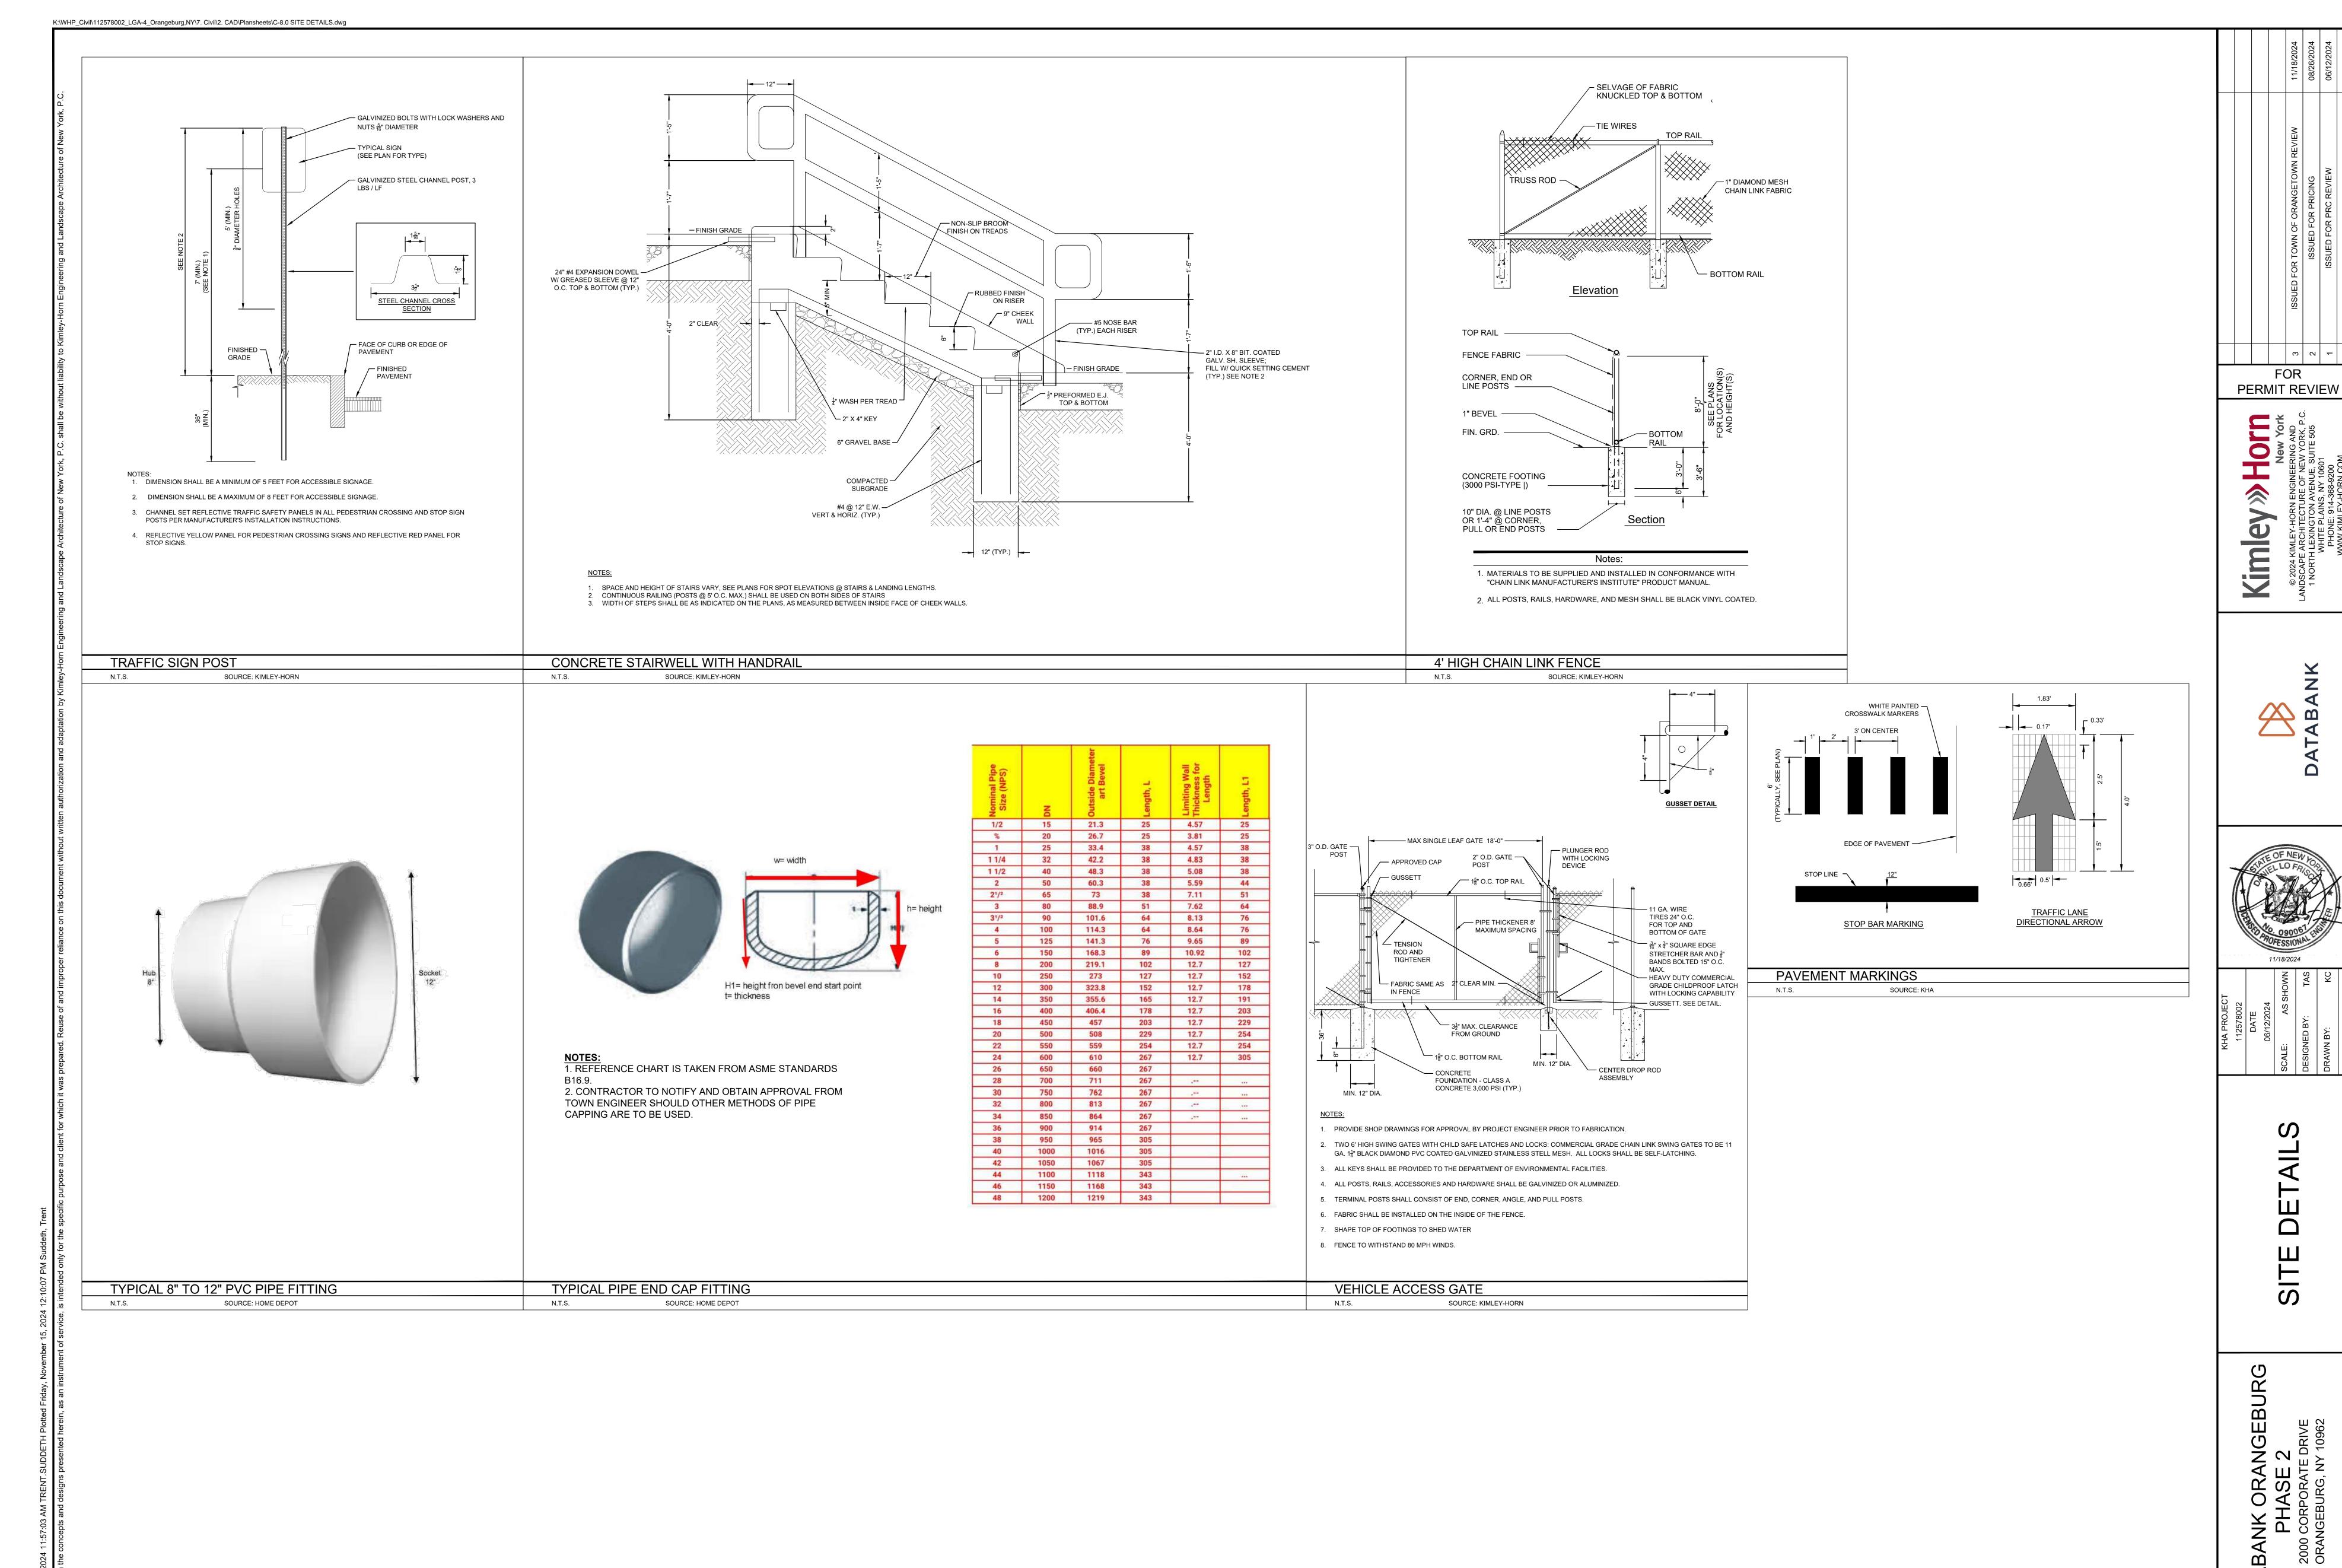C-7.0



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8" [203.2mm]

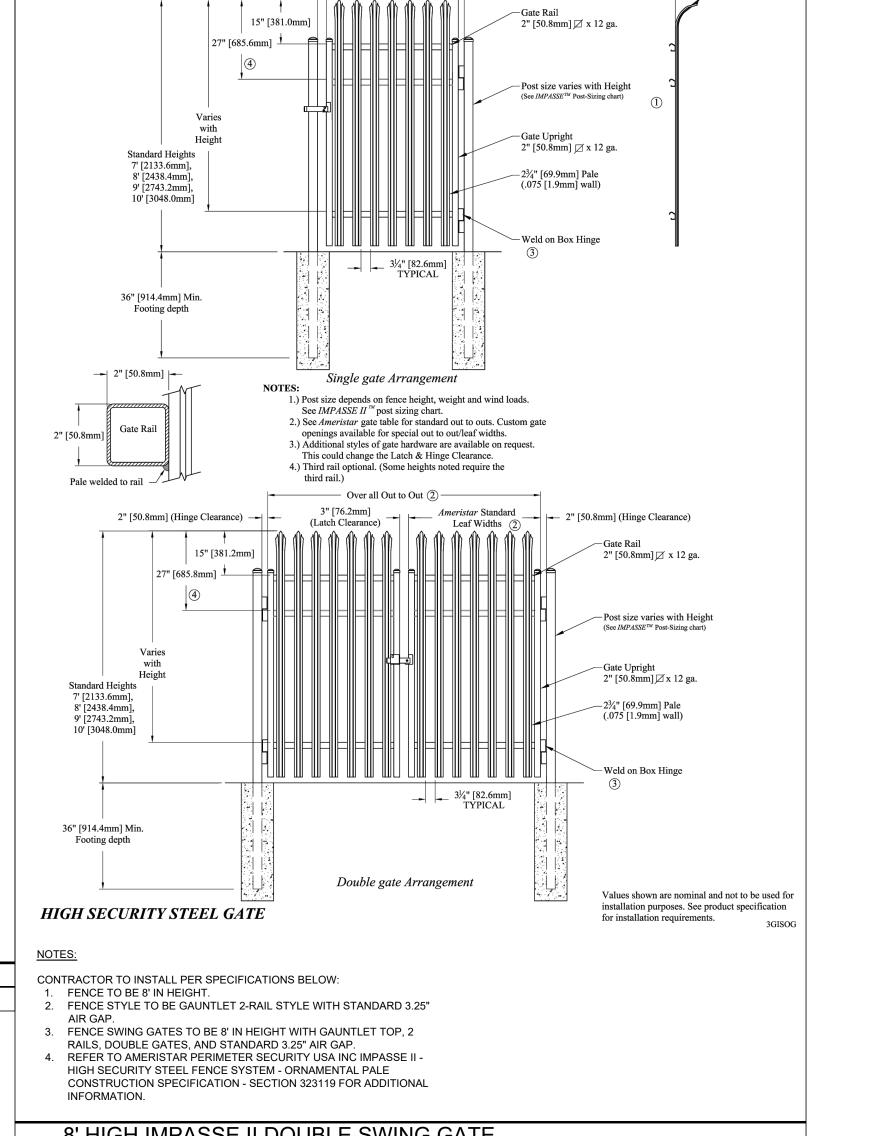2" [50.8mm] (Hinge Clearance)

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E



S

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 1" THICK COMPRESSIBLE JOINT FILLER MATERIAL

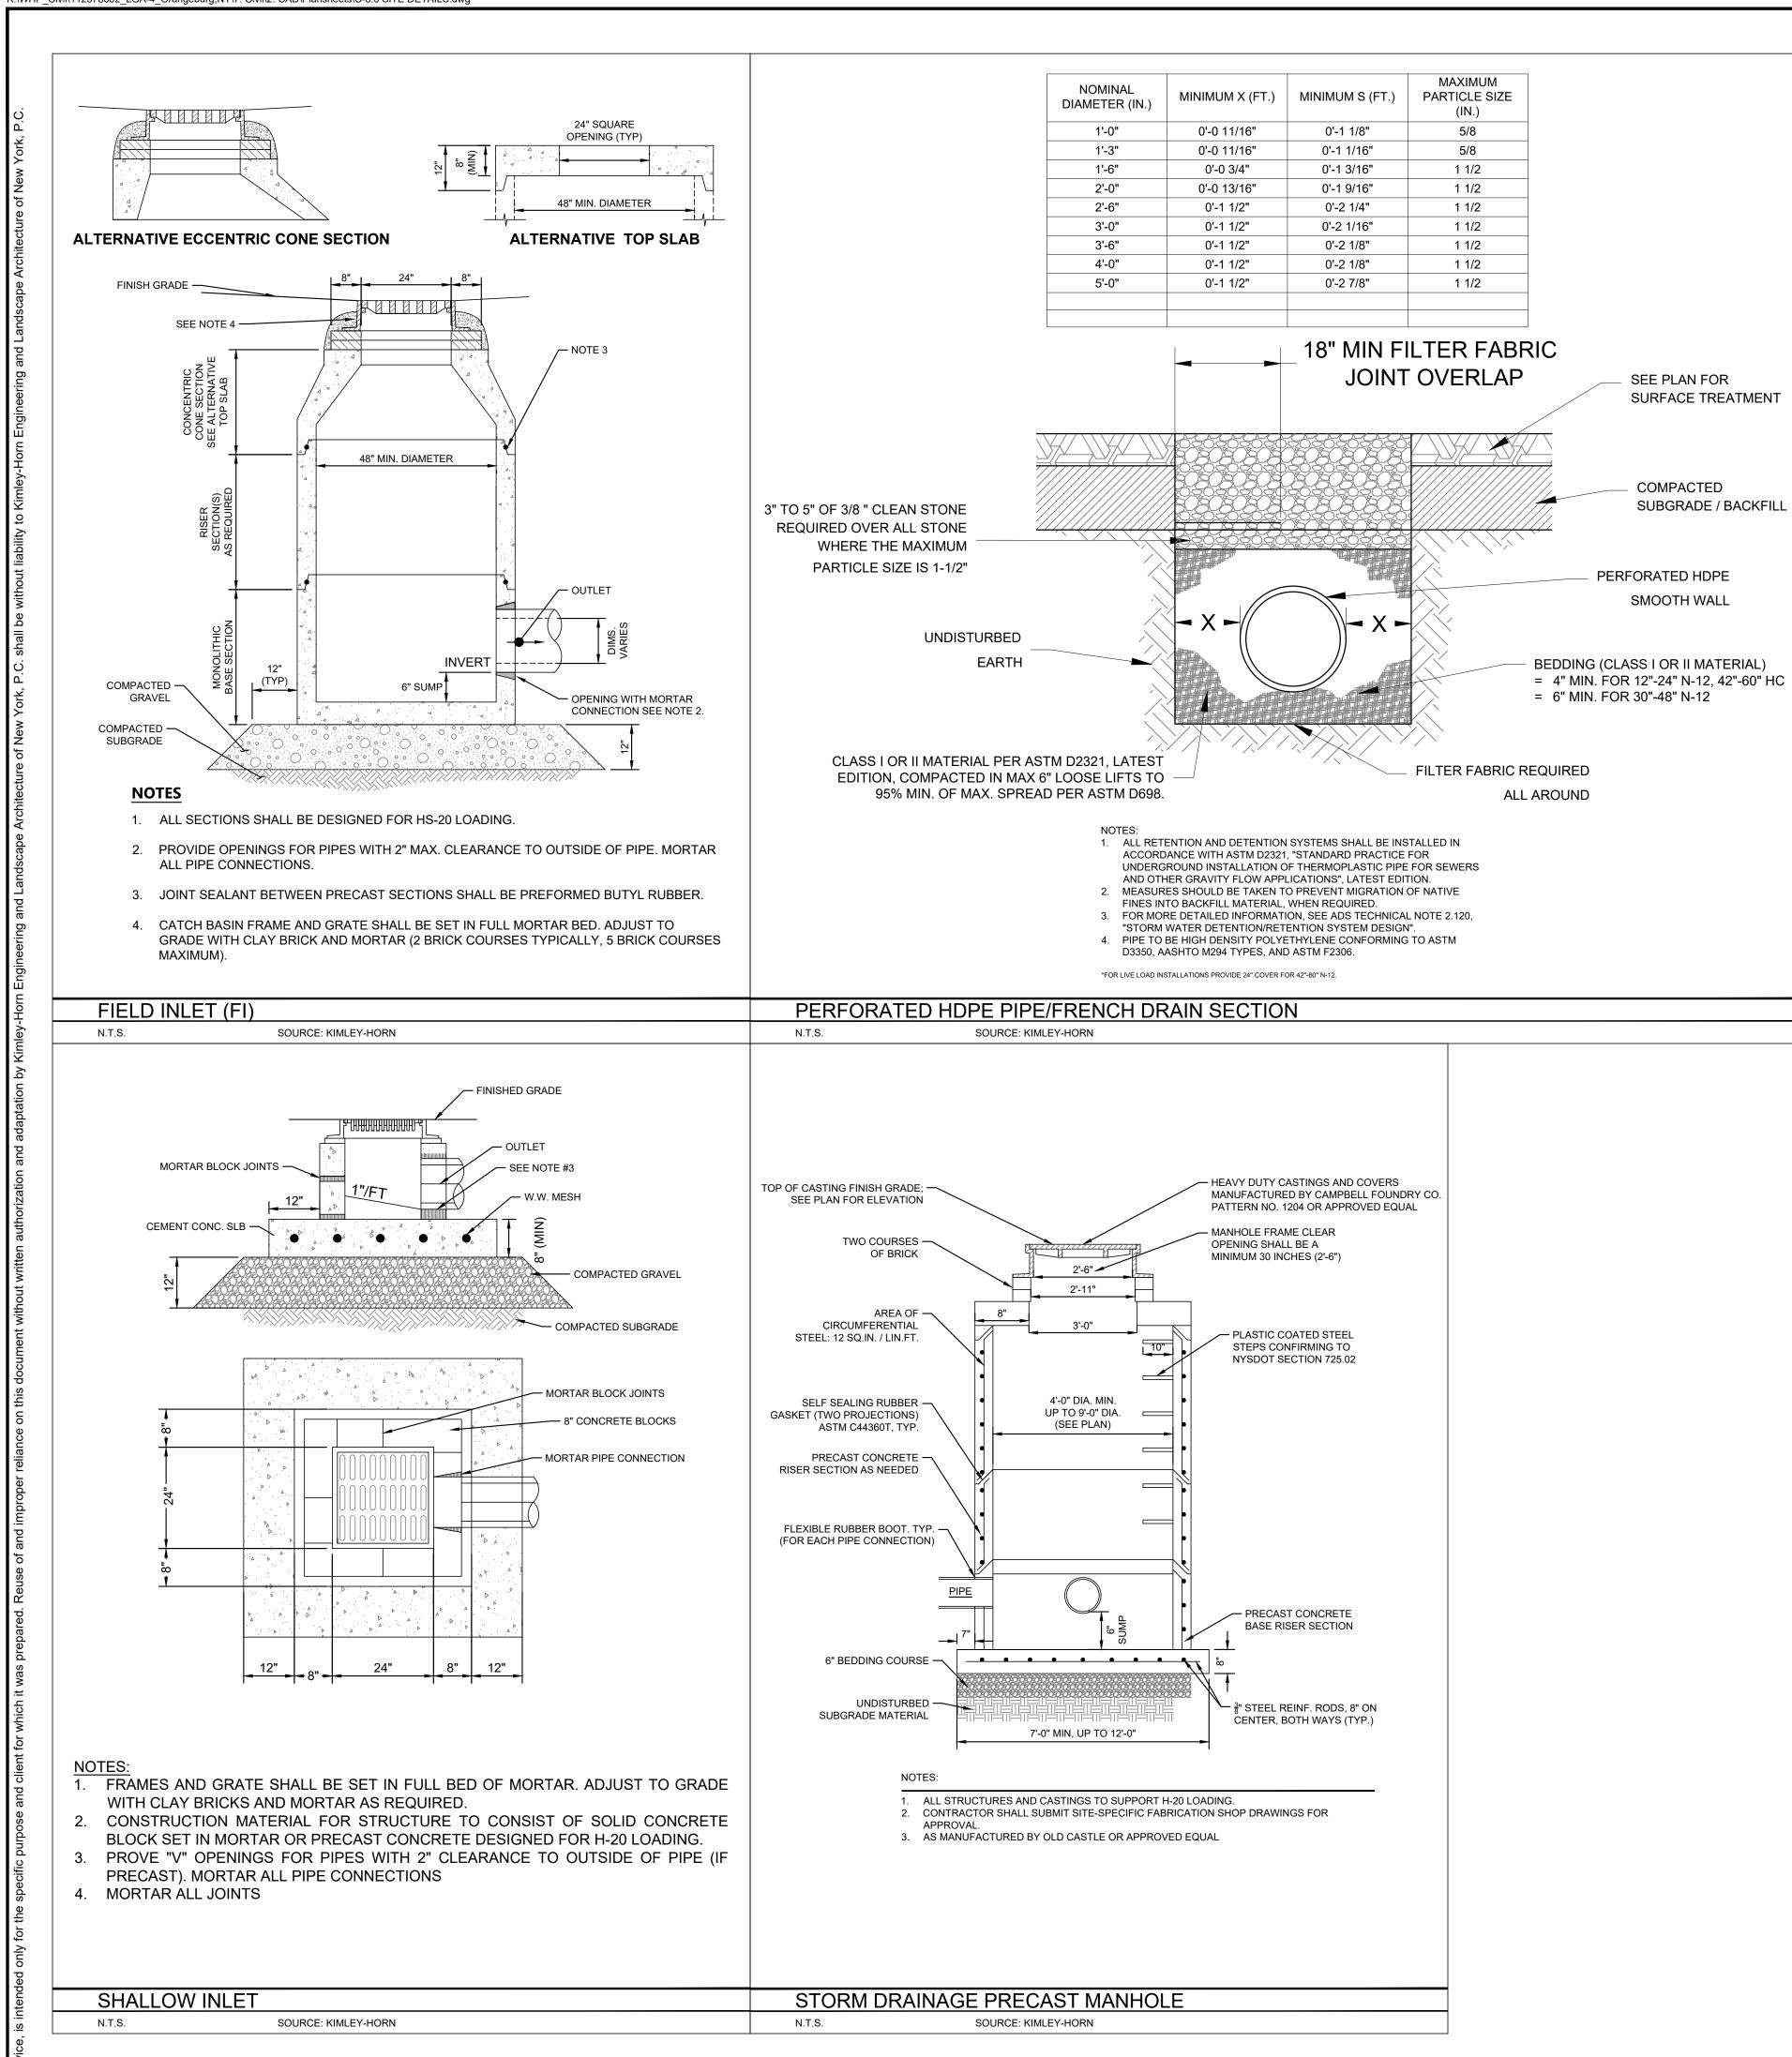
PROPOSED PIPELINE OVER EXIST PIPE

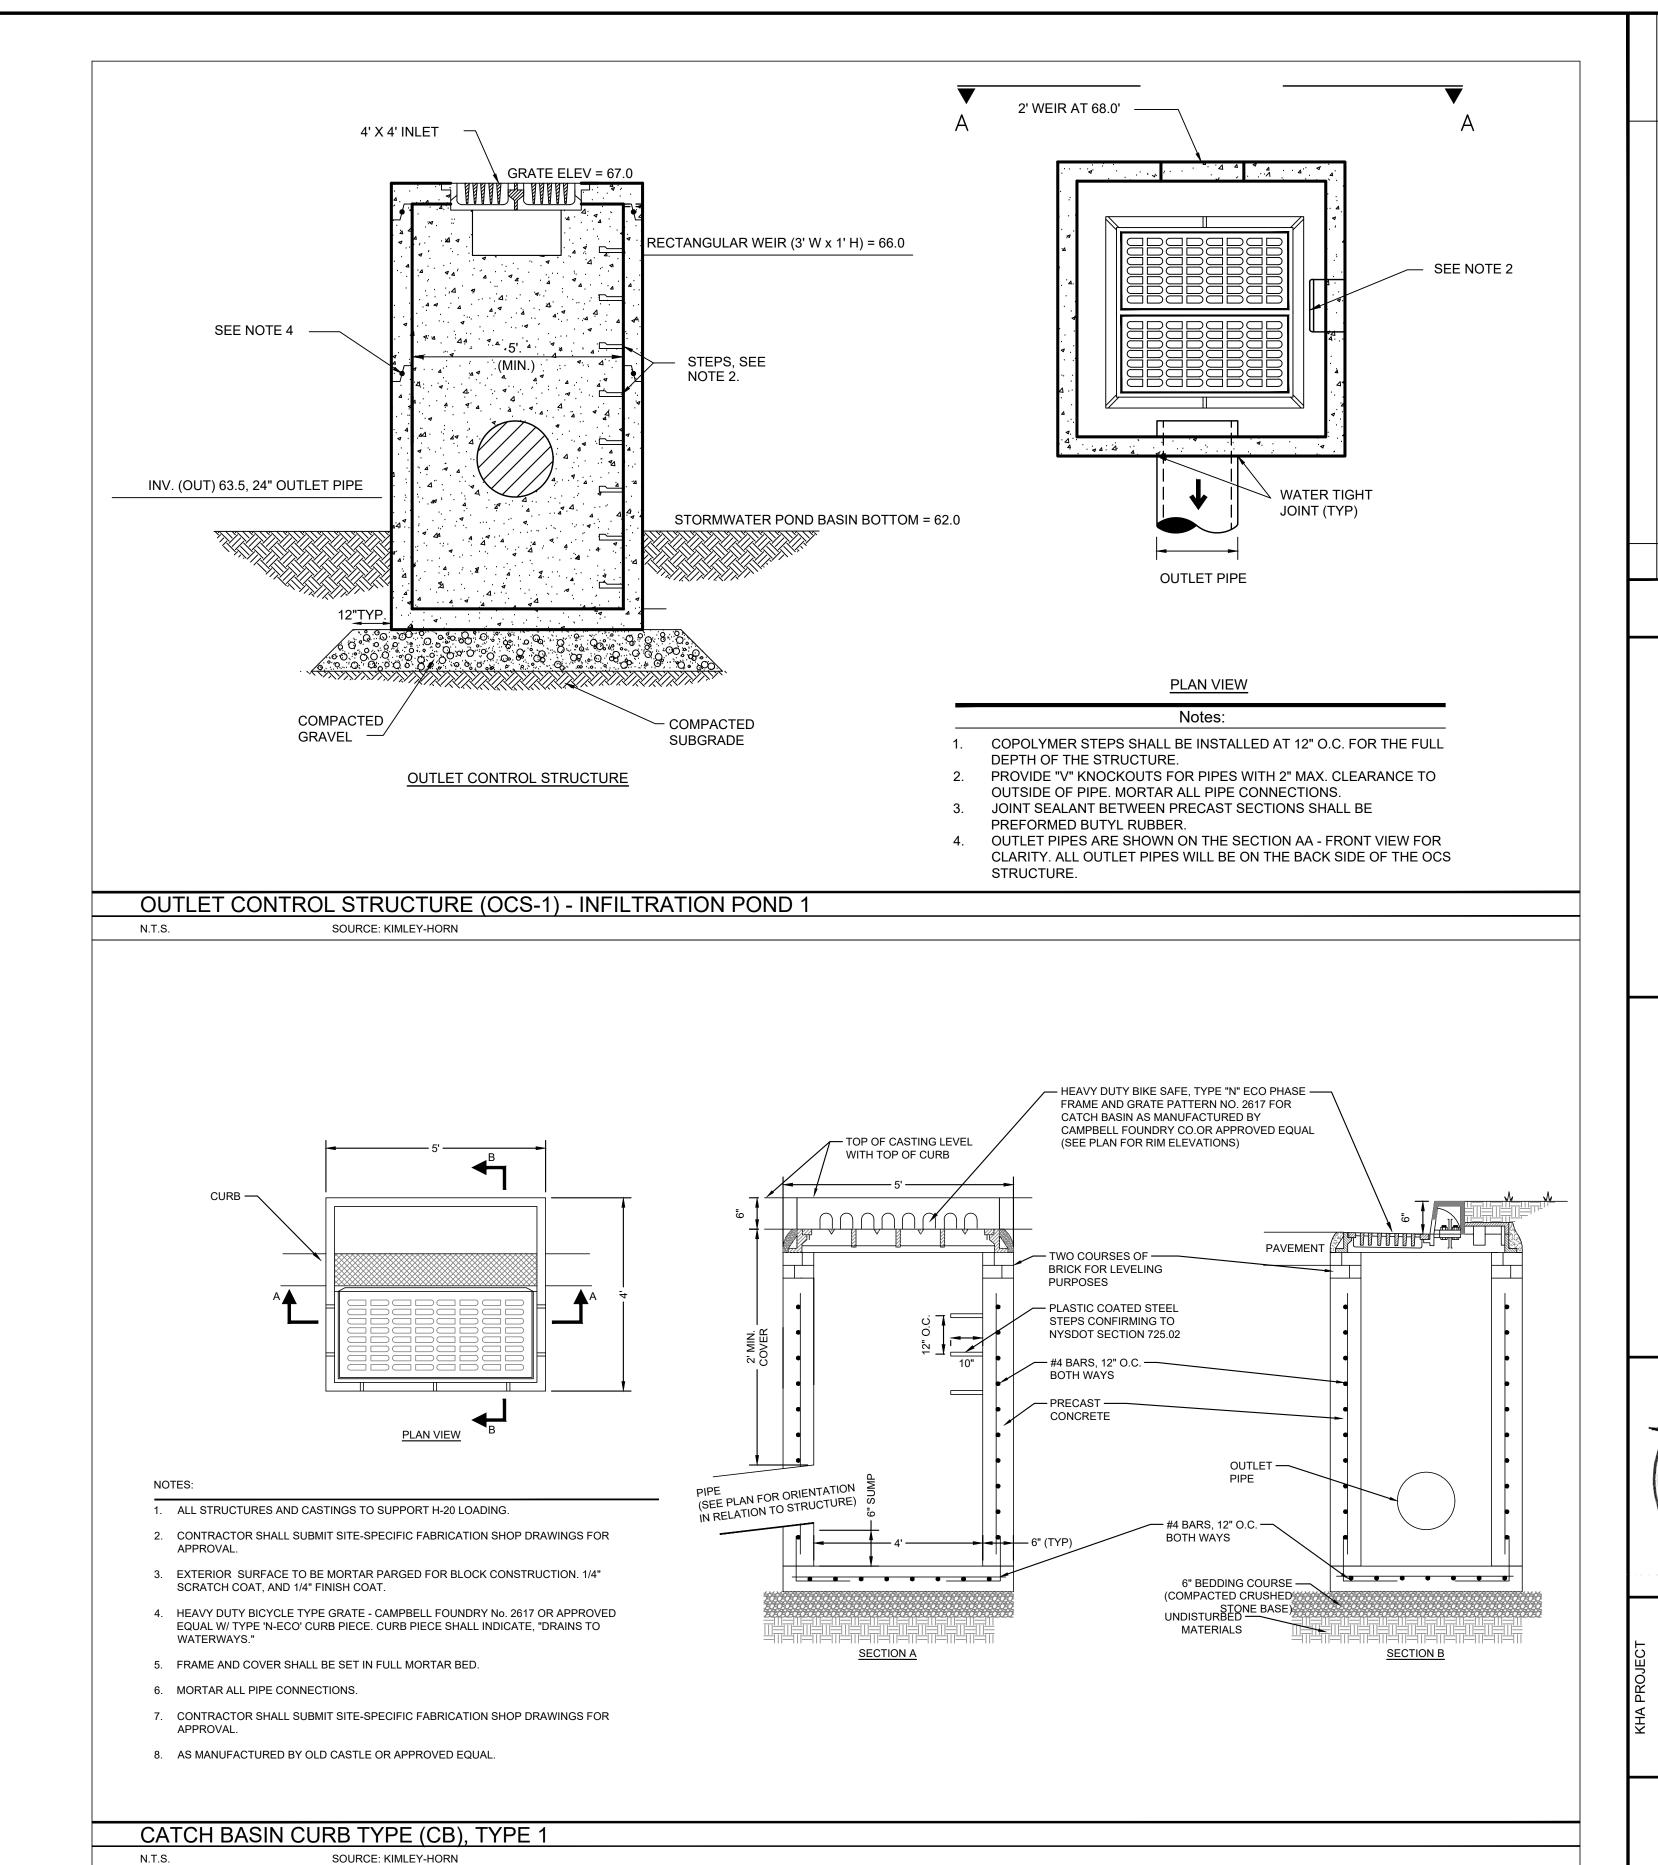
SOURCE: KIMLEY-HORN

TYPICAL PIPELINE CROSSING

N.T.S.

PROPOSED PIPELINE UNDER EXIST PIPE





HANDER TOWN OF ORANGETOWN REVIEW 1

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JF NEW YORK, P.C.
NUE, SUITE 505
Y 10601
RN.COM

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LANDSCAPE ARCHITECTURE OF NEW YC
1 NORTH LEXINGTON AVENUE, SUITE
WHITE PLAINS, NY 10601
PHONE: 914-368-9200

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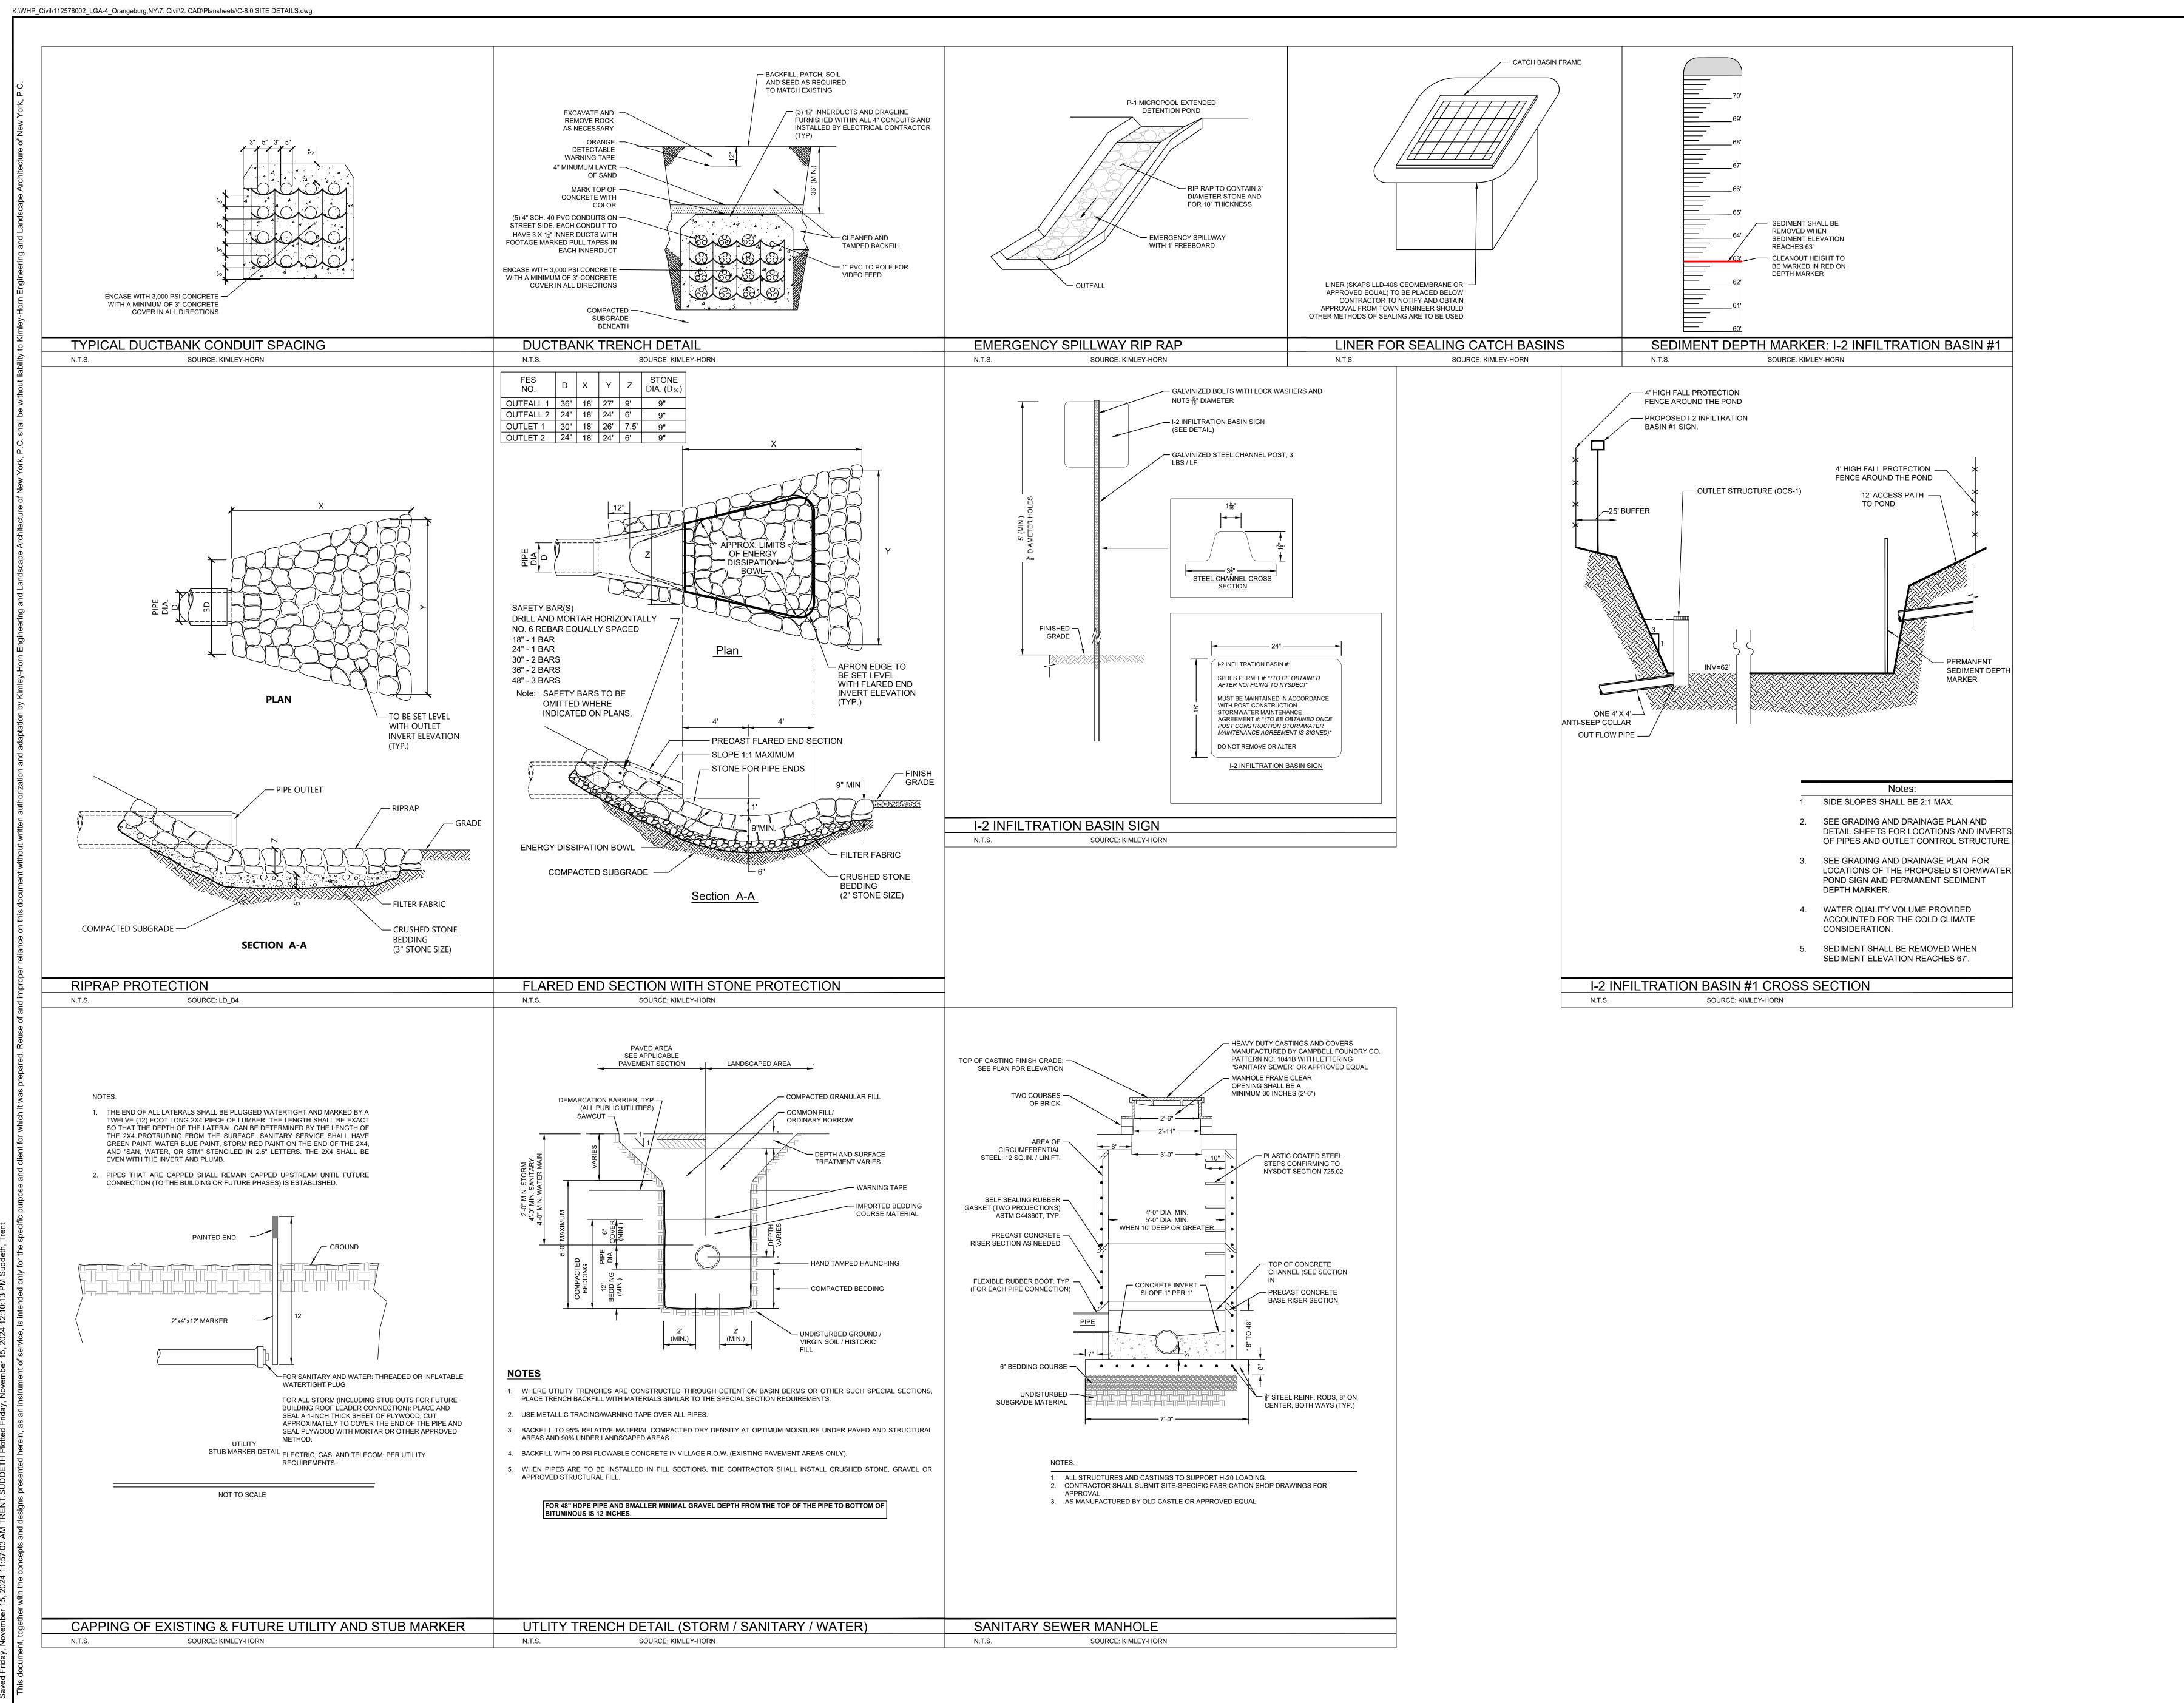
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DETAILS

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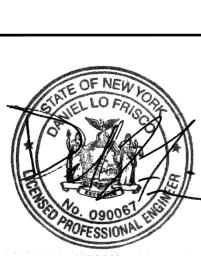
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NO. DESCRIPTION

New York
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ANDSCAPE ARCHITECTURE OF NEW YORK, P.C.
1 NORTH LEXINGTON AVENUE, SUITE 505
WHITE PLAINS, NY 10601
PHONE: 914-368-9200
WWWW.KIMLEY-HORN.COM

DATABANK



DATE

06/12/2024

SCALE: AS SHOWN
DESIGNED BY: TAS

DRAWN BY: KC

AILS

BESIG

SITE DETAIL


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C-7.4

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SOURCE: VEOLIA WATER


N.T.S.



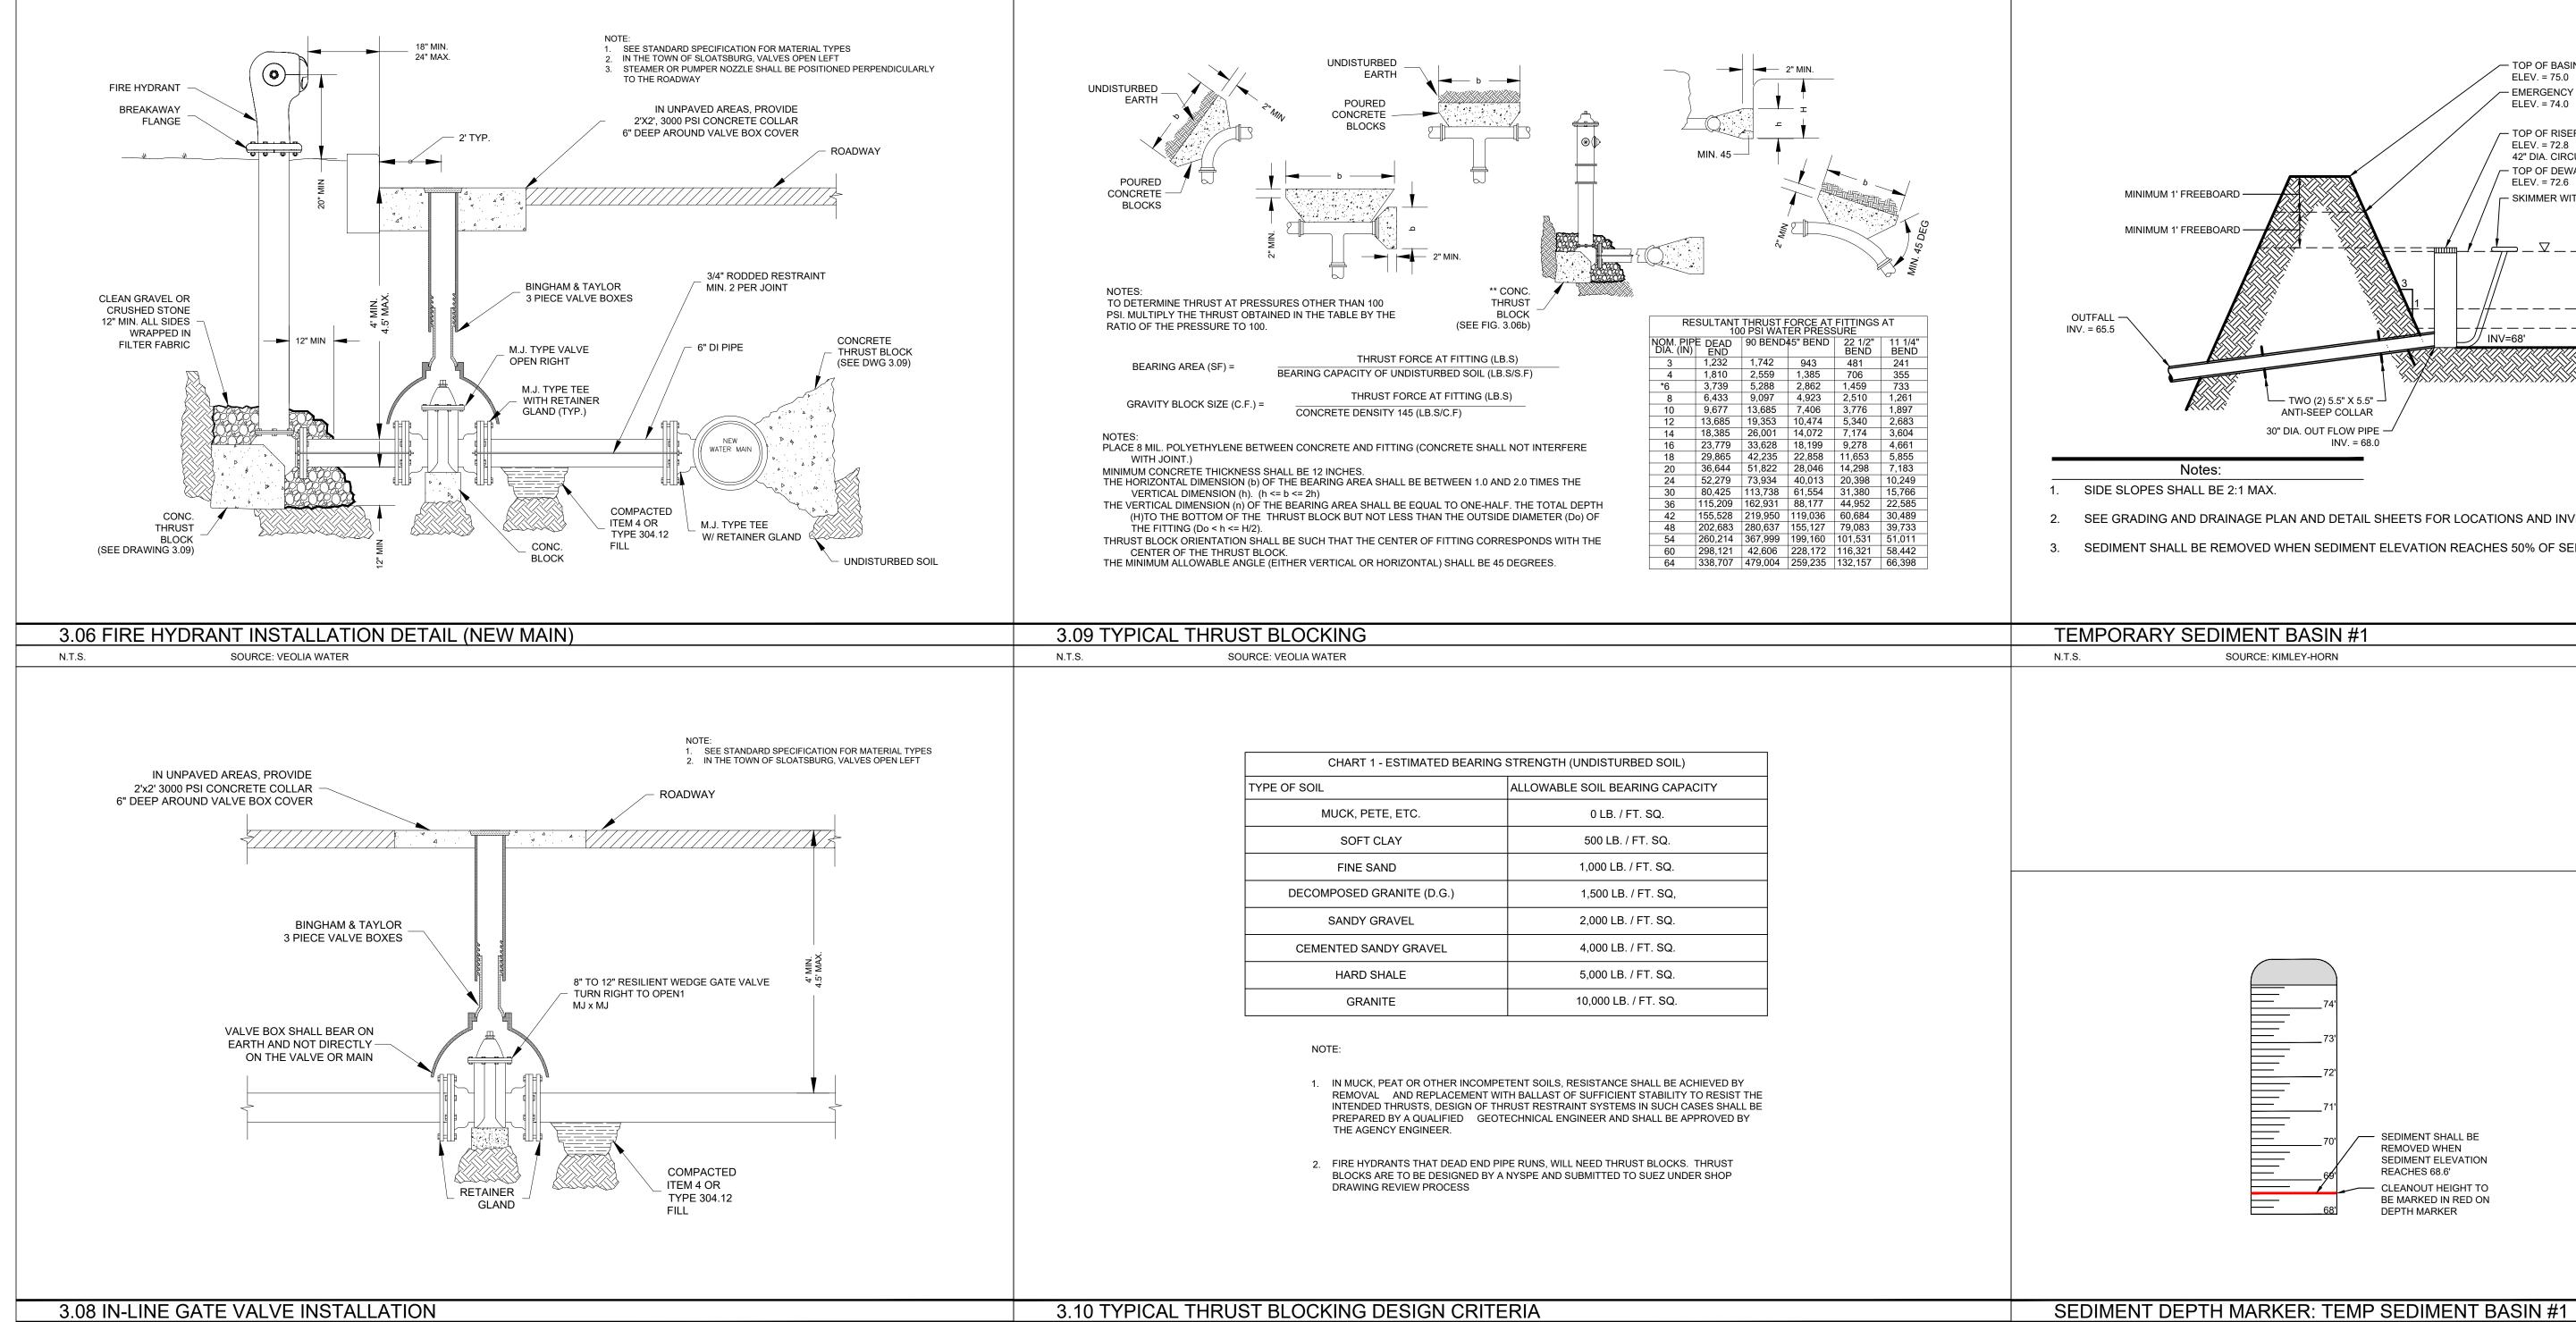SOURCE: VEOLIA WATER

N.T.S.

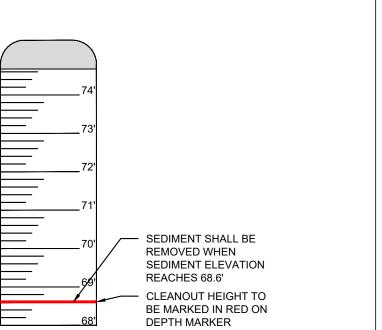— TOP OF BASIN ELEV. = 75.0 — EMERGENCY SPILLWAY ELEV. = 74.0 - TOP OF RISER ELEV. = 72.8 42" DIA. CIRCULAR — TOP OF DEWATERING ZONE ELEV. = 72.6 - SKIMMER WITH 5" ORIFICE OPENING *\-----* SEDIMENT DEPTH MARKER - TOP OF SEDIMENT STORAGE ZONE ELEV. = 69.1 - 50% SEDIMENT CLEAN OUT ELEV. = 68.6 2. SEE GRADING AND DRAINAGE PLAN AND DETAIL SHEETS FOR LOCATIONS AND INVERTS OF PIPES AND RISER. 3. SEDIMENT SHALL BE REMOVED WHEN SEDIMENT ELEVATION REACHES 50% OF SEDIMENT STORAGE ZONE DEPTH.




SEDIMENT DEPTH MARKER: TEMP SEDIMENT BASIN #1

N.T.S. SOURCE: KIMLEY-HORN

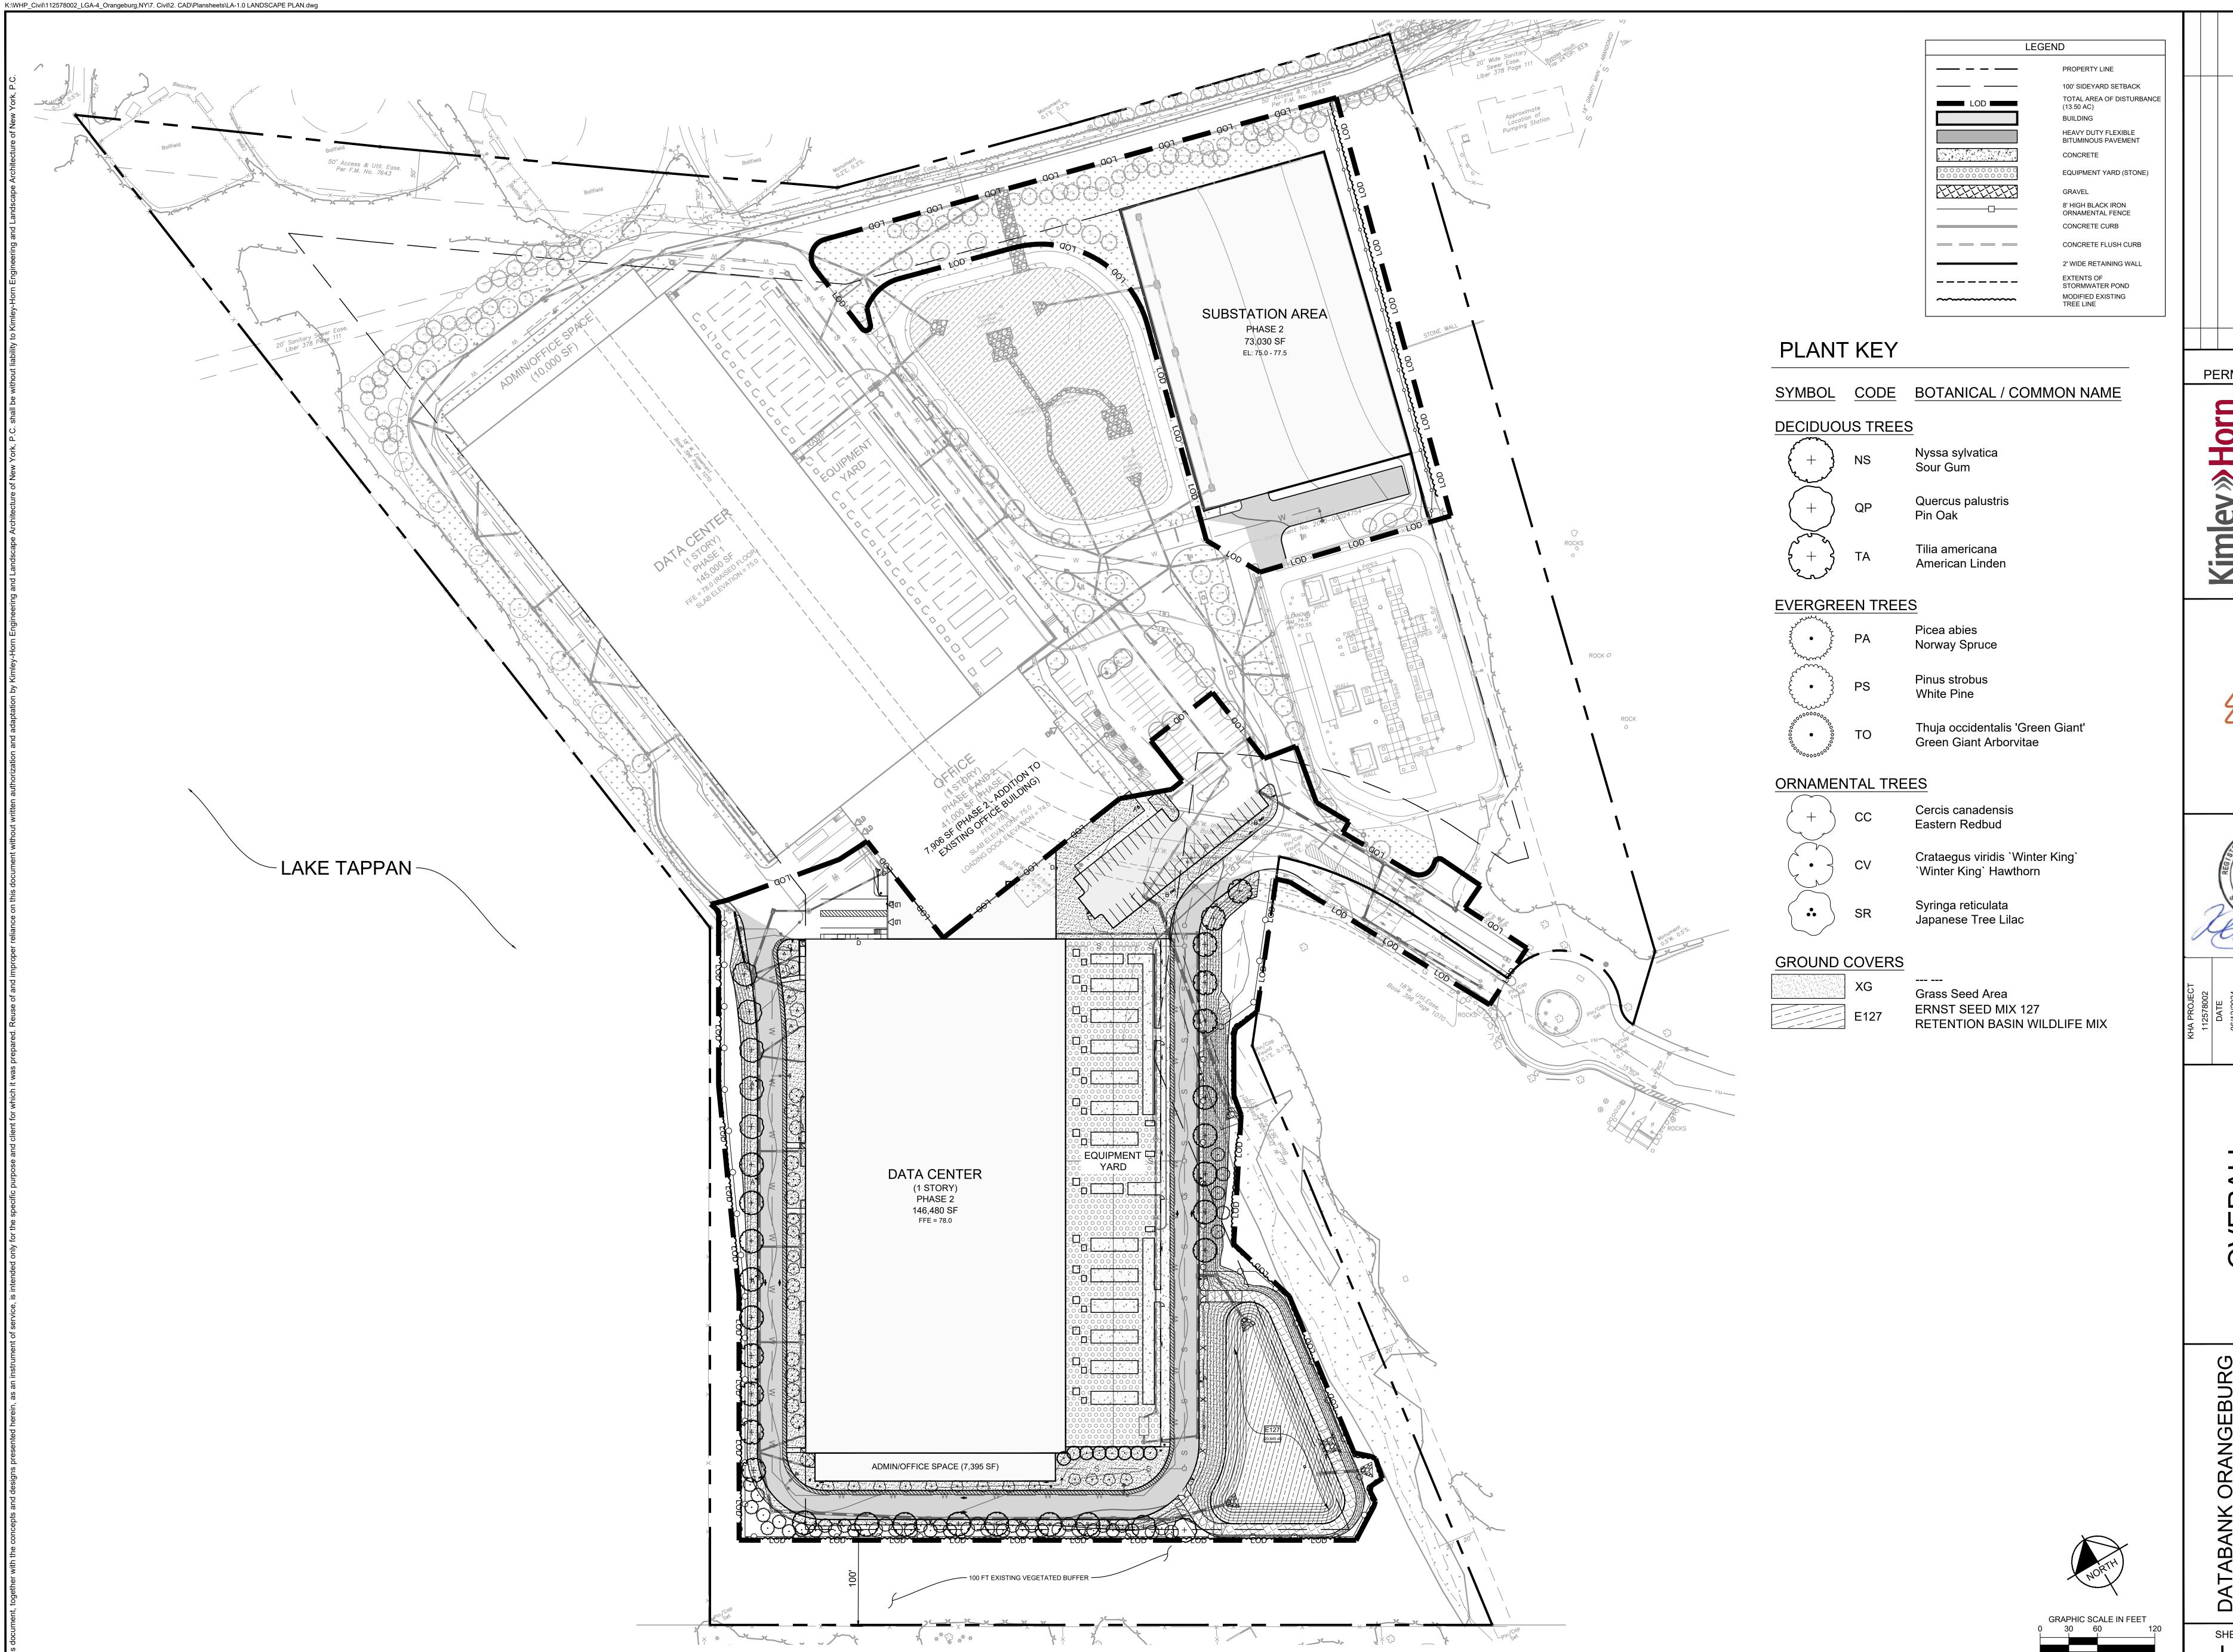PERMIT REVIEW

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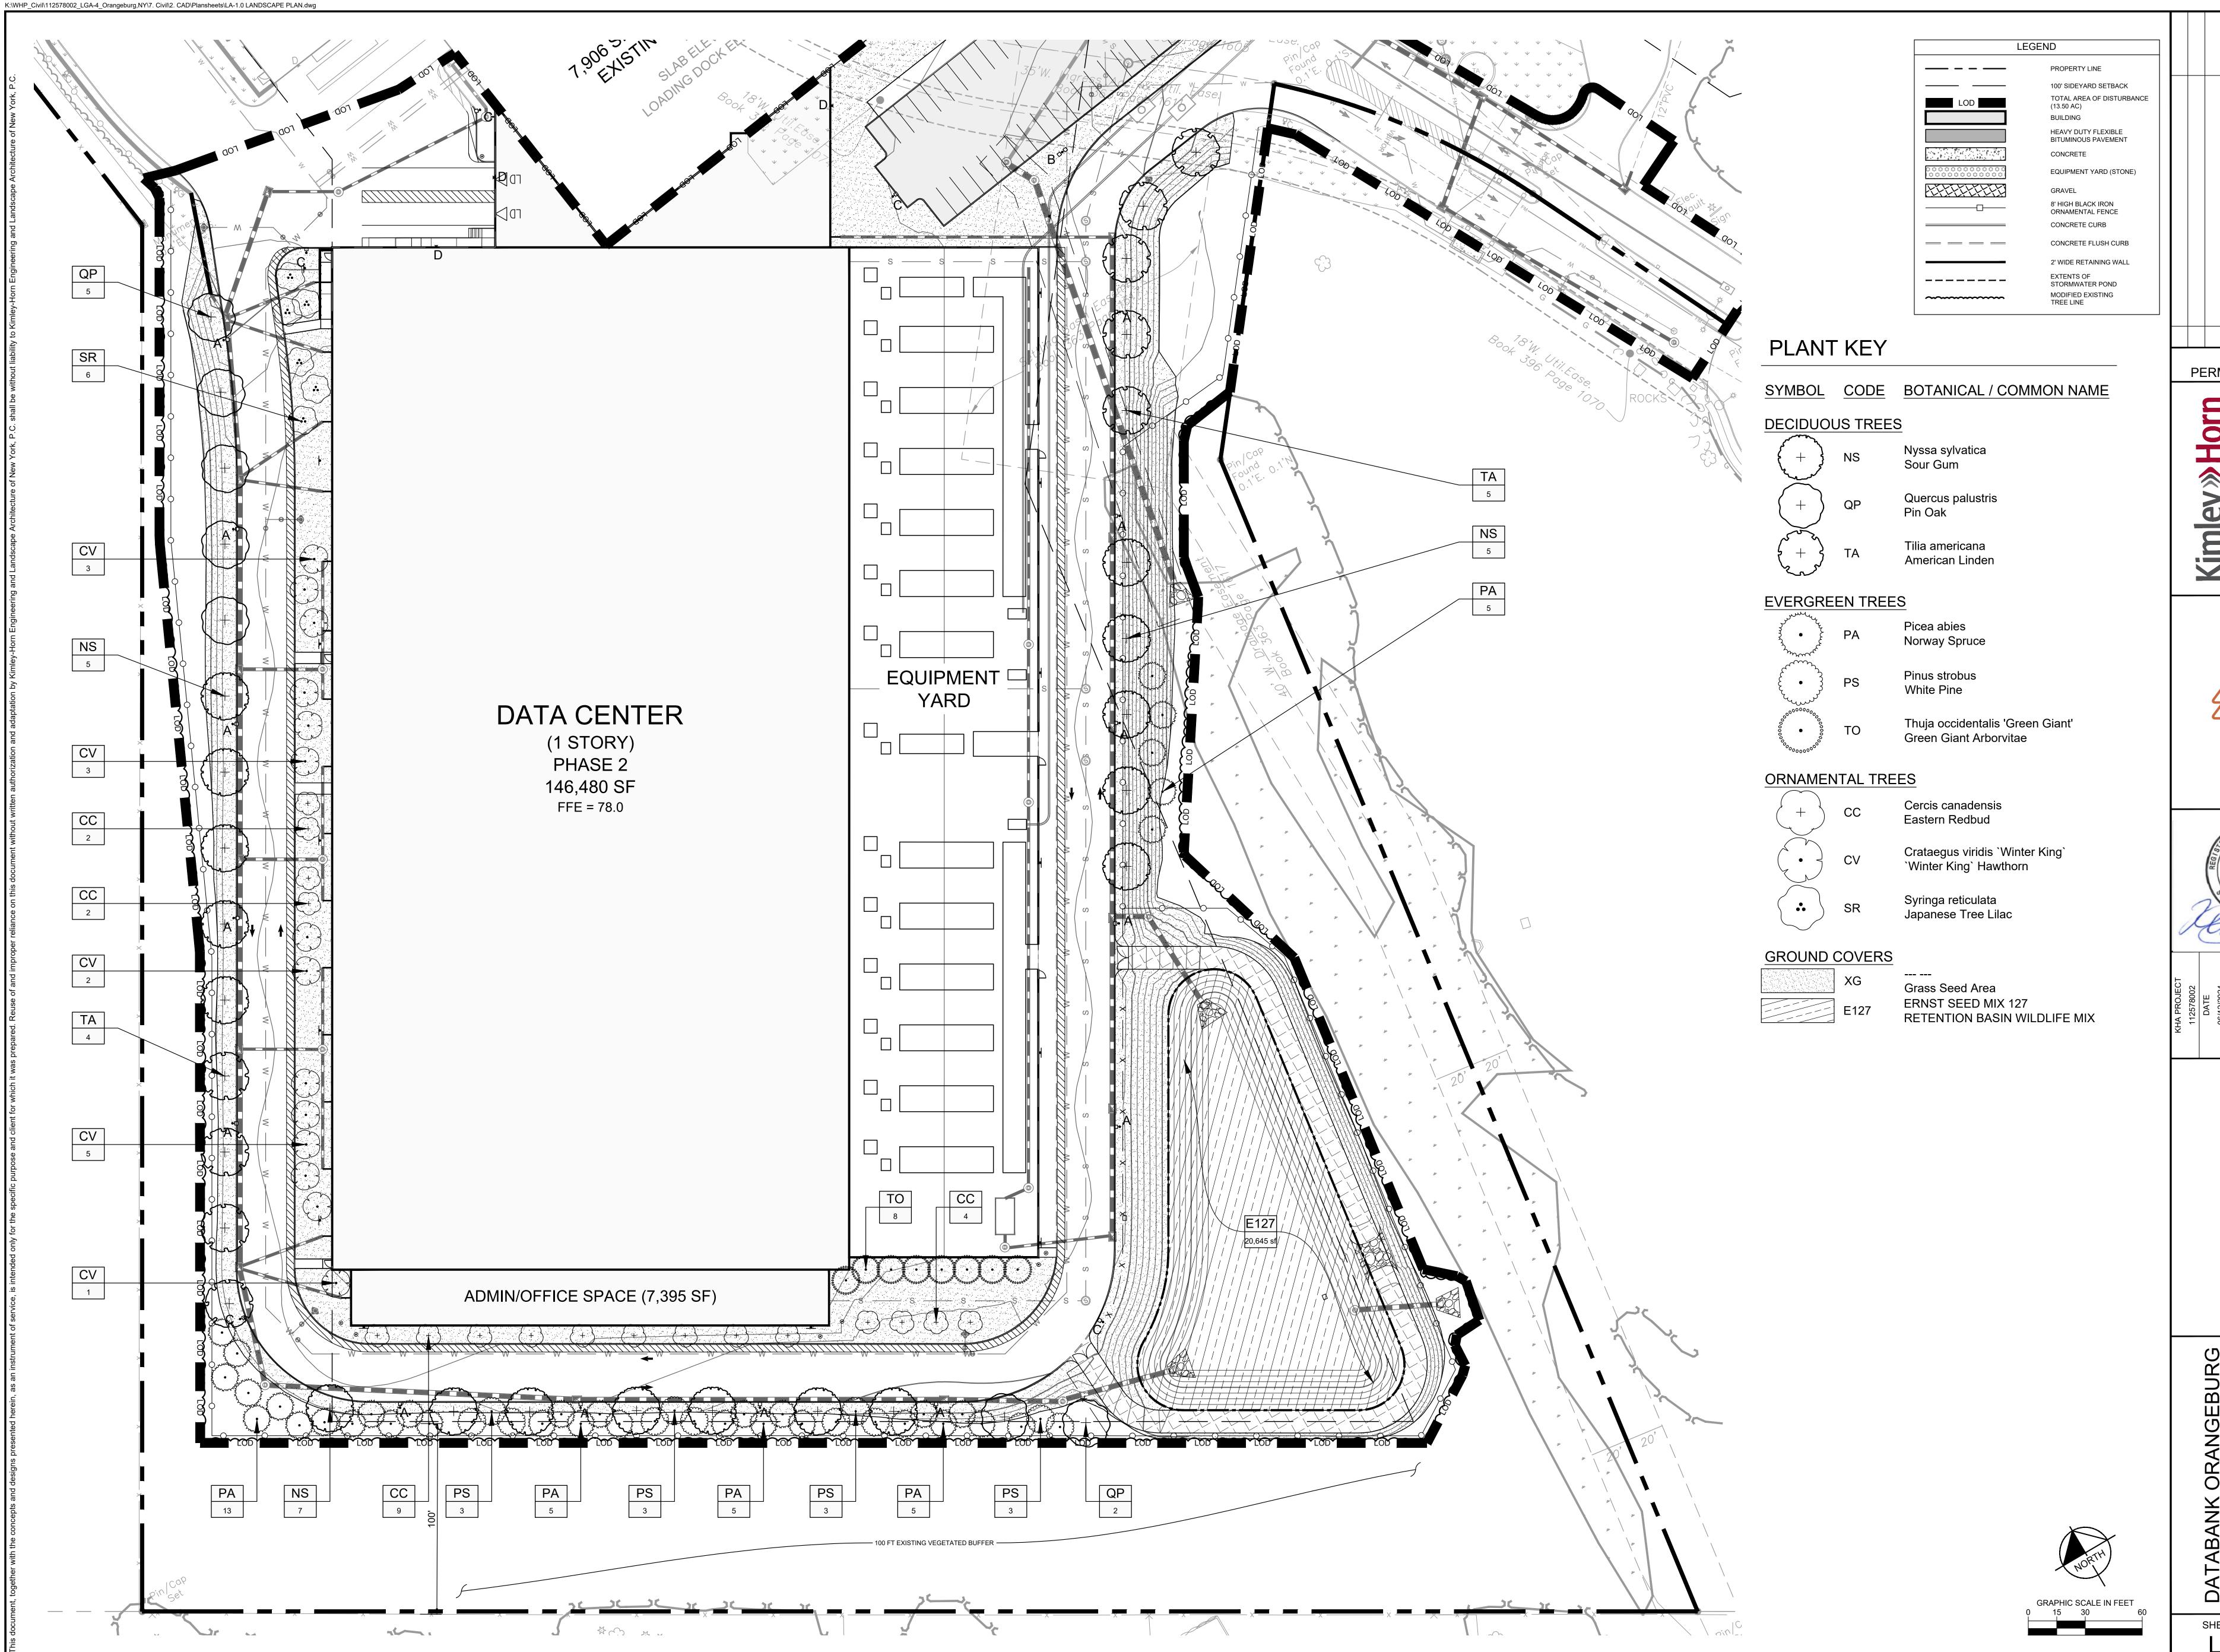
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SHEET NUMBER LA-1.1

#### **GENERAL NOTES**

- 1. Plants shall be healthy, vigorous material, free of pests and diseases and are subject to approval/rejection of the Landscape Architect prior to, during and after installation. 2. Contractor shall identify all materials at growing location prior to purchase and submit digital photographs, and source list to the Landscape Architect for approval at a minimum of six (6) calendar weeks prior to installation. Plants not approved shall be resourced and resubmitted.
- 3. Planting beds and individual tree plantings shall be mulched continuously as specified. 4. Prior to construction the contractor shall be responsible for locating underground utilities and execute work in a manner that avoids damage to utilities during the course of work.
- Contractor shall be responsible or remedy of any damage to utilities, structures, site appurtenances that occur as a result of landscape related work. 5. Contractor is responsible for verifying quantities shown on documents. Field adjustments shall be approved by Landscape Architect prior to installation. Quantities indicated on
- drawings are for reference-it is the Contractor's responsibility to ensure full coverage of plants at the indicated spacing. 6. Contractor is responsible for maintenance of all plantings including, but not limited to watering, mowing, edging, spraying, mulching, fertilizing, of plantings and turf areas for one (1) calendar year from date of certificate of occupancy. Contractor is responsible for warranty of all plant material for a period of one (1) calendar year from date of certificate of occupancy. Warranty replacement planting shall meet or exceed the original specification identified on drawings. Replacement planting shall extend the same warranty as
- originally installed materials. Plantings and grass areas shall be flourishing and fully thriving at end of warranty period. 7. Plants identified for replacement by Owner, Landscape Architect shall be replaced immediately by the Contractor unless otherwise agreed upon. Plantings (trees, shrubs, groundcover) subject to replacement by warranty shall exhibit characteristics of 30% dead-per individual plant, non-contributing or disease compromised. Grass areas suitable
- for acceptance shall demonstrate 85% sustained/consistent and continuous, densely established coverage. 8. Contractor shall perform a site review at end of warranty period and provide the Owner with written documentation of the site, including plant health, warranty replacement items,
- and conditions that may be influencing plant health. Contractor shall remove from plants and site, all staking and guying material at end of warranty period. 9. Contractor shall comply with all local, state and federal requirements, codes and regulations related to the work undertaken.
- 10. All material including planting operation appurtenances shall be of domestic origin manufacture and sourced within 100 miles of the project site. 11. Contractor is responsible for coordination among trades operating on site. Coordination and if necessary resulting modifications to schedules are responsibility of the Contractor.

### PERFORMANCE SPECIFICATION

### I. PLANTS

- A.General 1. Live healthy plants free of dead branches and parts
- 2. Free of disease, insect, injury and damage 3. Unbroken, intact, dense and solid rootballs and containers, without cracks, flat sides or previously repaired damage.
- 4. Free of girdling roots or rootbound/circling container conditions
- 5. Plants of consistent in growth habit and healthy character 6. Free of compromising growth conditions such as weak crotch connections, crossed branches, snags and scars
- 7. Point of origin growing location within 100 miles of project site 8. Graded, standards, caliper, sizes and stock consistent with ANSI Z60.1, American Standard for Nursery Stock most current edition

b. Branching Height-seven (7) feet to lowest branch in two years unless otherwise required by local jurisdiction

- 9. Species identified consistent with: <u>Hortus Third: Concise Dictionary of Plants Cultivated in the United States and Canada</u>, most current edition
- 10. Manual of Woody Plants: Their Identification, Ornamental Characteristics, Culture, Propagation and Uses, most current edition 11. All disturbed areas shall be grass seed unless otherwise identified on landscape plans

### B. Trees:

- 1. Deciduous Single Trunk a. Full, straight and upright with consistent symmetrical natural branching pattern throughout
- a. Full and upright with straight consistent symmetrical natural branching pattern throughout
- b. Canes evenly spaced and of similar growth habit c. Free of suckers and extraneous branching
- Evergreen Single-Trunk
- a. Full and upright with continuous symmetrical dense natural habit
- b. Clear branching height twelve (12) inches above top of rootball
- c. Free of suckers and extraneous branching d. Do not shear or otherwise prune to shape plantings
- C.Evergreen and Deciduous Shrubs
- 1. Full, dense and naturally symmetrical. 2. Consistent with container and/or balled and burlapped size
- 3. Free of suckers and extraneous branching
- 4. Do not shear or otherwise prune or shape plantings

#### D. Evergreen and Deciduous Groundcover 1. Full and dense in pots or flats

### E. Perennials and Seasonal Color

### 1. Full and dense in pots or flats

### F. Turf Grass

- a. Soil Mix-10% Compost, 90% topsoil by volume
- b. Preparation-loosen subgrade to a minimum depth of four (4) inches. Remove all non-natural materials including litter, stones, sticks and all items greater than ¾ inch in
- c. Preparation-spread soil mix at a depth of four (4) inches continuously to meet grade elevations shown on drawings. Allow for thickness of sod when applicable

### 2. Grass Sod

a. Install not longer than twenty-four (24) hours from harvest

ARBOR TIE

THREE (3) TWO INCH TREE -

LOCATION SHALL NOT

**BRANCHES** 

STAKES. INSTALL AT EDGE OF

SPREAD OF BRANCHES STAKE

INTERFERE WITH PERMANENT

- b. Grass bed not less than two (2) inches in continuous thickness c. 100% continuous live sod coverage after first growing season and at end of warranty period.
- d. Of uniform non-varying density and continuous texture quality capable of growth and development immediately upon installation. Weed and noxious plant free e. Stagger installation rows and place aligned parallel to contours
- f. Fill joints solidly with planting bed preparation soil g. Provide anchor pins at twenty-four (24) inches on center for slopes greater than 4:1

#### 3. Grass Seed a. Mix approved by the Landscape Architect

- b. Provide first and new of year seed crops in mix free of weed seeds and deleterious matter
- c. Provide seed mix not greater than 15% annual or perennial rye d. Coverage 85% continuous coverage live stand after first growing season and at end of warranty
- e. Replacement or overseeding mixes consistent with original application/installation f. Provide erosion blankets or other slope retention methods as noted on drawings

### II. Materials and Appurtenances

A.Testing 1. Materials testing information/certificates/dated labels shall be current to the project and performed/certified not greater than 120 calendar previous days from current date of submittal for review

## B. Top Soil

1. Neutral Ph balance 5.5 -7.5. Friable and containing 2.0-5.0% organic matter by dry weight. Continuously free of non-soil items such as stones, debris, sticks, trash, and deleterious matter greater than ¾ inch in any direction. Clay content shall not exceed 25%. Gravel content shall not exceed 10%. Silt shall not exceed 25%

1. Existing topsoil on-site may be repurposed with prior Owner approval. Contractor shall provide soil testing and additive program that demonstrates consistent performance and characteristics and composition as identified herein. Owner shall approve soil testing and soil amendment/additive methods and procedures

## 1. 100% organic shredded first year hardwood free of deleterious matter, rock, gravel and weed seed. Neutral Ph balance 5.5-7.5

## E. Compost Ph

1. Balanced 5.0-8.5 mature, stable and weed free produced by natural aerobic decomposition. Free of visible contaminants and toxic substances. Not greater than 5% sand, silt, clay or rock by dry weight. Consistent with US-EPA CFR Title 40 Part 503 Standards for Class A biosolids

- G.Compost Testing 1. Prior to delivery on-site, the following items are required for approval by Owner: Feedstock percentage in final compost product; statement that the products meets federal, state
- 2. Provide copy of lab analysis less than 120 calendar days old verifying that the product meets described physical requirements; chemical contaminants; Ph; physical contaminants; biological contaminants (including a statement that fecal coliform and salmonella testing and results comply with requirements of the US Composting Council Seal of Testing approval programs

#### **H.Planting Mix** 1. 85% topsoil and 15% Compost

1. Granular 10% nitrogen, 6% Phosphorous, 4% Potassium granular form with 50% Nitrogen in organic form. Product and Material Safety Data as approved by Owner

#### J. Herbicide 1. Product and Material Safety Data as approved by Owner

and local health safety requirements

### 1. Potable only unless otherwise approved by Owner

## L. Hardwood Stakes

1. Villa Non-Abrasive Rubber Tree Ties or approved equal

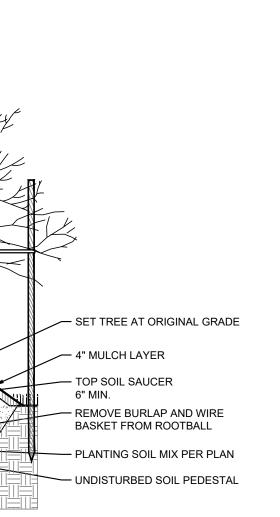
1. 2 x 2 x 48 inch square of sound hardwood, painted flat black on all sides

#### N. Filter Fabric 1. Mirafi 140-N or approved equal

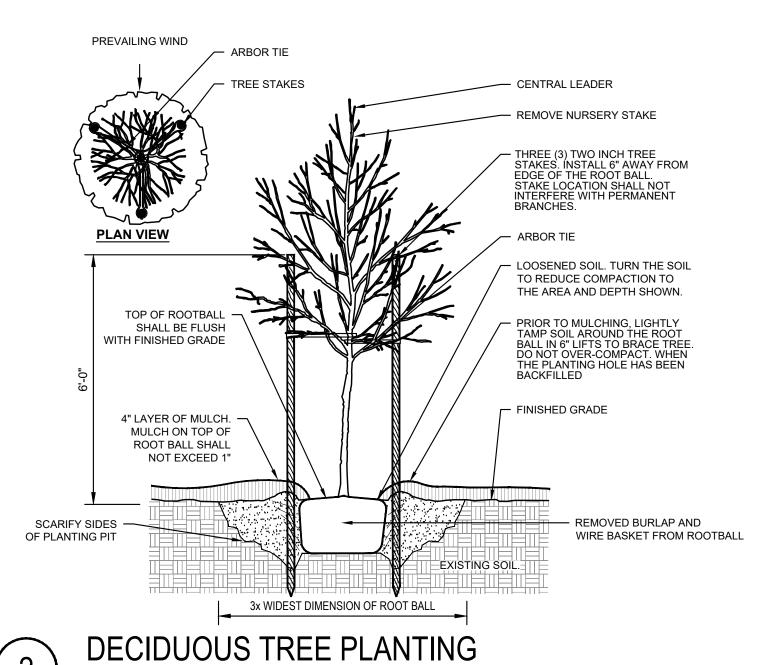
1. 1/8-inch x 4-inch in full sections. Ryerson, Timec or approved equal with integral stakes. No open corners. Corners shall be formed and trued to compliant angle or welded

#### P. River Stone

- 1. Locally sourced, river rounded, unfaceted river stone/cobbles.
- 2. Size shall not exceed 3 total inches in any dimension.
- 3. Color and texture approved by Owner 4. When placed in concrete or mortar setting bed, tamp to secure and brush clear joints.
- 5. Concrete or mortar as approved by owner.







**III.Execution A.Site Conditions** 

- 1. Inspect site and notify Owner in writing of acceptance with indication that project conditions are acceptable are suitable to proceed with work. Notify Owner of any existing
- damage and/or other conflicting conditions. Do not proceed with work until unsatisfactory conditions have been satisfactorily remedied. Notify Owner of acceptance prior to commencement of work.
- Notify Owner in writing of any conditions that may preclude successful completion of work including items such as coordination with other trades, incomplete work, drainage, soil temperature and/or composition, access to storage/work areas, damage to conditions, etc. Notify Owner in writing immediately of any items that may influence work schedule, timing of tasks, materials delivery and/or installation and warranty responsibilities.
- 5. Coordinate and cooperate with other trades working in and adjacent to work areas. Examine drawings of other trades which show development of the entire project and become
- familiar with the scope of required work by others. B. Planting Seasons

Recommended seasons are a general guide based on historical climatic data and typical performance of plantings, and which vary dependent on project-specific environmental conditions. Due to construction schedules, recommended planting seasons may/may not coincide with request(s) for certificate of occupancy for projects. Coordination of planting installation and seasons shall be reviewed with Owner on an individual project basis.

### 1. Deciduous and Evergreen Trees

- Do not install/plant the following trees between September 15 and March 15 a. Oaks (Quercus Sp., Such as Q. rubra, Q. alba, Q. phellos, Q. coccinnea)
- b. Dogwood (Cornus Sp.)
- c. Sweetgum (Liquidambar Sp.) d. All Conifers and Evergreens except White Pine (Pinus strobus Sp.)

### 2. Deciduous and Evergreen Shrubs

4. Spring Flowering Bulbs

a. Install/plant between March 15 and June 15 and/or September 15 and November 30

#### 3. Perennials a. Install/plant between March 15 and June 15 and/or September 15 and November 30

a. Install/plant between September 15 and December 15

a. Install/plant in season per approved schedule

### 6. Turf Grass

a. Install/plant between March 15 and May 15 and/or September 15 and November 30 b. Do not install/plant seed or sod turf grass areas when ambient air temperature is below forty (40) degrees Fahrenheit, or forecast for a twelve (12) hour period after completion of work

### 7. No Plant Installation

5. Seasonal Annuals

a. Do not install plantings or turf grass between June 15 and September 15, without approval by Owner

### C.Positioning & Location of Plantings

1. Position plants to show the most-prominent and well-formed face to most-public view 2. Field locate plants and location/spacing/dimension of planting beds on project site prior to beginning installation 3. Verify location of individual plants and plant beds prior to beginning installation. Do not proceed without Owner approval

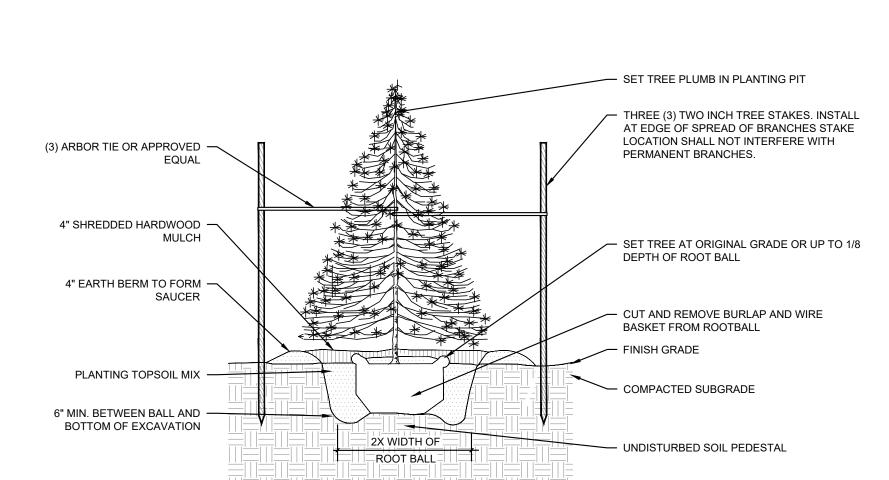
D.Implementation

### 1. Pursue work continuously without delay or interruption until completion unless notified otherwise by Owner

- 2. Provide project submittals ahead of commencement of work. Landscape Architect requires a minimum of ten (10) working days from date of receipt for review of submittals and response to Owner and Contractor. Plan accordingly for procurement of materials
- 3. Continuously update implementation schedule and notify Owner of progress. Delays related to material availability are not cause for non-completion of scheduled delivery of


### 4. Report delays due to weather or site conditions immediately upon finding. Provide recommendation for remedy of schedule delays. Do not work, place or modify frozen soil 5. Report delays due to extraordinary natural or other conditions beyond control of Contractor

- 1. Remove trash, debris and work materials from site prior to request for substantial completion. Thoroughly clean surfaces impacted by work including building, parking areas,
- roadways, sidewalks, signs, lights, site furnishings, etc.
- 2. Repair any damage to existing conditions that occurred during execution of work. 3. All clean-up and demobilization procedures shall be performed to satisfaction of the Owner and Landscape Architect.




**EVERGREEN TREE PLANTING** 
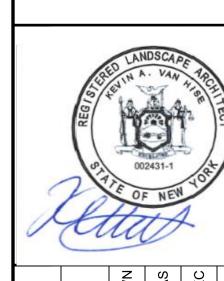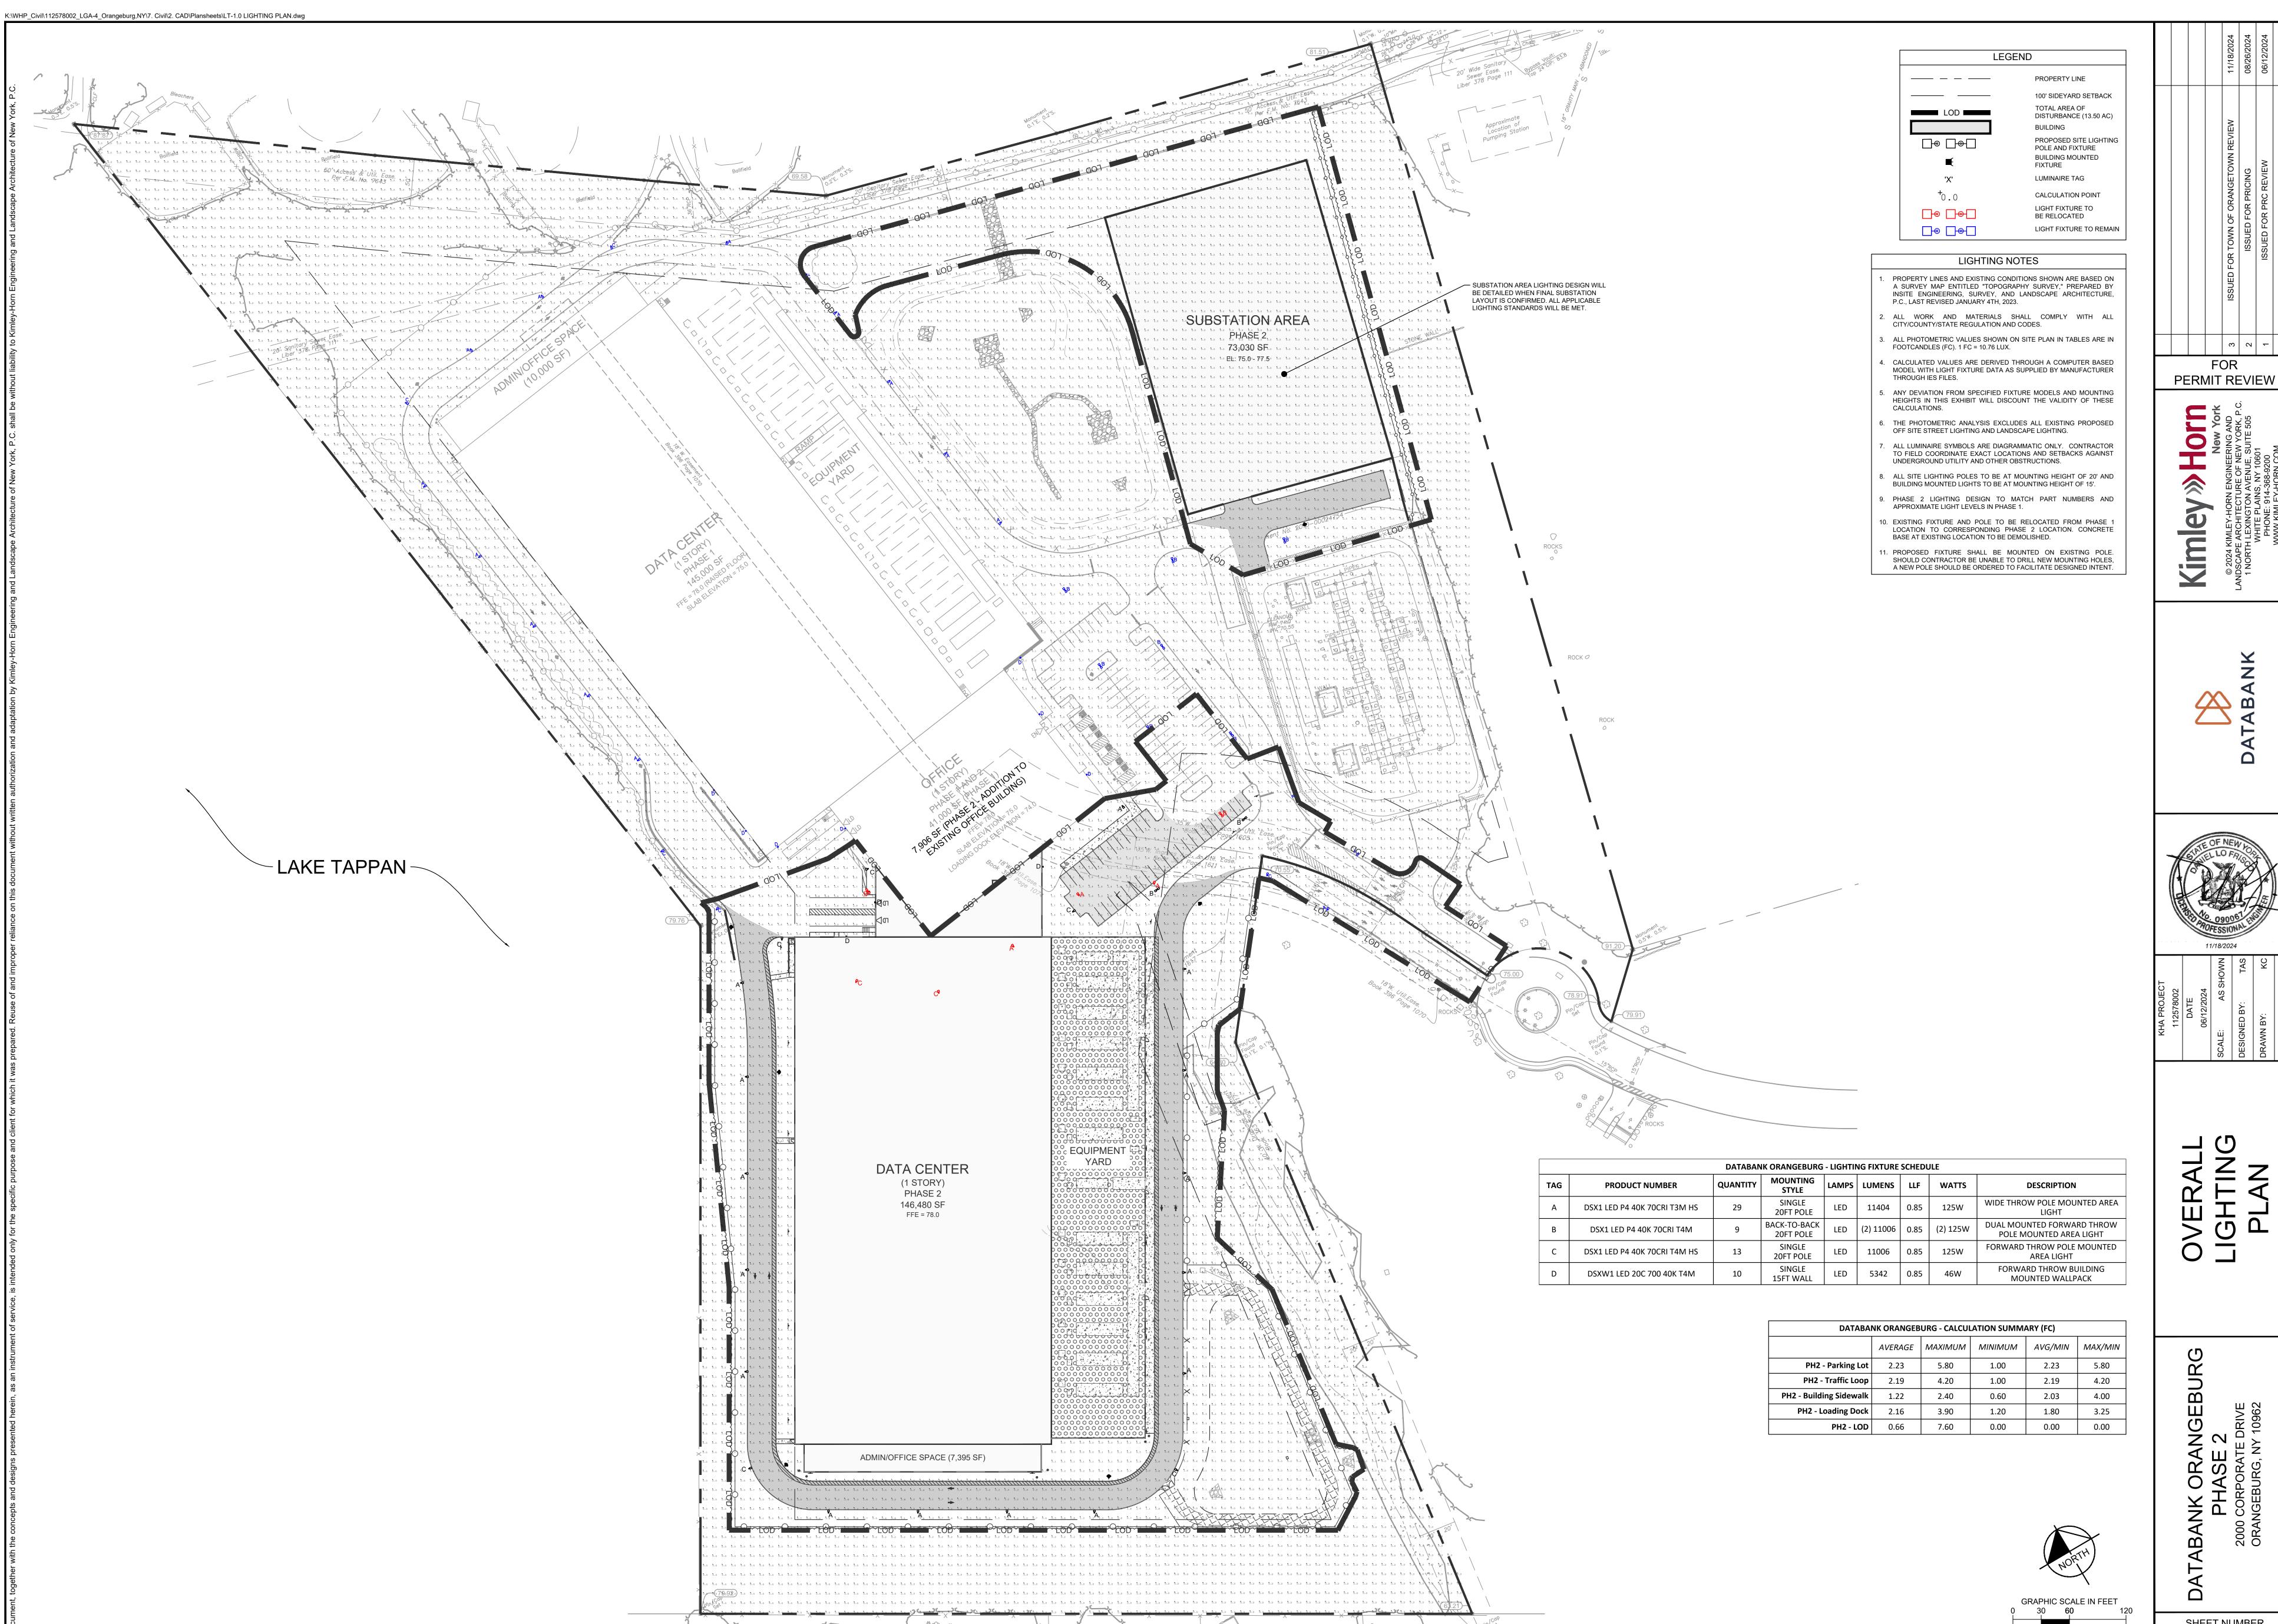
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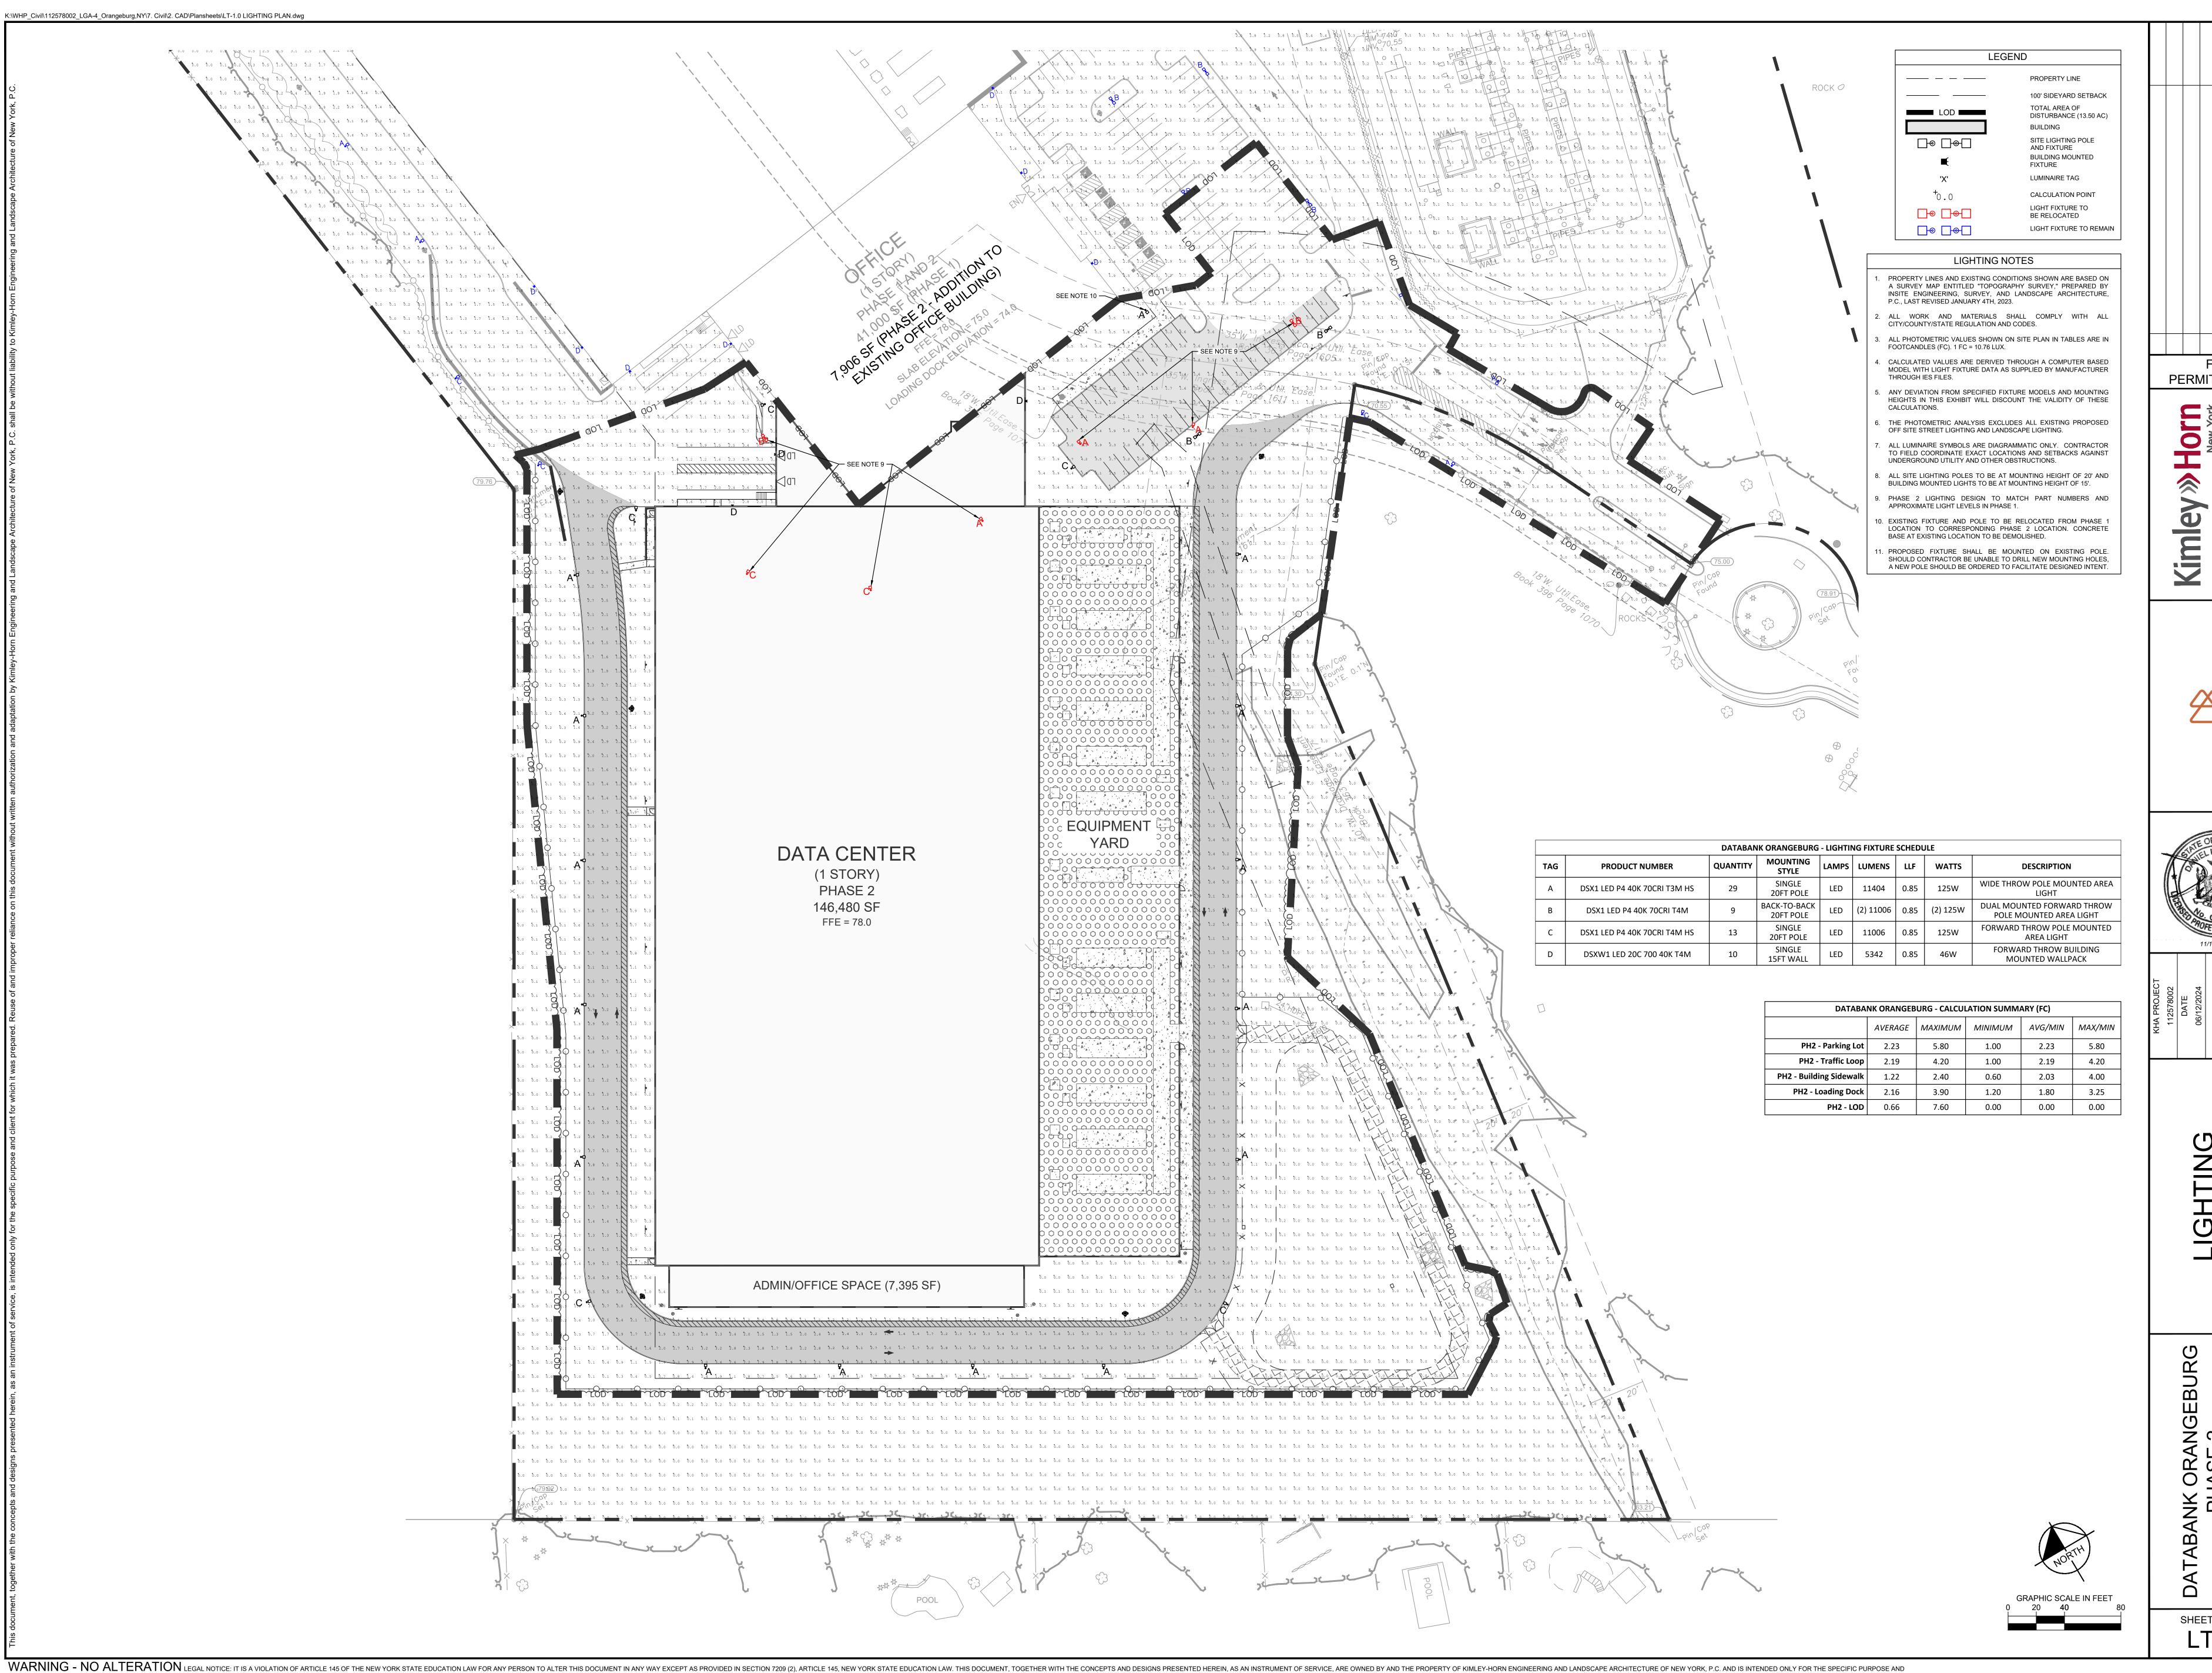
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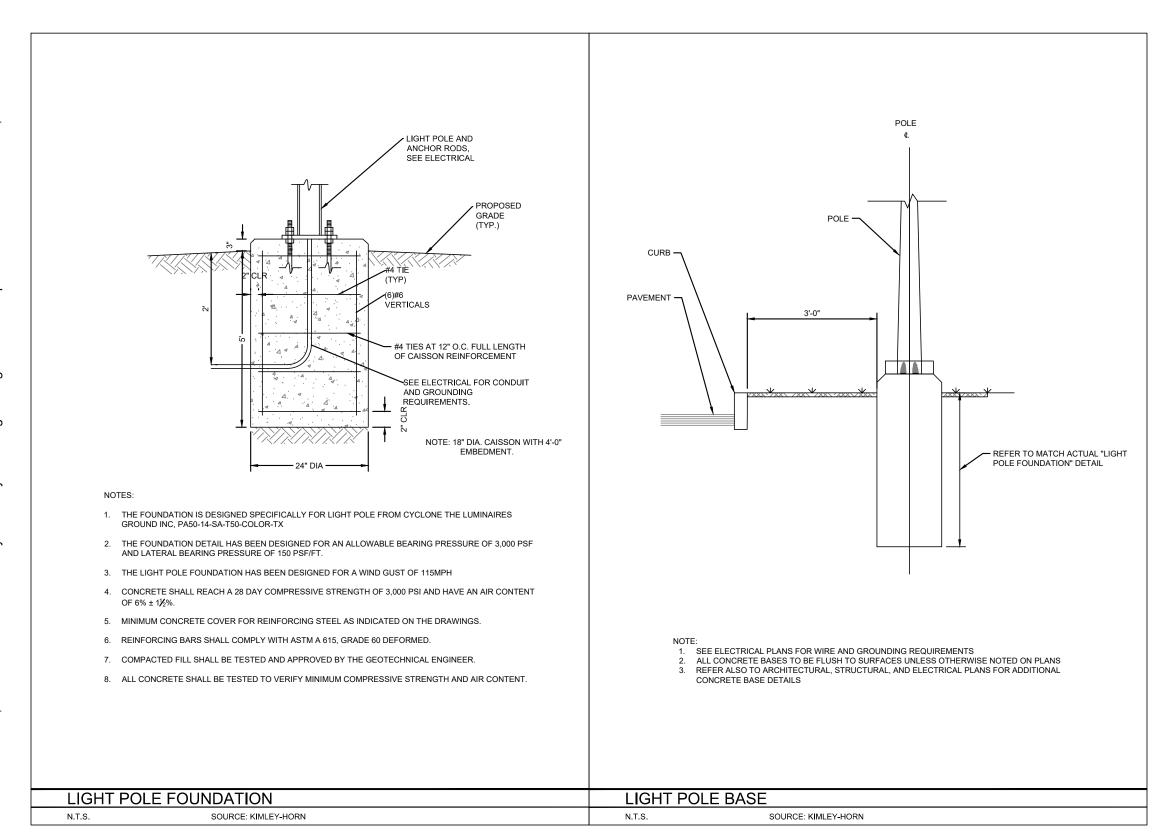
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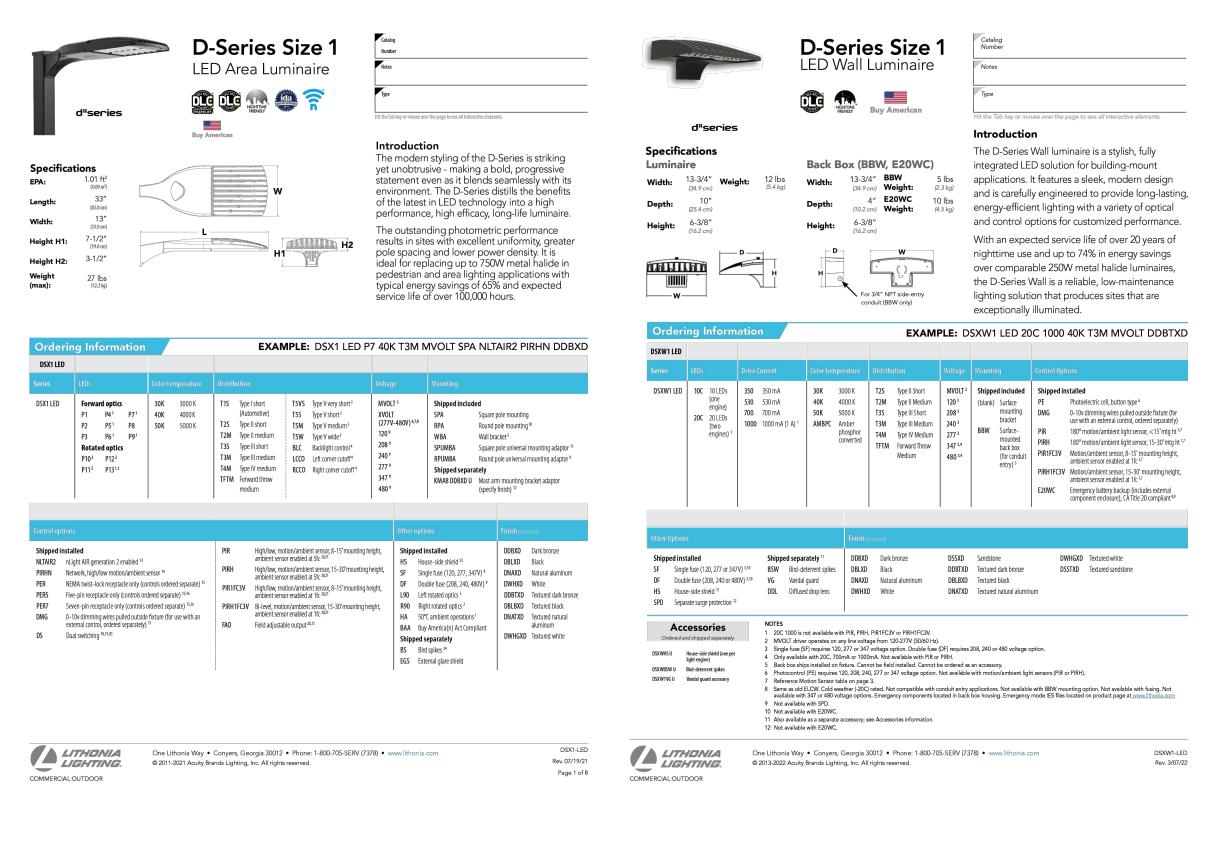
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