RECEIVED

LAW OFFICES OF

SNYDER & SNYDER, LLP

94 WHITE PLAINS ROAD TARRYTOWN, NEW YORK 10591 (914) 333-0700 FAX (914) 333-0743

WRITER'S E-MAIL ADDRESS

e-mail to Dkenny@Snyderlaw.net

January 31, 2025

JAN 3 1 2025

TOWN OF ORANGETOWN

BUILDING DEPARTMENT
NEW JERSEY OFFICE ONE GATEWAY CENTER, SUITE 2600 NEWARK, NEW JERSEY 07102 (973) 824-9772 FAX (973) 824-9774

REPLY TO:

Tarrytown Office

DAVID L. SNYDER (1956-2012)

NEW YORK OFFICE

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LESLIE J. SNYDER

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(212) 749-1448

445 PARK AVENUE, 9TH FLOOR

NEW YORK, NEW YORK 10022

ROBERT D. GAUDIOSO (NY/NJ)

MICHAEL SHERIDAN (NY/NJ) DAVID KENNY (NY/NJ)

> Chairman Thomas Warren and Members of the Planning Board Town of Orangetown 26 W. Orangeburg Road Orangeburg, NY 10962

> > Re:

Homeland Towers, LLC & Verizon Wireless

Wireless Communications Facility 61 Route 9W Palisades, NY 10964

Chairman Thomas Warren and Members of the Planning Board:

We represent Homeland Towers, LLC, ("Homeland Towers") and Verizon Wireless (collectively, "Applicants") in connection with a proposal to construct a replacement wireless communications facility, including a 120-foot monopole with a fenced equipment compound at the base thereof ("Facility"), at the above referenced property ("Property"). The Property is owned by Columbia University.

There is an existing 75-foot monopole ("Existing Facility") on the Property that supports emergency communication services equipment for Columbia University and Rockland County. Rockland County needs an increased centerline height for its emergency communications network and is proposed to be located at the top of the Facility as shown on the plans submitted herewith. The Facility is also needed to address significant gaps in service in Verizon Wireless's network in the areas surrounding the Property. Verizon will be located below Rockland County as shown on the plans submitted herewith. The Existing Facility will be removed once the Facility is constructed and fully operational.

We respectfully request to meet with the Planning Board, and its professional consultants and Town Staff (as determined necessary by the Planning Board), at a Pre-Application Consultation meeting to discuss the proposed Facility and the Town's application review process. Particularly, we would like to discuss conducting a balloon test during the leaf off season to prepare the photo simulations and visual analysis report as required by §8.15(M)(1) of the Town Zoning Code.

In furtherance of the foregoing, enclosed please find a check in the amount of \$200.00 representing the Consultation Fee together with 16 copies of the following materials:

- 1) Planning Board Application Form;
- 2) Letter from Columbia University;
- 3) Viewshed Maps; and
- 4) Zoning Drawings for the Facility.

If you have any questions or require additional documentation, please do not hesitate to contact me. Thank you in advance for your consideration.

Very truly yours,

David J. Kenny

Enclosures

cc: Zoning Director, Jane Slavin, R.A

Applicants

Z:\SSDATA\WPDATA\SS3\RDG\Homelandtowers\Orangetown\Ny452\Initial BP Filing 1.29.25 (NY452).rtf

Name of Municipality: <u>TOWN OF ORANGETOWN</u> Date of Municipality: <u>TOWN OF ORANGETOWN</u>

Date Submitted:	
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LAND USE BOARD APPLICATION

Please check all that apply:				
CommercialResidentialPlanning Board Historical BoardZoning Board of Appeals Architectural Board				
Subdivision Number of Lots Site Plan Conditional Use Special Permit Variance Performance Standards Review Use Variance Other (specify): Referred from Planning Board: YES / NO If yes provide date of Planning Board meeting:				
Project Name: Wireless Facility Replacement Project at Columbia University				
61 Route 9W, Palisades, NY 10964 Street Address:				
Tax Map Designation: 80.10 1 Lot(s): 1 Section: Block: Lot(s): Lot(s):				
Directional Location:				
On theEasternside ofRoute 9w, approximately, approximately, approximately				
Acreage of Parcel 126 +/- Zoning District R-80				
School District Postal District Ambulance District Fire District Water District Sewer District				
Project Description: (If additional space required, please attach a narrative summary.) Replace existing wireless telecommunications tower with new 120' monopole facilit	y			
to support equipment for Rockland County, Verizon and Columbia University with				
collocation space for potential future carriers				
The undersigned agrees to an extension of the statutory time limit for scheduling a public hearing. Date: Applicant's Signature:				

APPLICATION REVIEW FORM

Applicant	Homeland Towers, Ll :			s hone #(203) 29	7-6345	
	9 Harmony Street 2r	nd Floor Dan	bury CT 068				
Address:_	Street Name & Number	(Post Office)	City	Si	tate		Zip Code
	The Trustees of Col	umbia Unive	ersity in the (
Property (Owner:		P	hone #(845) 365	5-8843	
Address:	PO Box 1000 Palis	ades, NY 10	0964				
	Street Name & Number	(Post Office)	City	S	tate		Zip Code
Engineer/	Architect/Surveyor: _	On Air Eng	neering, LL0	C Pr	one #	(201) 456	6-4624
Address:	88 Foundry Pond I	Road, Cold		0516			
	Street Name & Number	(Post Office)	City	S	tate		Zip Code
Attorney:	Snyder & Snyder, L	LP	Phone #	(914) 3	33-0700	0	
Address:_	94 White Plains	•	,				
_	Street Name & Number	(Post Office)	City		State		Zip Code
Contact P	David Kenny of erson:	f Snyder & S	Snyder, LLP Phone #	į (91	4) 333-0		
Address: _	94 White Plains	Road, Tarr	ytown, NY 1	0591 DKE	enny@si	nyderlaw.	net
_	Street Name & Number	(Post Office)	City		State		Zip Code
	GENE	This propert	IICIPAL LA sy is within 500 ok all that app	0 feet of:	IEW:		
PLAN	EM IS CHECKED, A REVI NNING UNDER THE S TAT						
	State or County Road					k	
	ong Path ⁄Iunicipal Boundary			County Stre			
	s) of facility checked al	bove: ay and Park		•	•		
Referral Aç	gencies:						
RC	C Highway Department		RC Divi	sion of Envi	ronmental	l Resources	;
·	C Drainage Agency	_		ot. of Health	nmontal	Concentation	20
	S Dept. of Transportation 'S Thruway Authority	<u> </u>	V	ept. of Environes es Interstate			ווע
	jacent Municipality						

APPLICATION REVIEW FORM

FILL IN WHERE APPLICABLE. (IF THE FOLLOWING DOES NOT APPLY PLEASE MOVE ON TO THE NEXT PAGE)

If subdivis	sion:
1)	Is any variance from the subdivision regulations required?
2)	Is any open space being offered? If so, what amount?
3)	Is this a standard or average density subdivision?
If site plan	
1)	Existing square footage N/A N/A
	Total square footage
3)	Number of dwelling unitsnone proposed
If special p	Dermit , list special permit use and what the property will be used for. Vireless telecommunications facility - along with other educational uses in existence that are not impacted by this application
and net area	pes greater than 25%? If yes, please indicate the amount and show the gross
Are there stre	eams on the site? If yes, please provide the names. Not in project area
Are there wet	lands on the site? If yes, please provide the names and type: ot in project area
Project Hi	
Has this proje	ct ever been reviewed before?
If so, provide	a narrative, including the list case number, name, date, and the board(s) you appeared
before, and th	e status of any previous approvals.
List tax map s	section, block & lot numbers for all other abutting properties in the same ownership as
_	

APPLICATION REVIEW FORM

Applicant's Signature and Certification

State of New `	York Connecticut		
County of Roe	extland) SS.: Fairfi	eld	
	of Danbury)
			-
I, M	anu T. Vicenta	2	_ hereby depose and say that all the
above stateme	ents contained in the pa	pers submitted herewit	th are true
		Signature:	AM 11 >
	. Hall Nation OT		<i> </i>
	ca Hall Notary CT Blon Exp. 8-31-2028	Mailing Address:	9 Harmon st.
			Danton GOGRIO
			0
SWORN to be	efore this		
2-14	\	7-	
30 -	day of Uanu	ary , 20 25	
	A		
	Notary Public		-
	, totally , dibino		<u>.</u>
Owner/Api	plicant's Consent	Form to Visit Pro	operty
, , , , , , , , , , , , , , , , , , ,			- poy
L		0)	wner/applicant of the property described
in the applicat	ion submitted to the tow		ng board, zoning board of appeals and/or
			aid boards and/or supporting staff to visit
	question at a reasonab		
and property an	- quostion at a reasonal	no unio daring the day.	
			Owner/Applicant Signature
SWORN to be	fore this		ownew approach eighted
	day of	, 20	
	Noton Dublic		

COLUMBIA CLIMATE SCHOOL LAMONT-DOHERTY EARTH OBSERVATORY

November 11, 2024

Honorable Chairman Thomas Warren and Members of the Planning Board Town of Orangetown 20 Greenbush Road Orangeburg, NY 10962

Re: Application by Homeland Towers, LLC & Director Wireless ("Applicants") to locate a Wireless Telecommunications Facility ("Facility") at 61 Route 9W Palisades, NY 12524 (Columbia University – Lamont Doherty Earth Observatory Campus)

Dear Hon. Chairman Warren and Members of the Planning Board:

Columbia University, as the owner of the property, is in full support of the above referenced Applicants' proposal to construct a 120-foot-tall Facility at the Lamont Campus. The Facility is needed to replace an existing wireless telecommunications tower on the property and to support equipment for Verizon Wireless and potential future co-locators. Currently Rockland County and the University have equipment on the existing facility, and the University will relocate its equipment onto the new Facility once constructed. We also understand that the Applicants are working with the County to relocate its equipment onto the new Facility as well.

Once the new Facility is constructed, all equipment installed, and is fully operational, the existing wireless telecommunications tower will be removed.

Please let me know if you have any questions or concerns regarding this project.


Sincerely,


Dean Pearce, PE

Executive Director of Capital Planning & Facilities Strategy

Lamont-Doherty Earth Observatory

Dean Pearce

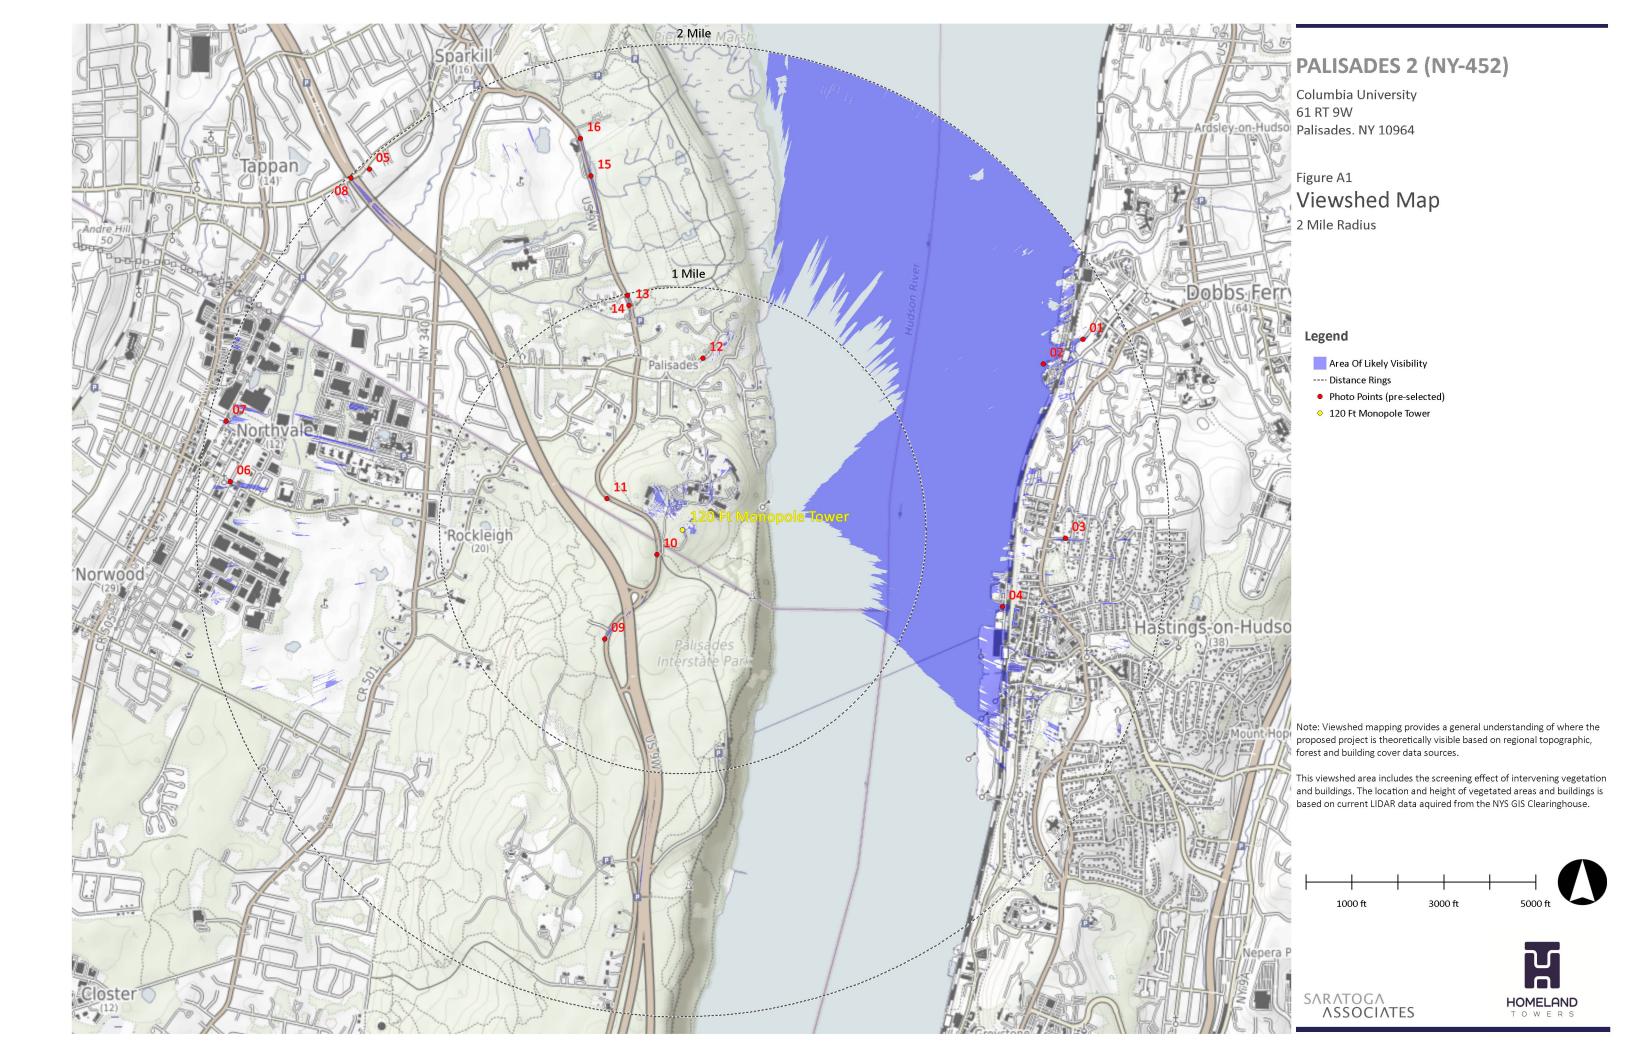

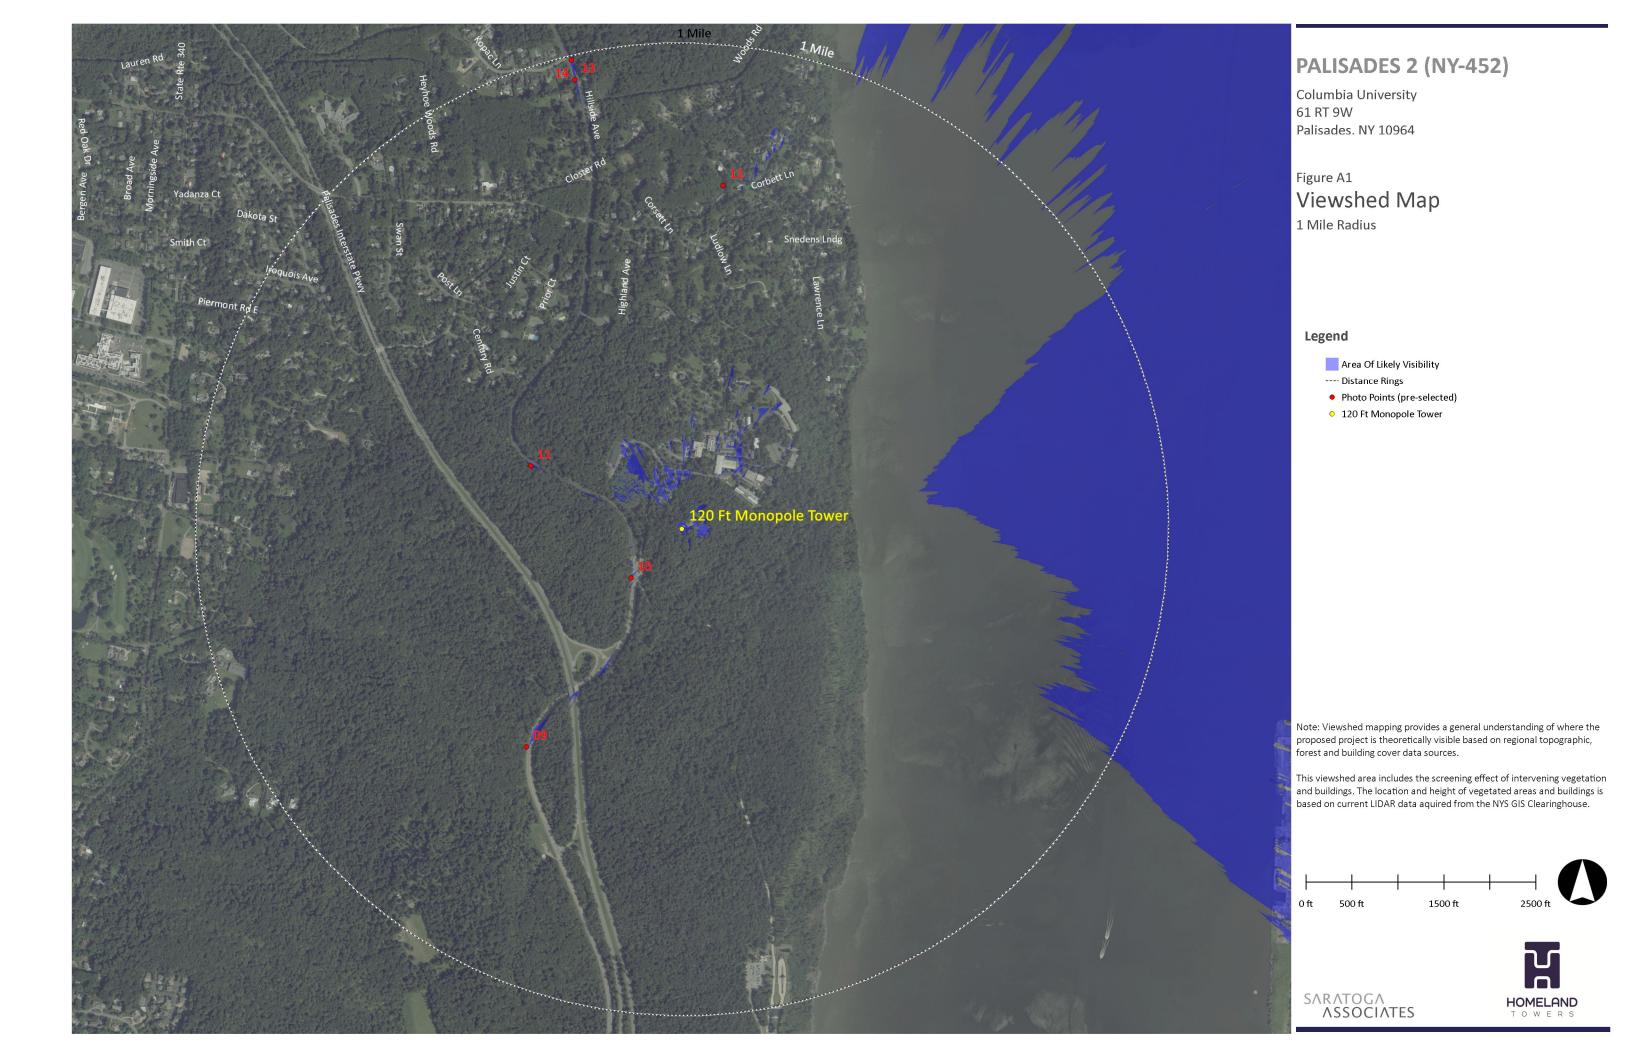




HOMELAND TOWERS SITE ID: NY452 - PALISADES 2

COLUMBIA UNIVERSITY 61 RT. 9W PALISADES, NY 10964 TOWN OF ORANGETOWN

PROJECT DESCRIPTION

- EXISTING 75 FT. MONOPOLE/TOWER TO BE REPLACED WITH A NEW 120 FT. MONOPOLE/TOWER (APPROX. 55 FT. AWAY)
- EXISTING FENCED TOWER COMPOUND TO BE EXPANDED TO A LARGER FENCED, GRAVEL SURFACE COMPOUND FOR CARRIER EQUIPMENT EXISTING SITE ACCESS AND PARKING TO BE USED
- INSTALLATION OF VERIZON OUTDOOR EQUIPMENT CABINETS AND A GAS FUELED STANDBY EMERGENCY GENERATOR ON A CONCRETE PAD WITH ANTENNAS/APPERTUNANCES AT 97 FT. ON THE STRUCTURE ELECTRICAL/TELEPHONE SERVICES TO BE EXTENDED FROM EXISTING UTILITY
- DEMARCATION POINTS ON-SITE TO EXPANDED COMPOUND AREA




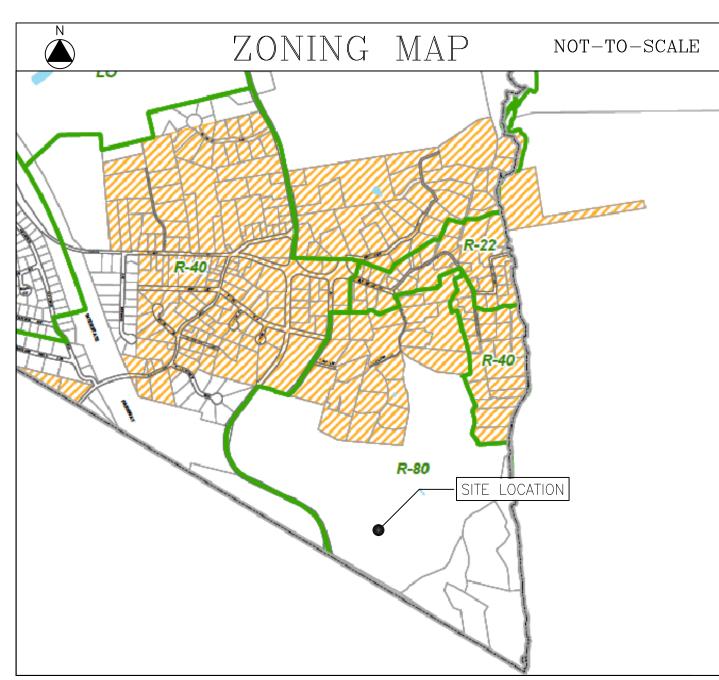



PR	OJECT SUMMARY	
SITE ID:	NY452 PALISADES 2	
SITE ADDRESS:	COLUMBIA UNIVERSITY 61 RT. 9W PALISADES, NY 10964	
PROPERTY OWNER:	COLUMBIA UNIVERSITY INC NY LAMONT GEOLOGICAL OBSERVATORY P.O. BOX 1000 PALISADES, NY 10964	
PARCEL ID:	80.10-1-2	
ZONING:	R-80	
TOWER COORDINATES:	41.00203159 -73.90974041	
GROUND ELEVATION:	429.6 FT. AMSL	
APPLICANT:	HOMELAND TOWERS 9 HARMONY ST.; 2ND FL. DANBURY, CT 06810	

DRAWING SCHEDULE				
SHEET NO.	SHEET DESCRIPTION			
T-1	TITLE SHEET			
R-1	500 FT. RADIUS MAP			
C-1	SITE LAYOUT			
C-2	ENLARGED SITE PLAN			
C-3	CIVIL NOTES & DETAILS			
C-4	FENCE & MISC. DETAILS			
A-1	COMPOUND PLAN & ELEVATION			
VZ-1	VERIZON EQUIPMENT PLAN & DETAILS			
VZ-2	ANTENNA PLAN & VERIZON EQUIP. SPECS			

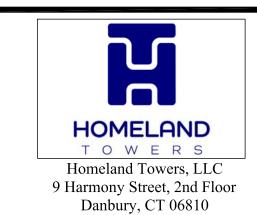




d/b/a VERIZON WIRELESS 4 CENTEROCK ROAD WEST NYACK, NY 10994



88 Foundry Pond Road Cold Spring, NY 10516 onair@optonline.net 201-456-4624

LICENSURE

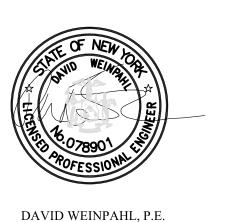

NY LIC NO. 078901 SUBMISSIONS 0 | 12.19.24 | REVIEW SET 1 | 12.30.34 | REVISED PER ATTORNEY COMMENTS

HOMELAND TOWERS SITE ID:

NY452 PALISADES 2

DW

VERIZON SITE NAME:


PALISADES 2

PROJECT ADDRESS: COLUMBIA UNIVERSITY 61 RT. 9W PALISADES, NY 10964

DRAWING TITLE:


TITLE SHEET

SHEET NUMBER:

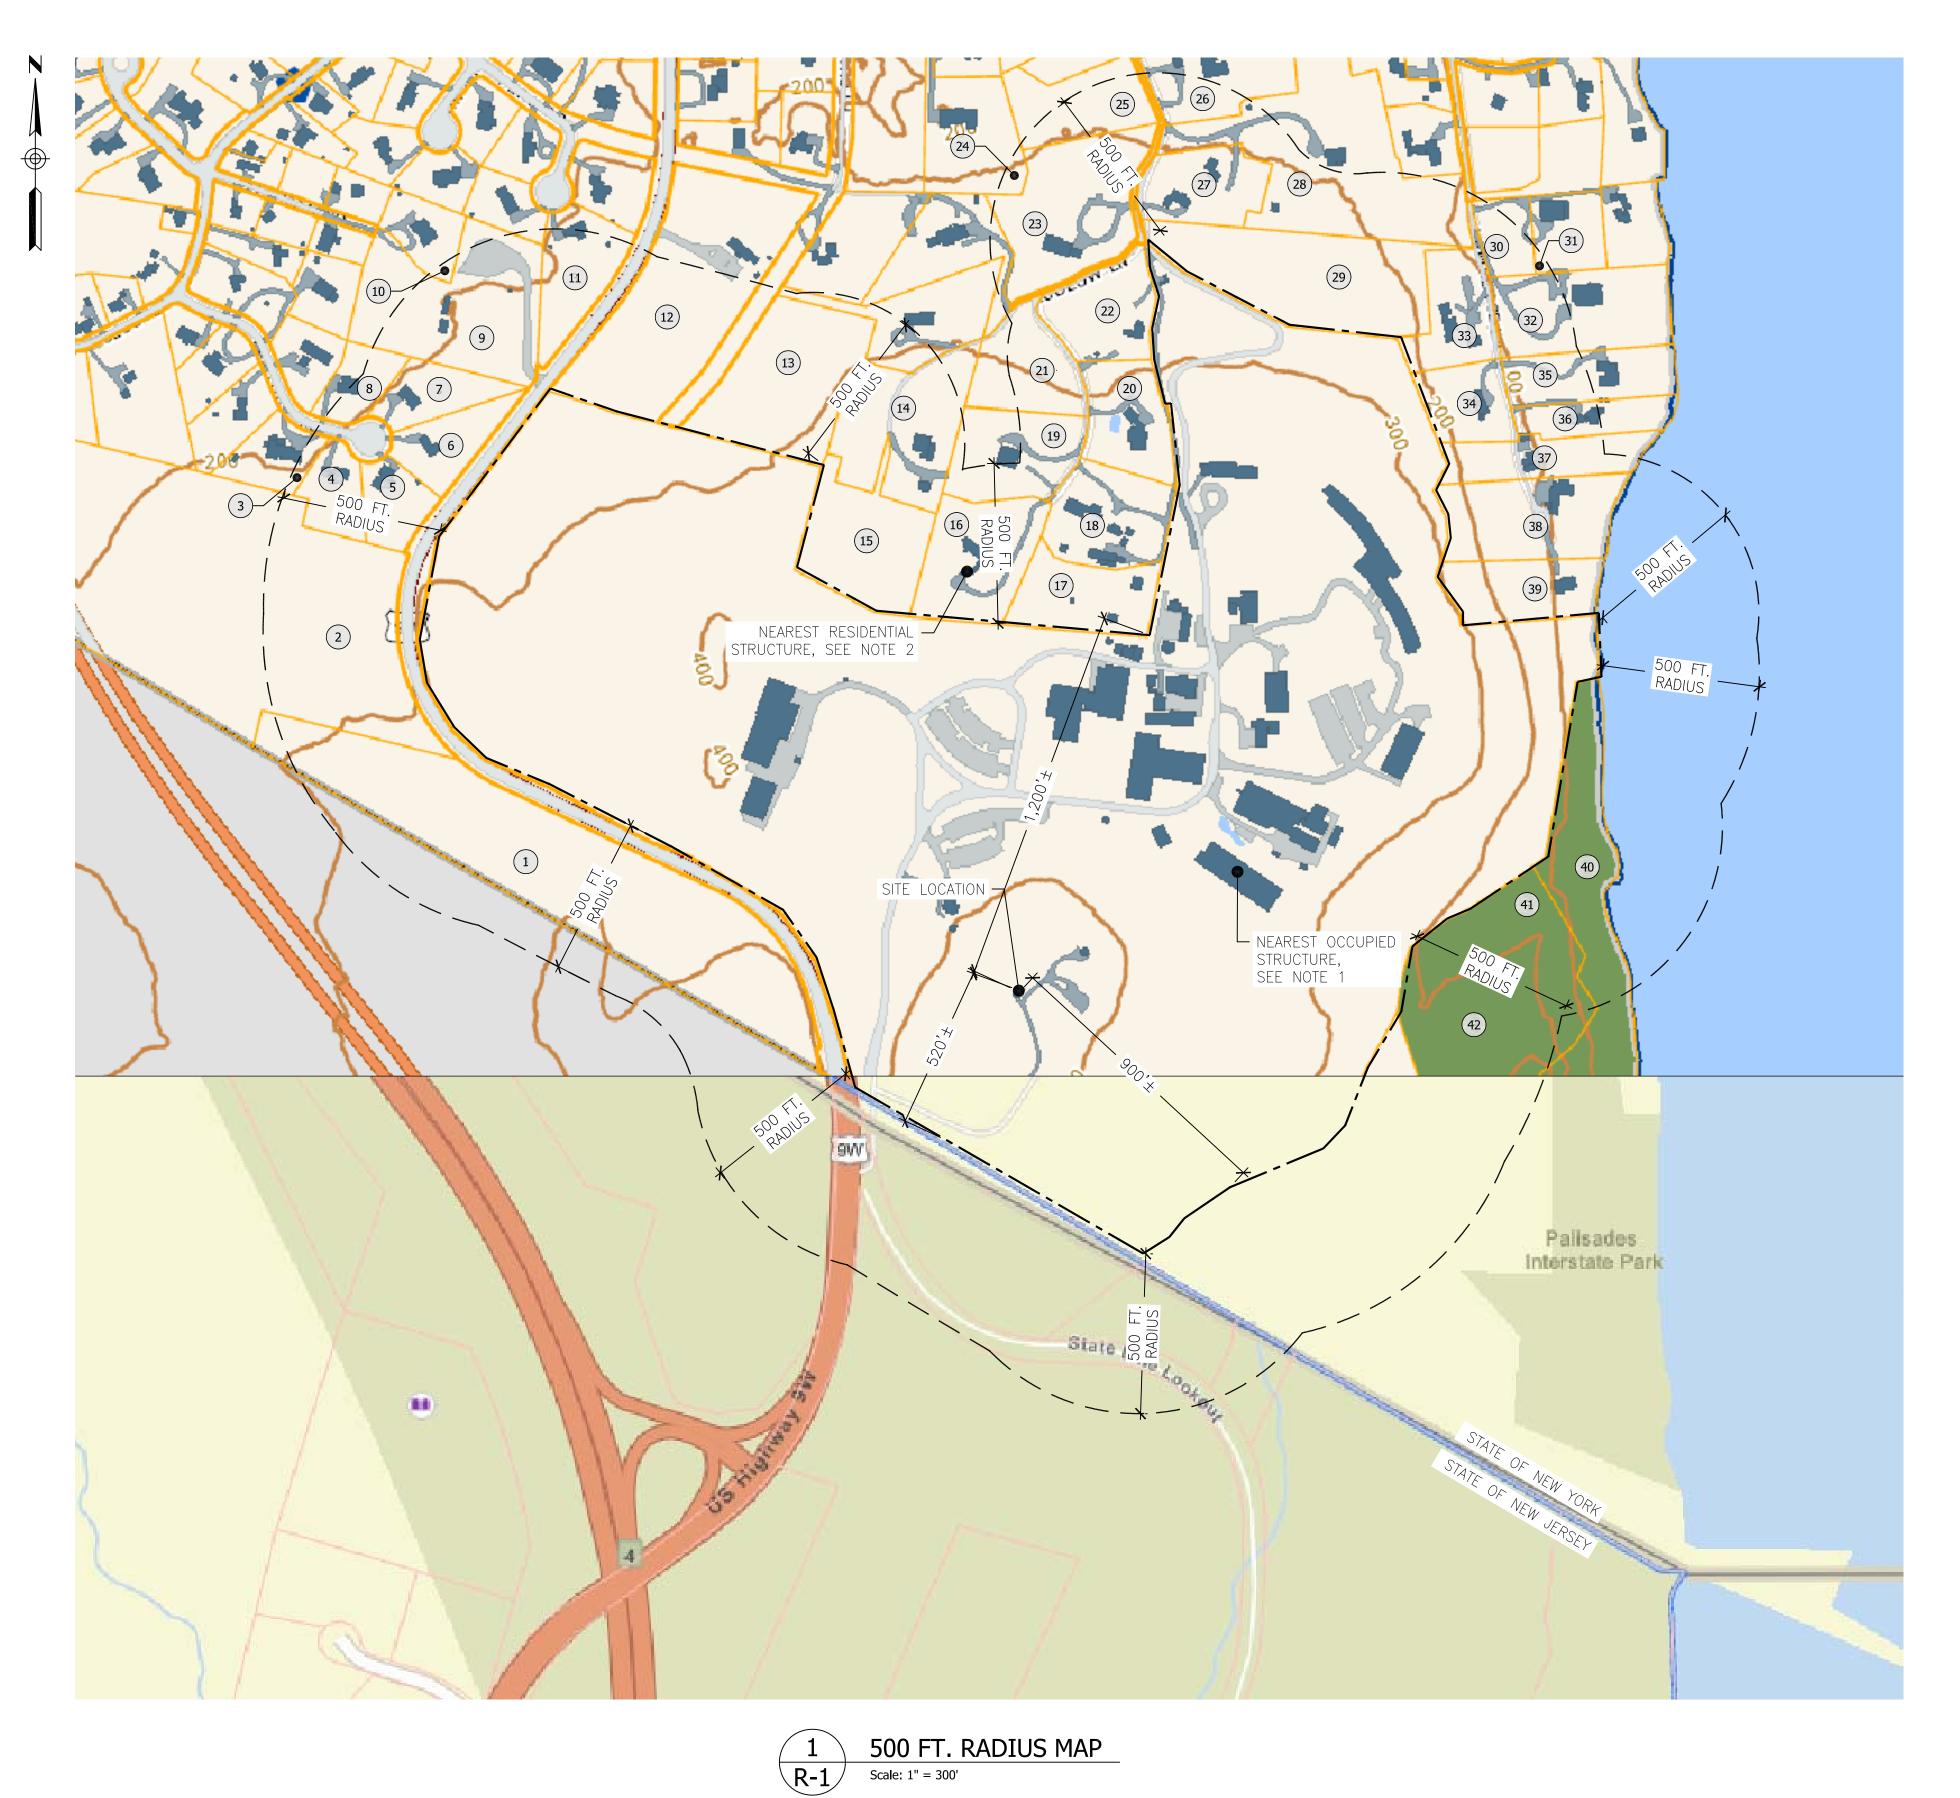

NOTES:
1. NEAREST OCCUPIED STRUCTURE TO PROPOSED TOWER 715 FT.± (GARY C. COMER GEOCHEMISTRY BUILDING; LUDLOW LANE)

2. NEAREST RESIDENTIAL STRUCTURE TO PROPOSED TOWER 1,315 FT.± (80 LUDLOW LANE)

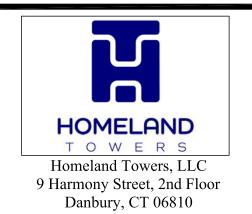



NEW YORK SMSA LIMITED PARTNERSHIP d/b/a VERIZON WIRELESS 4 CENTEROCK ROAD WEST NYACK, NY 10994



LICENSURE



DAVID WEINPAHL, P.E. NY LIC NO. 078901

NY LIC NO. 0/8901		
NO.: DATE:		SUBMISSIONS
0	12.19.24	REVIEW SET
1	12.30.34	REVISED PER ATTORNEY COMMENTS

DWMF

HOMELAND TOWERS SITE ID:

NY452 PALISADES 2

VERIZON SITE NAME:

PALISADES 2

PROJECT ADDRESS: COLUMBIA UNIVERSITY 61 RT. 9W


DRAWING TITLE:

500 FT. RADIUS MAP

PALISADES, NY 10964

SHEET NUMBER:

R-1

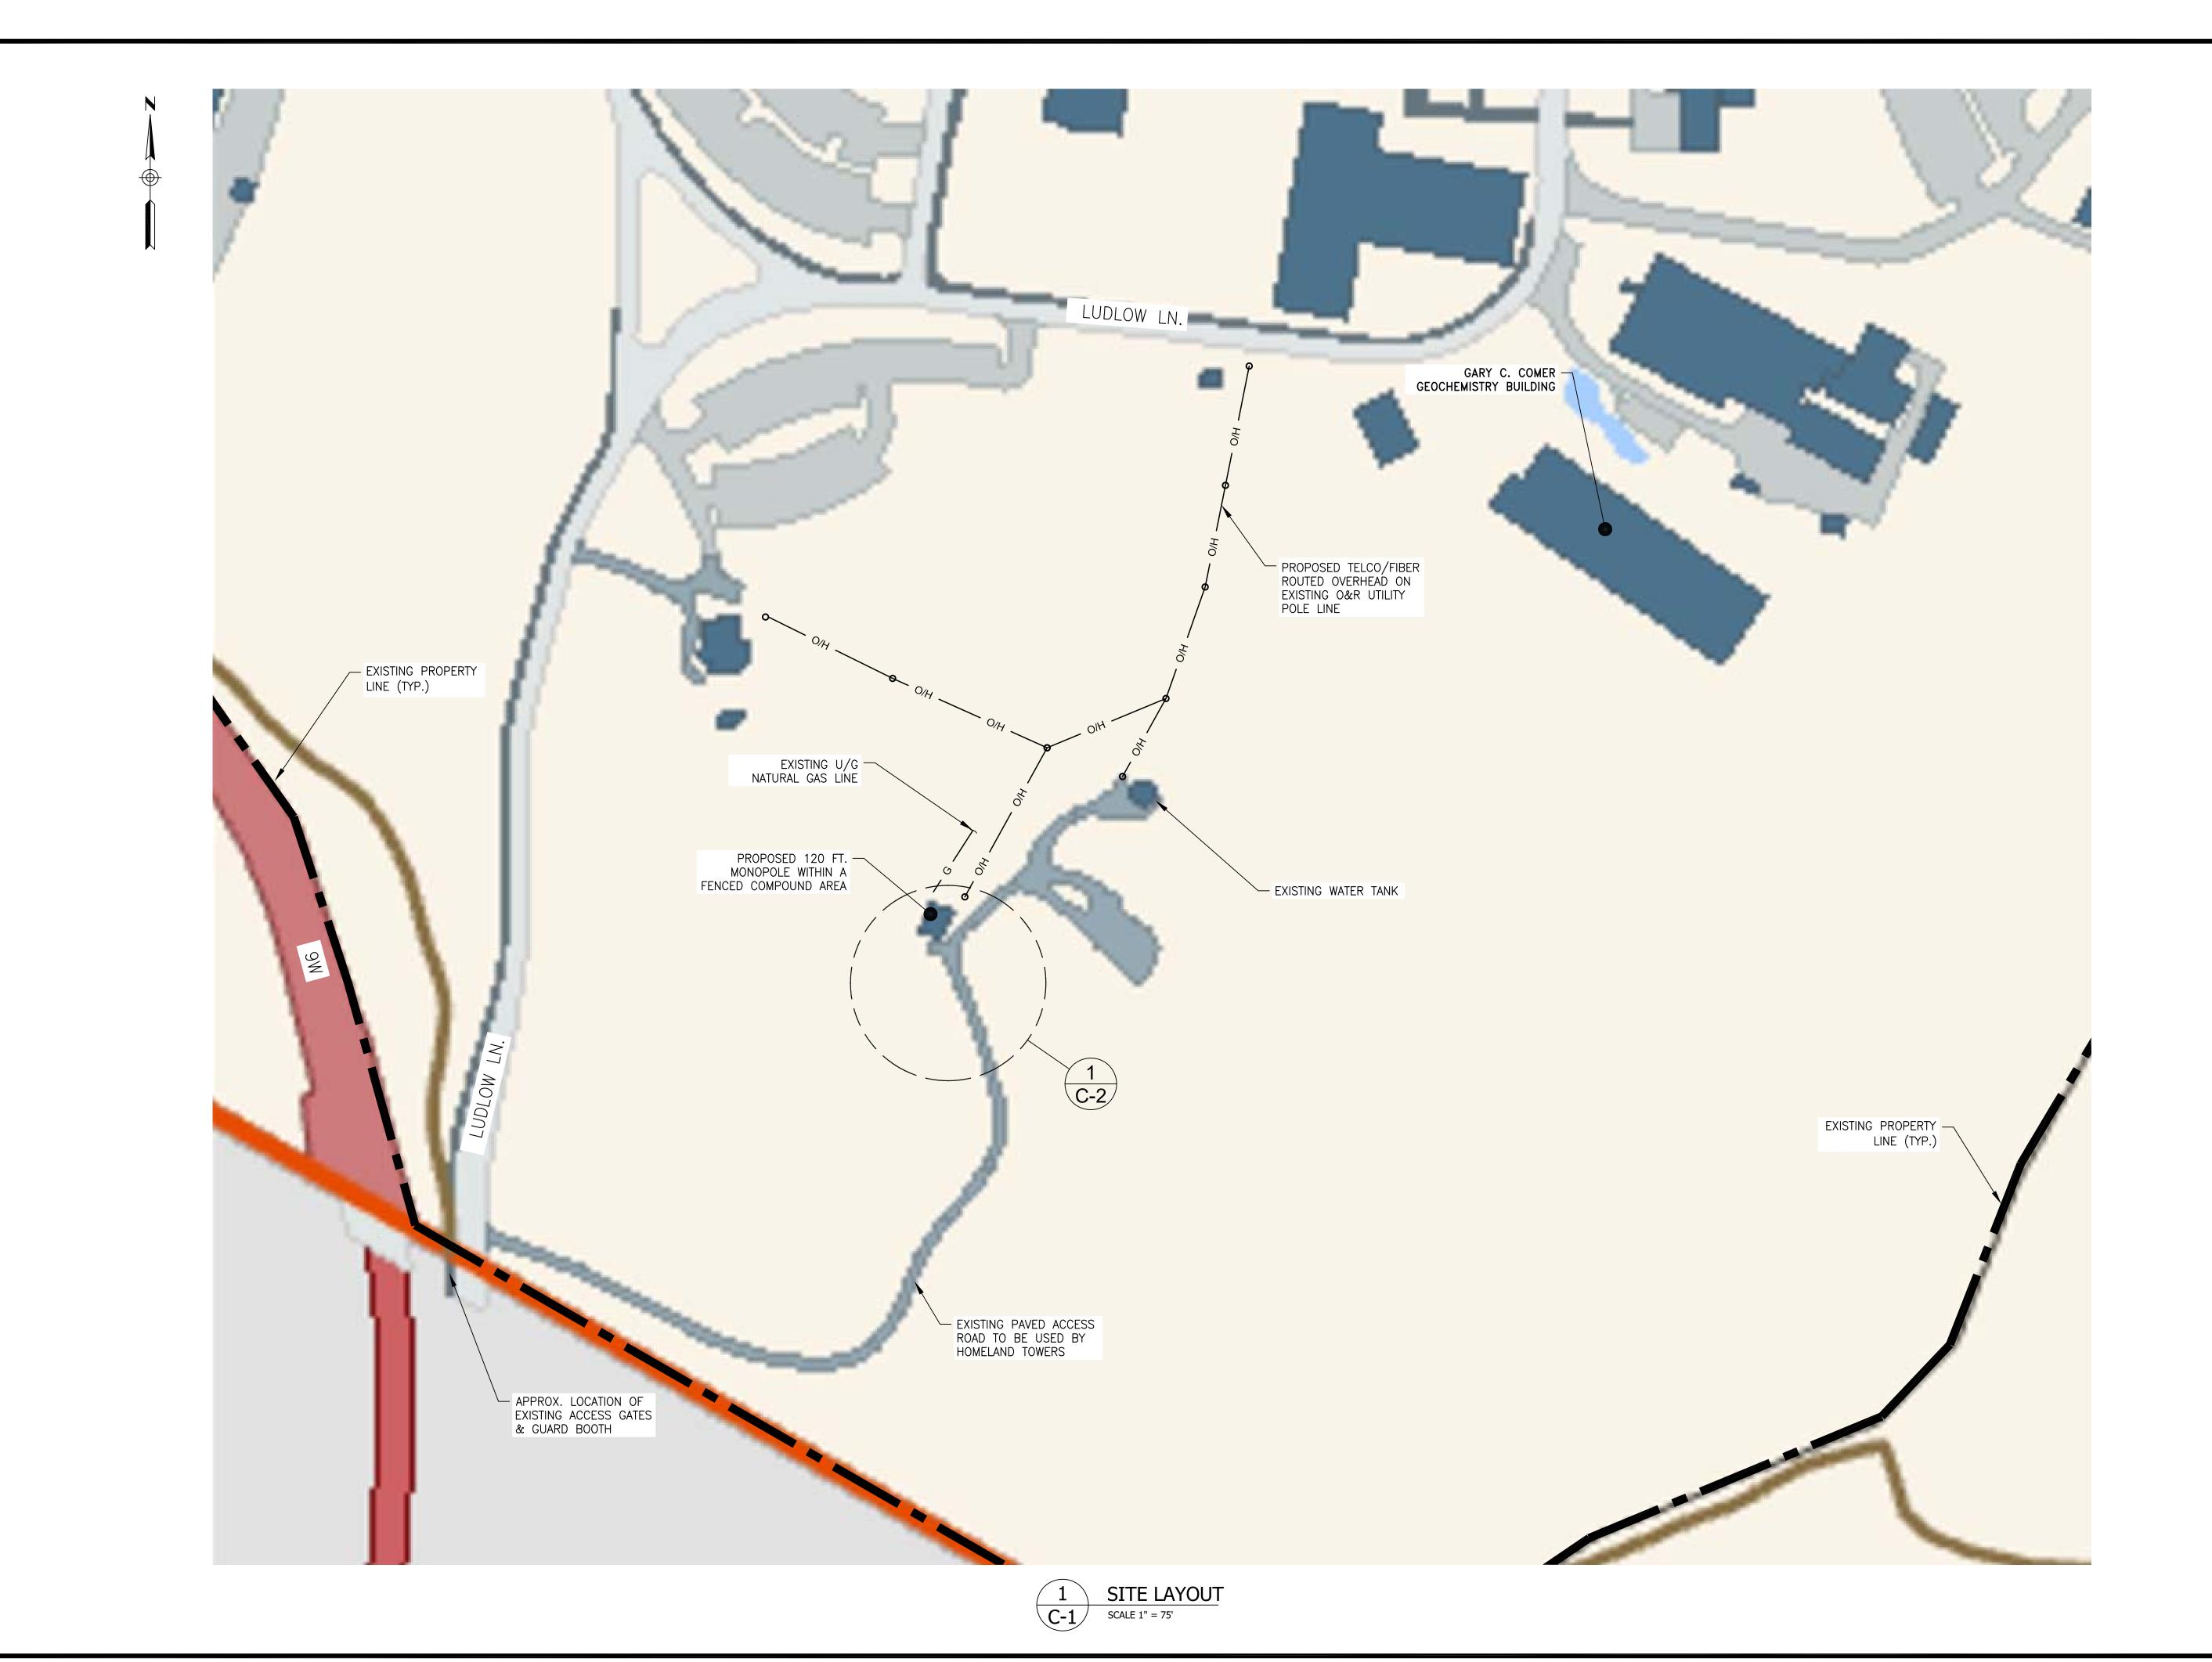




Homeland Towers, LLC 9 Harmony Street, 2nd Floor Danbury, CT 06810



NEW YORK SMSA LIMITED PARTNERSHIP d/b/a VERIZON WIRELESS 4 CENTEROCK ROAD WEST NYACK, NY 10994

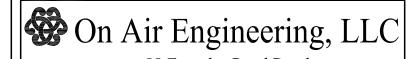

88 Foundry Pond Road Cold Spring, NY 10516 onair@optonline.net 201-456-4624

LICENSURE



DAVID WEINPAHL, P.E. NY LIC NO. 078901

NO.:	DATE:	SUBMISSIONS
0	12.19.24	REVIEW SET
1	12.30.34	REVISED PER ATTORNEY COMMENTS

MF CHECKED BY:

DW

HOMELAND TOWERS SITE ID:

NY452 PALISADES 2

VERIZON SITE NAME:

PALISADES 2

PROJECT ADDRESS:

COLUMBIA UNIVERSITY


61 RT. 9W PALISADES, NY 10964

DRAWING TITLE:

SITE LAYOUT

SHEET NUMBER:


C-1

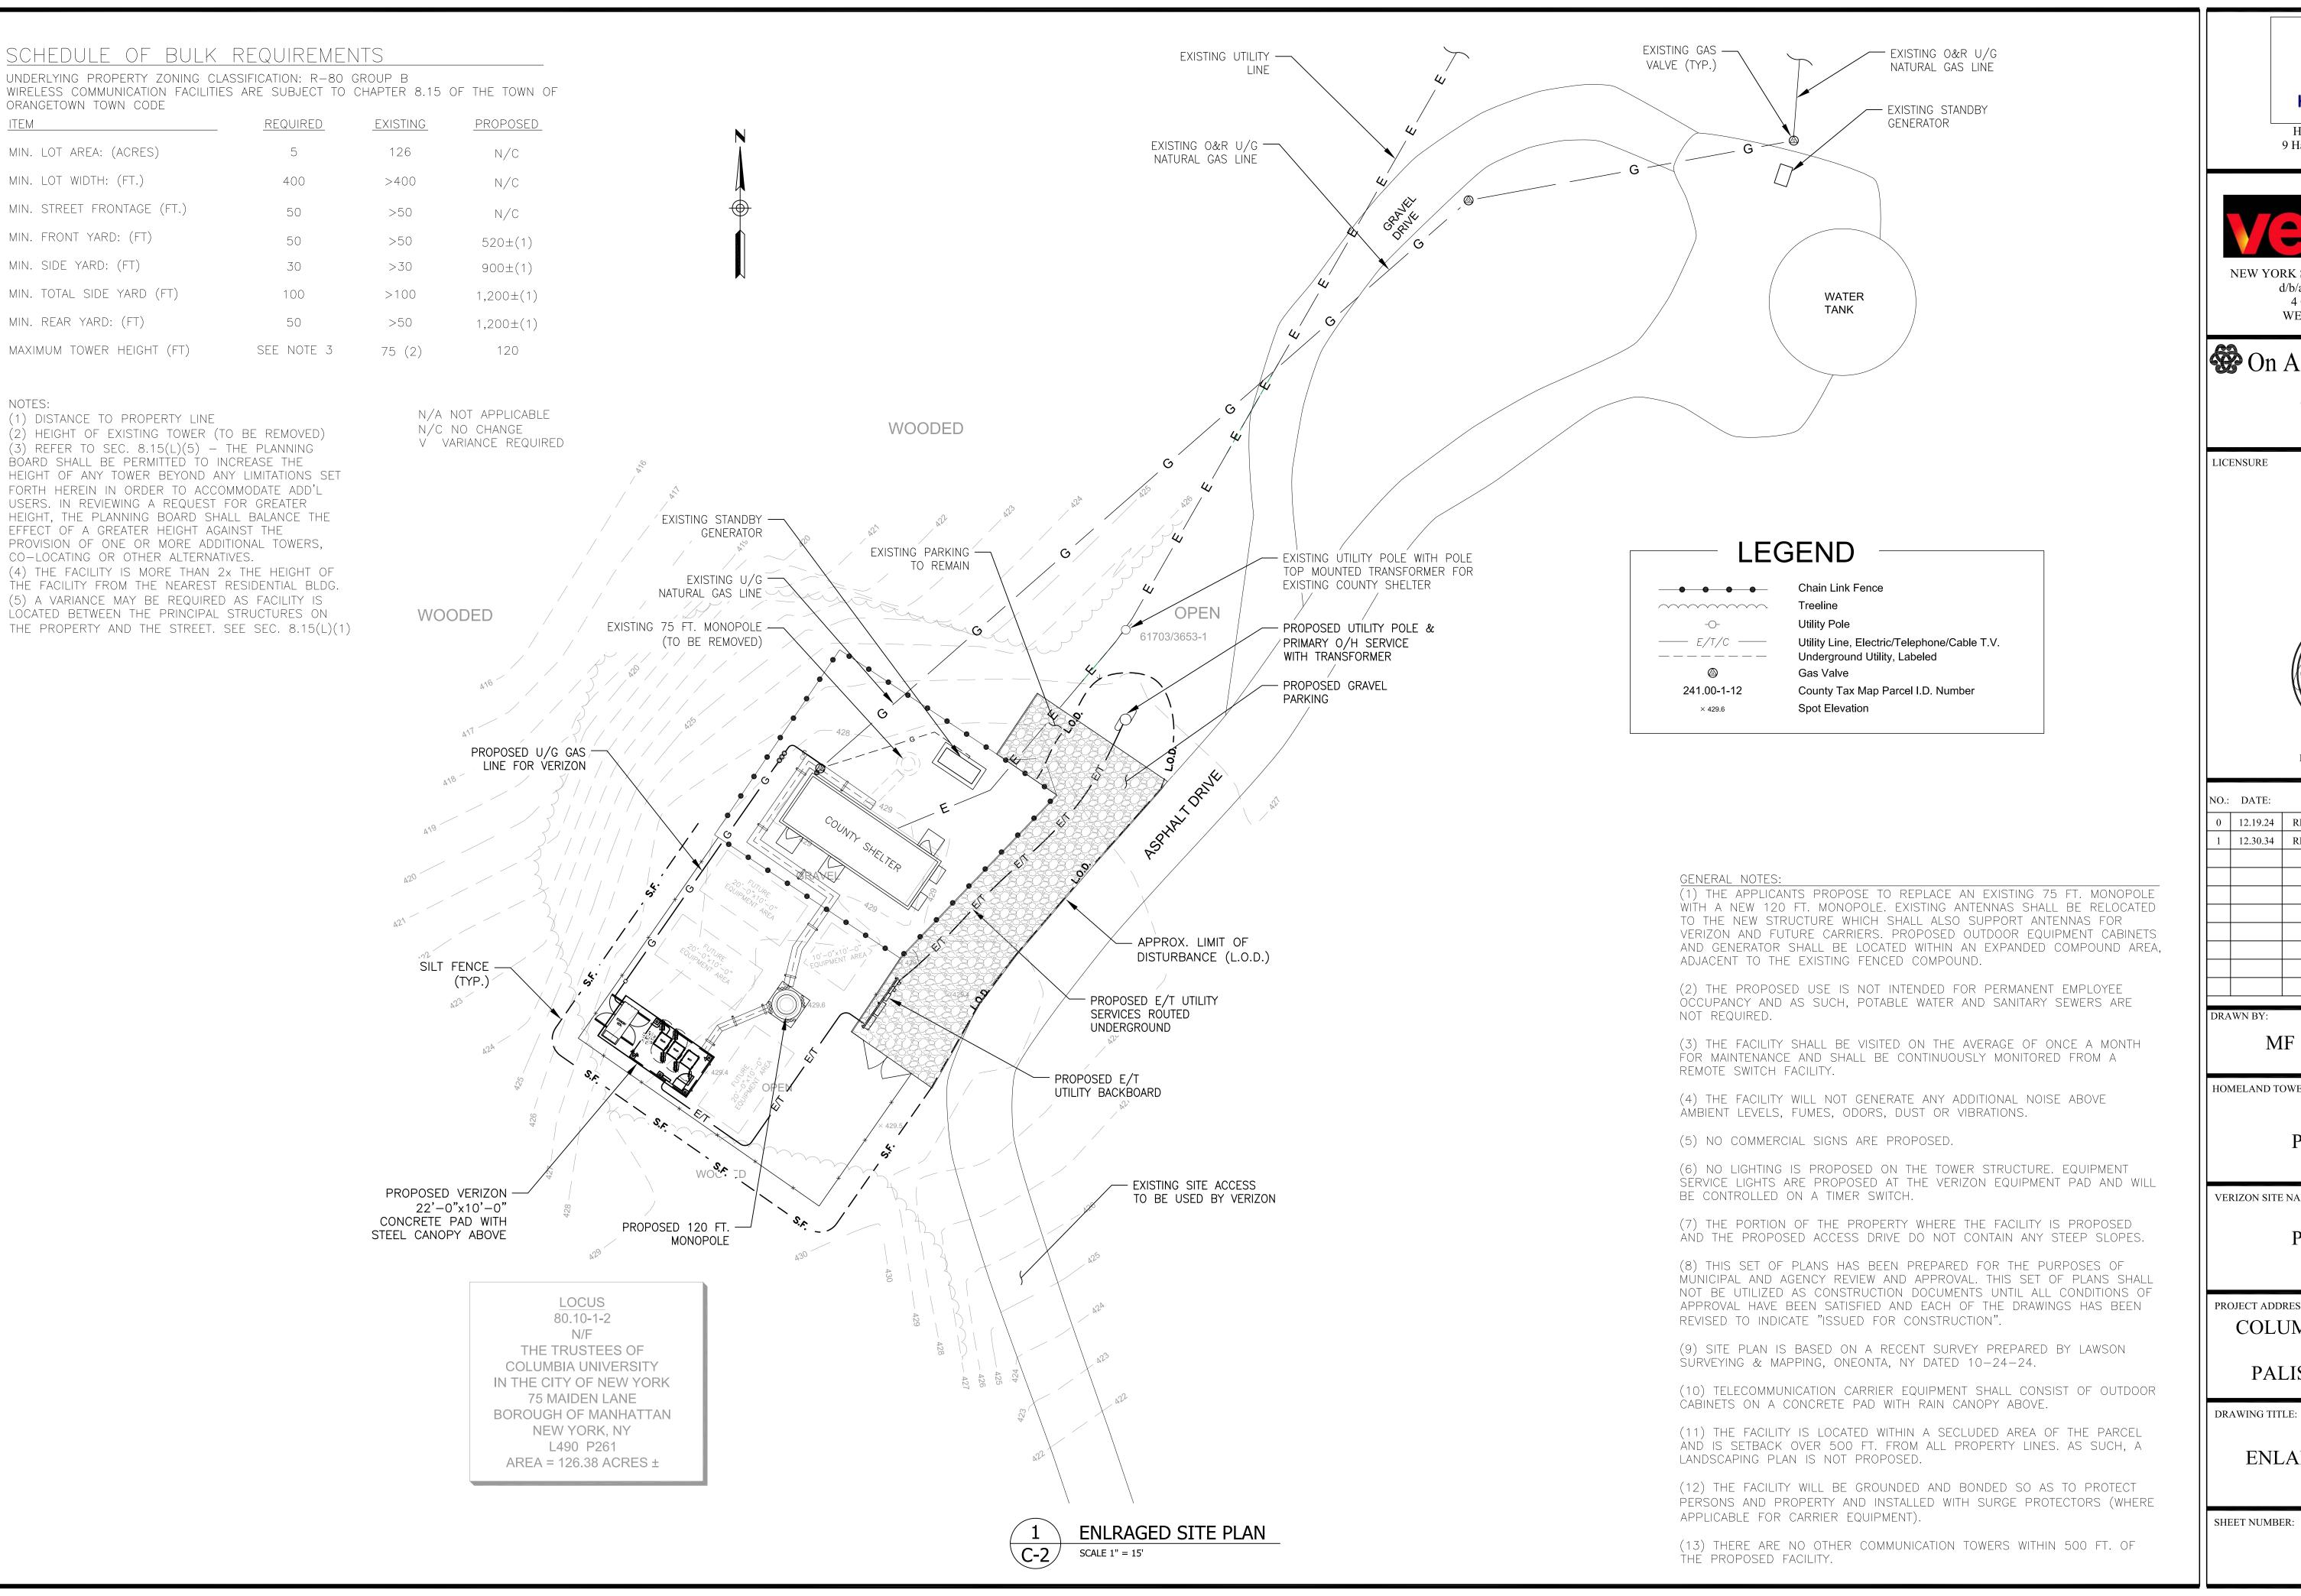





NEW YORK SMSA LIMITED PARTNERSHIP d/b/a VERIZON WIRELESS 4 CENTEROCK ROAD WEST NYACK, NY 10994

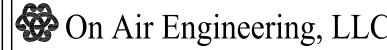

88 Foundry Pond Road Cold Spring, NY 10516 onair@optonline.net 201-456-4624



NY LIC NO. 078901 **SUBMISSIONS** 0 12 19.24 REVIEW SET

DAVID WEINPAHL, P.E.

U	12.13.24	KEVIEW SEI			
1	12.30.34	REVISED PE	R ATTORNEY COMMENTS		
DRAWN BY:			CHECKED BY:		
MF			DW		

HOMELAND TOWERS SITE ID:

NY452 PALISADES 2

VERIZON SITE NAME:

PALISADES 2

PROJECT ADDRESS: COLUMBIA UNIVERSITY 61 RT. 9W PALISADES, NY 10964

ENLARGED SITE PLAN

SITE NOTES:

- 1. ALL SITE WORK SHALL BE AS INDICATED ON THE DRAWINGS.
- 2. RUBBISH, STUMPS, DEBRIS, STICKS, STONES AND OTHER REFUSE SHALL BE REMOVED FROM THE SITE AND DISPOSED OF LEGALLY.
- 3. THE SITE SHALL BE GRADED TO CAUSE SURFACE WATER TO FLOW AWAY FROM THE BTS EQUIPMENT AND TOWER AREAS.
- 4. NO FILL OR EMBANKMENT MATERIAL SHALL BE PLACED ON FROZEN GROUND, FROZEN MATERIALS, SNOW OR ICE SHALL NOT BE PLACED IN ANY FILL OR EMBANKMENT.
- 5. THE SUB GRADE SHALL BE COMPACTED AND BROUGHT TO A SMOOTH UNIFORM GRADE PRIOR TO FINISHED SURFACE APPLICATION.
- 6. ALL EXISTING ACTIVE SEWER, WATER, GAS, ELECTIC, AND OTHER UTILITIES WHERE ENCOUNTERED IN THE WORK, SHALL BE PROTECTED AT ALL TIMES, AND WHERE REQUIRED FOR THE PROPER EXECUTION OF THE WORK, SHALL BE RELOCATED AS DIRECTED BY ENGINEERS. EXTREME CAUTION SHOULD BE USED BY THE CONTRACTOR WHEN EXCAVATING OR PIER DRILLING AROUND OR NEAR UTILITIES.
- 7. ALL EXISTING INACTIVE SEWER, WATER, GAS, ELECTRIC, AND OTHER UTILITIES, WHICH INTERFERE WITH THE EXECUTION OF THE WORK, SHALL BE REMOVED AND/OR CAPPED, PLUGGED OR OTHERWISE DISCONTINUED AT POINTS WHICH WILL NOT INTERFERE WITH THE EXECUTION OF THE WORK, SUBJECT TO THE APPROVAL OF ENGINEERING.
- 8. THE AREAS OF THE OWNERS PROPERTY DISTURBED BY THE WORK SHALL BE GRADED TO A UNIFORM SLOPE, FERTILIZED, SEEDED, AND COVERED WITH MULCH.
- 9. CONTRACTOR SHALL MINIMIZE DISTURBANCE TO EXISTING SITE DURING CONSTRUCTION. EROSION CONTROL MEASURES, IF REQUIRED DURING CONSTRUCTION, SHALL BE IN CONFORMANCE WITH THE NEW YORK STATE STANDARDS AND SPECIFICATIONS FOR SEDIMENT AND EROSION CONTROL.
- 10. ALL RESTORATION ISSUES SHALL BE COMPLETED WITHIN 72 HOURS OF THE COMPLETION OF THE WORK ACTIVITY OR WITHIN A REASONABLE AMOUNT OF TIME AS DIRECTED BY THE CONSTRUCTION MANAGER/ ENGINEER.
- 11. CARE SHALL BE TAKEN TO RETAIN NATURAL GROWTH AND PREVENT DAMAGE TO TREES, WITHIN AND OUTSIDE THE LIMITS OF CONSTRUCTION AND SPECIFIED WORK AREAS, CAUSED BY EQUIPMENT AND MATERIALS. ANY DAMAGE TO THIS NATURAL GROWTH SHALL BE RESTORED AT THE EXPENSE OF THE CONTRACTOR.
- 12. ALL AREAS DISTURBED BY THE CONTRACTOR WITHOUT AUTHORIZATION SHALL BE RESTORED BY THE CONTRACTOR.
- 13. IN THE EVENT THE CONTRACTOR DAMAGES AN EXISTING UTILITY SERIVCE CAUSING AN INTERUPPTION IN SAID SERVICE, HE SHALL IMMEDIATELY COMMENCE WORK TO RESTORE SERVICE AND MAY NOT CONTINUE HIS WORK OPERATION UNTIL SERIVCE IS RESTORED.

SEEDING SPECIFICATIONS:

- A. IF GROUND HAS BEEN PREVIOUSLY MULCHED, MULCH MUST BE REMOVED OR ADDITIONAL NITROGEN MUST BE ADDED.
- B. REMOVE ALL SURFACE STONES 2" OR LARGER AS WELL AS ALL DEBRIS SUCH AS WIRE, CABLE, TREE ROOTS, PIECES OF CONCRETE, CLODS, CLUMPS, OR OTHER UNSUITABLE MATERIAL.
- C. APPLY FERTILIZER AT 7.5 POUNDS PER 1,000 SQUARE FEET AND LIME AT 200 POUNDS PER 1,000 SQUARE FEET UNLESS SOIL TESTING FOR REQUIREMENTS IS PERFORMED.
- D. NO MOWING IS TO BE UNDERTAKEN UNTIL THE MAJORITY OF THE VEGETATION IS AT LEAST 6" HIGH. MOWING SHOULD CUT THE TOP 1/3 OF VEGETATION. DO NOT UNDER ANY CIRCUMSTANCES CUT VEGETATION BELOW
- E. DO NOT APPLY ANY FORM OF WEED CONTROL UNTIL GRASS HAS BEEN MOWED AT LEAST 4 TIMES.
- F. THESE SEEDING MEASURES ARE NOT TO BE USED ON SLOPES IN EXCESS OF 2:1 GRADING.
- G. PERMANENT SEEDING MEASURES ARE TO BE USED INSTEAD OF TEMPORARY SEEDING MEASURES WHERE WORK IS TO BE SUSPENDED FOR A PERIOD OF TIME LONGER THAN 1 YEAR.
- H. IF THERE IS NO EROSION, BUT SEED SURVIVAL IS LESS THAN 100 PLANTS PER SQUARE FOOT AFTER 4 WEEKS OF GROWTH, RE-SEED AS PLANTING SEASON ALLOWS.
- I. ALL DISTURBED AREAS OUTSIDE THE PAVEMENT AREA SHALL BE LOAMED AND SEEDED IN ACCORDANCE WITH THE SUGGESTED SEEDING MIXTURES TABLE.

SILT FENCE SPECIFICATIONS:

A. SYNTHETIC FILTER FABRIC SHALL BE A PERVIOUS SHEET OF PROPYLENE, NYLON, POLYESTER, ETHYLENE, OR SIMILAR FILAMENTS AND SHALL BE CERTIFIED BY THE MANUFACTURER OR SUPPLIER AS CONFORMING TO THE FOLLOWING MINIMUM REQUIREMENTS:

1. FILTERING EFFICIENCY 75 PERCENT (MIN)

2. GRAB TENSILE STRENGTH 100 POUNDS

15 PERCENT 3. ELONGATION AT FAILURE

4. MULLEN BURST STRENGTH 250 POUNDS PER SQUARE INCH

50 POUNDS

0.2 GALLONS PER

5. PUNCTURE STRENGTH

(MIN)


6. APPARENT OPENING SIZE 0.60mm< X<0.90mm

7. FLOW RATE SQUARE FOOT PER MINUTE

8. PERMITTIVITY 0.05 PER SECOND


9. ULTRAVIOLET RADIATION STABILITY 70 PERCENT AFTER 500 HOURS OF EXPOSURE (MIN)

- B. STAKES ARE TO BE MADE OUT OF HARDWOOD WITH A MINIMUM CROSS SECTIONAL AREA OF 1.5 SQUARE INCHES OR STEEL POSTS WITH A MINIMUM WEIGHT OF 0.5 POUNDS PER LINEAR FOOT.
- C. TORN OR PUNCTURED GEOTEXTILES SHALL NOT BE USED. ON SLOPES WHERE SURFACE FLOW FOLLOWS THE SILT FENCE LINE, PERPENDICULAR SILT FENCE CHECKS SHALL BE INSTALLED AT 50 FOOT INTERVALS.
- D. LINES OF SILT FENCE SHOULD FOLLOW CONTOUR LINES 5-10 FEET DOWN GRADIENT FROM THE SLOPE. WHERE CONTOUR LINES CAN NOT BE FOLLOWED PERPENDICULAR WINGS SHOULD BE PLACED AT 50 FOOT INTERVALS.

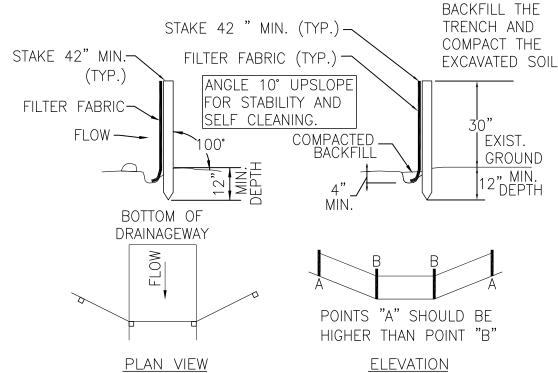

- MINIMUM LENGTH OF SILT FENCE IS 15 L.F.
- MAXIMUM POST SPACING IS 10 L.F. 3. JOINTS ONLY AT SUPPORT POST WITH MINIMUM 6" OVERLAP, SECURELY SEALED.
- 4. SEDIMENTATION DEPOSITS SHALL BE REMOVED WHEN THEY REACH 1/2 THE HEIGHT OF THE SILT FENCE.
- 5. SILT FENCE SHALL NOT BE USED IN A WATER COURSE. 6. UPON ESTABLISHMENT OF GROUND COVER ON DISTURBED AREAS, AND WHEN DIRECTED BY THE ENGINEER, FENCE WILL BE REMOVED AND ANY SEDIMENTATION WILL BE THINLY SPREAD UPON EXISTING GROUND COVER.



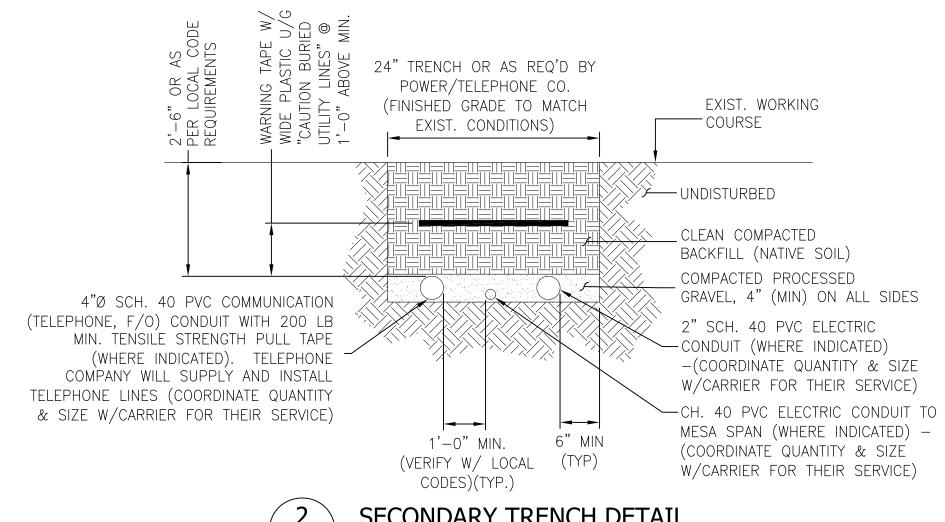









NEW YORK SMSA LIMITED PARTNERSHIP d/b/a VERIZON WIRELESS 4 CENTEROCK ROAD WEST NYACK, NY 10994

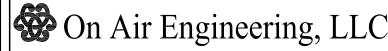

88 Foundry Pond Road Cold Spring, NY 10516 onair@optonline.net 201-456-4624

LICENSURE

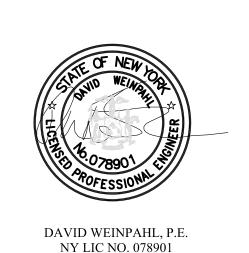

NO.:	DATE:	SUBMISSIONS
0	12.19.24	REVIEW SET
1	12.30.34	REVISED PER ATTORNEY COMMENTS

HOMELAND TOWERS SITE ID:

NY452 PALISADES 2

VERIZON SITE NAME:

PALISADES 2


PROJECT ADDRESS: COLUMBIA UNIVERSITY 61 RT. 9W


DRAWING TITLE:

CIVIL NOTES & DETAILS

PALISADES, NY 10964

SHEET NUMBER:

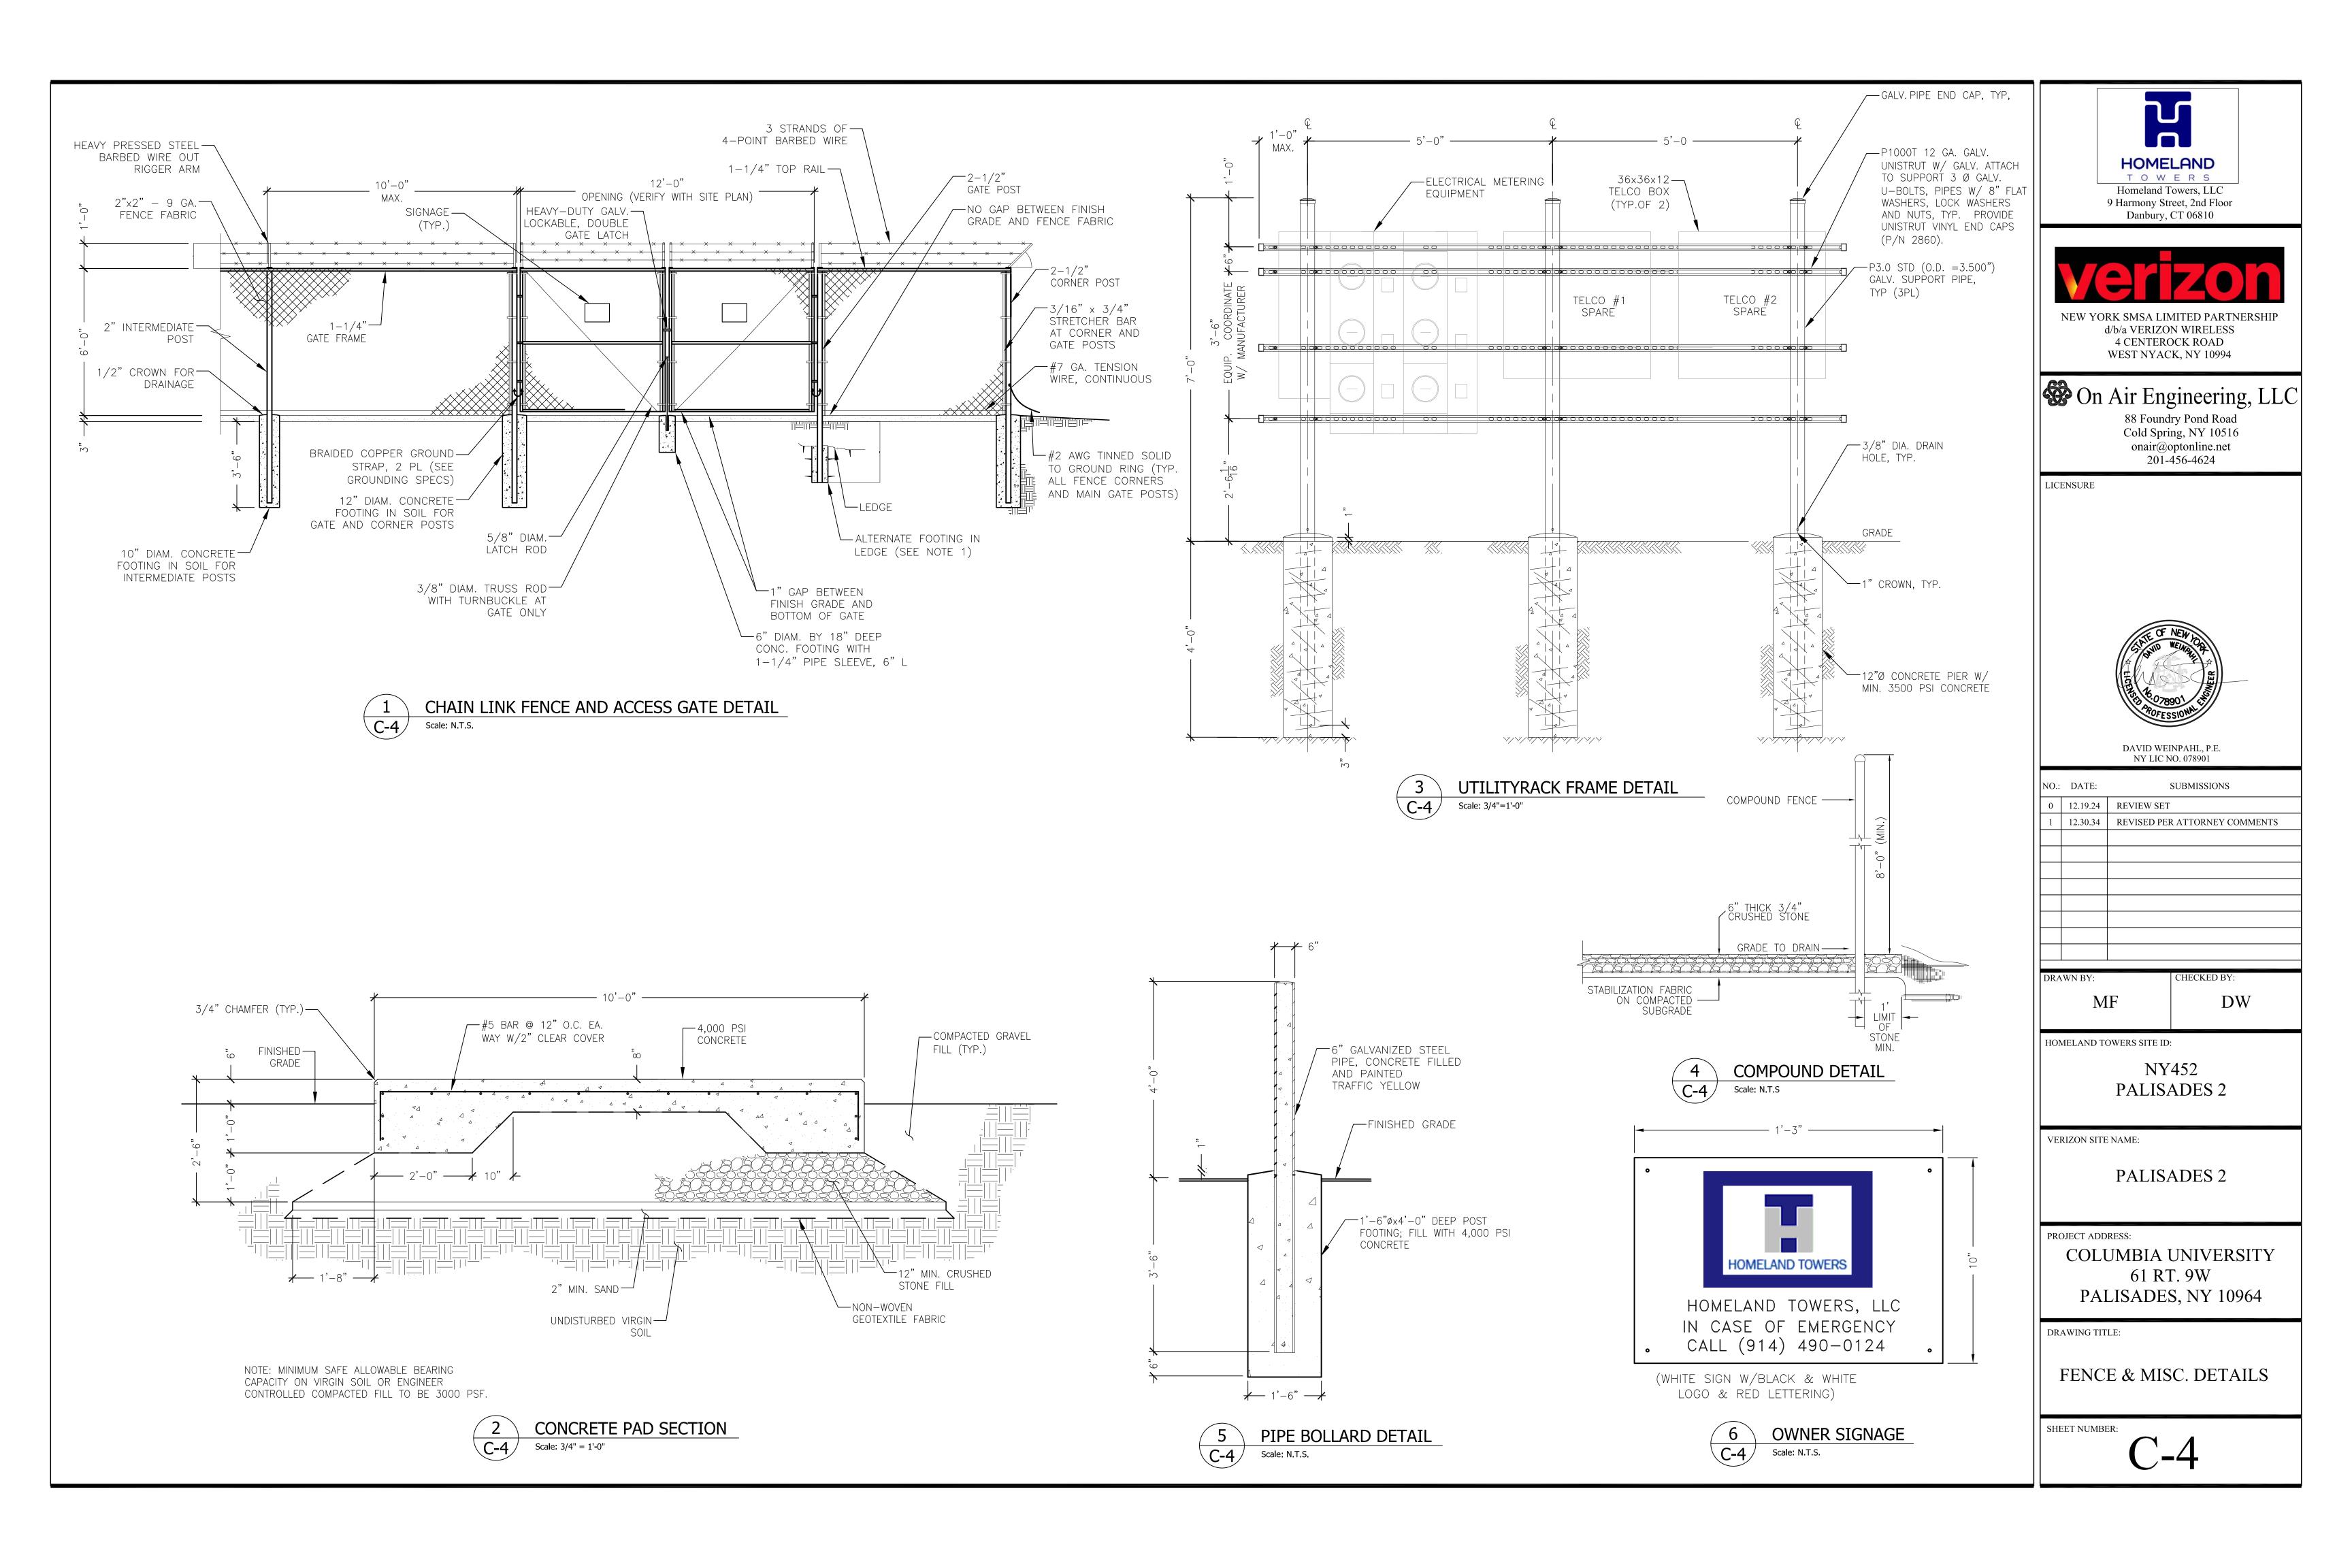

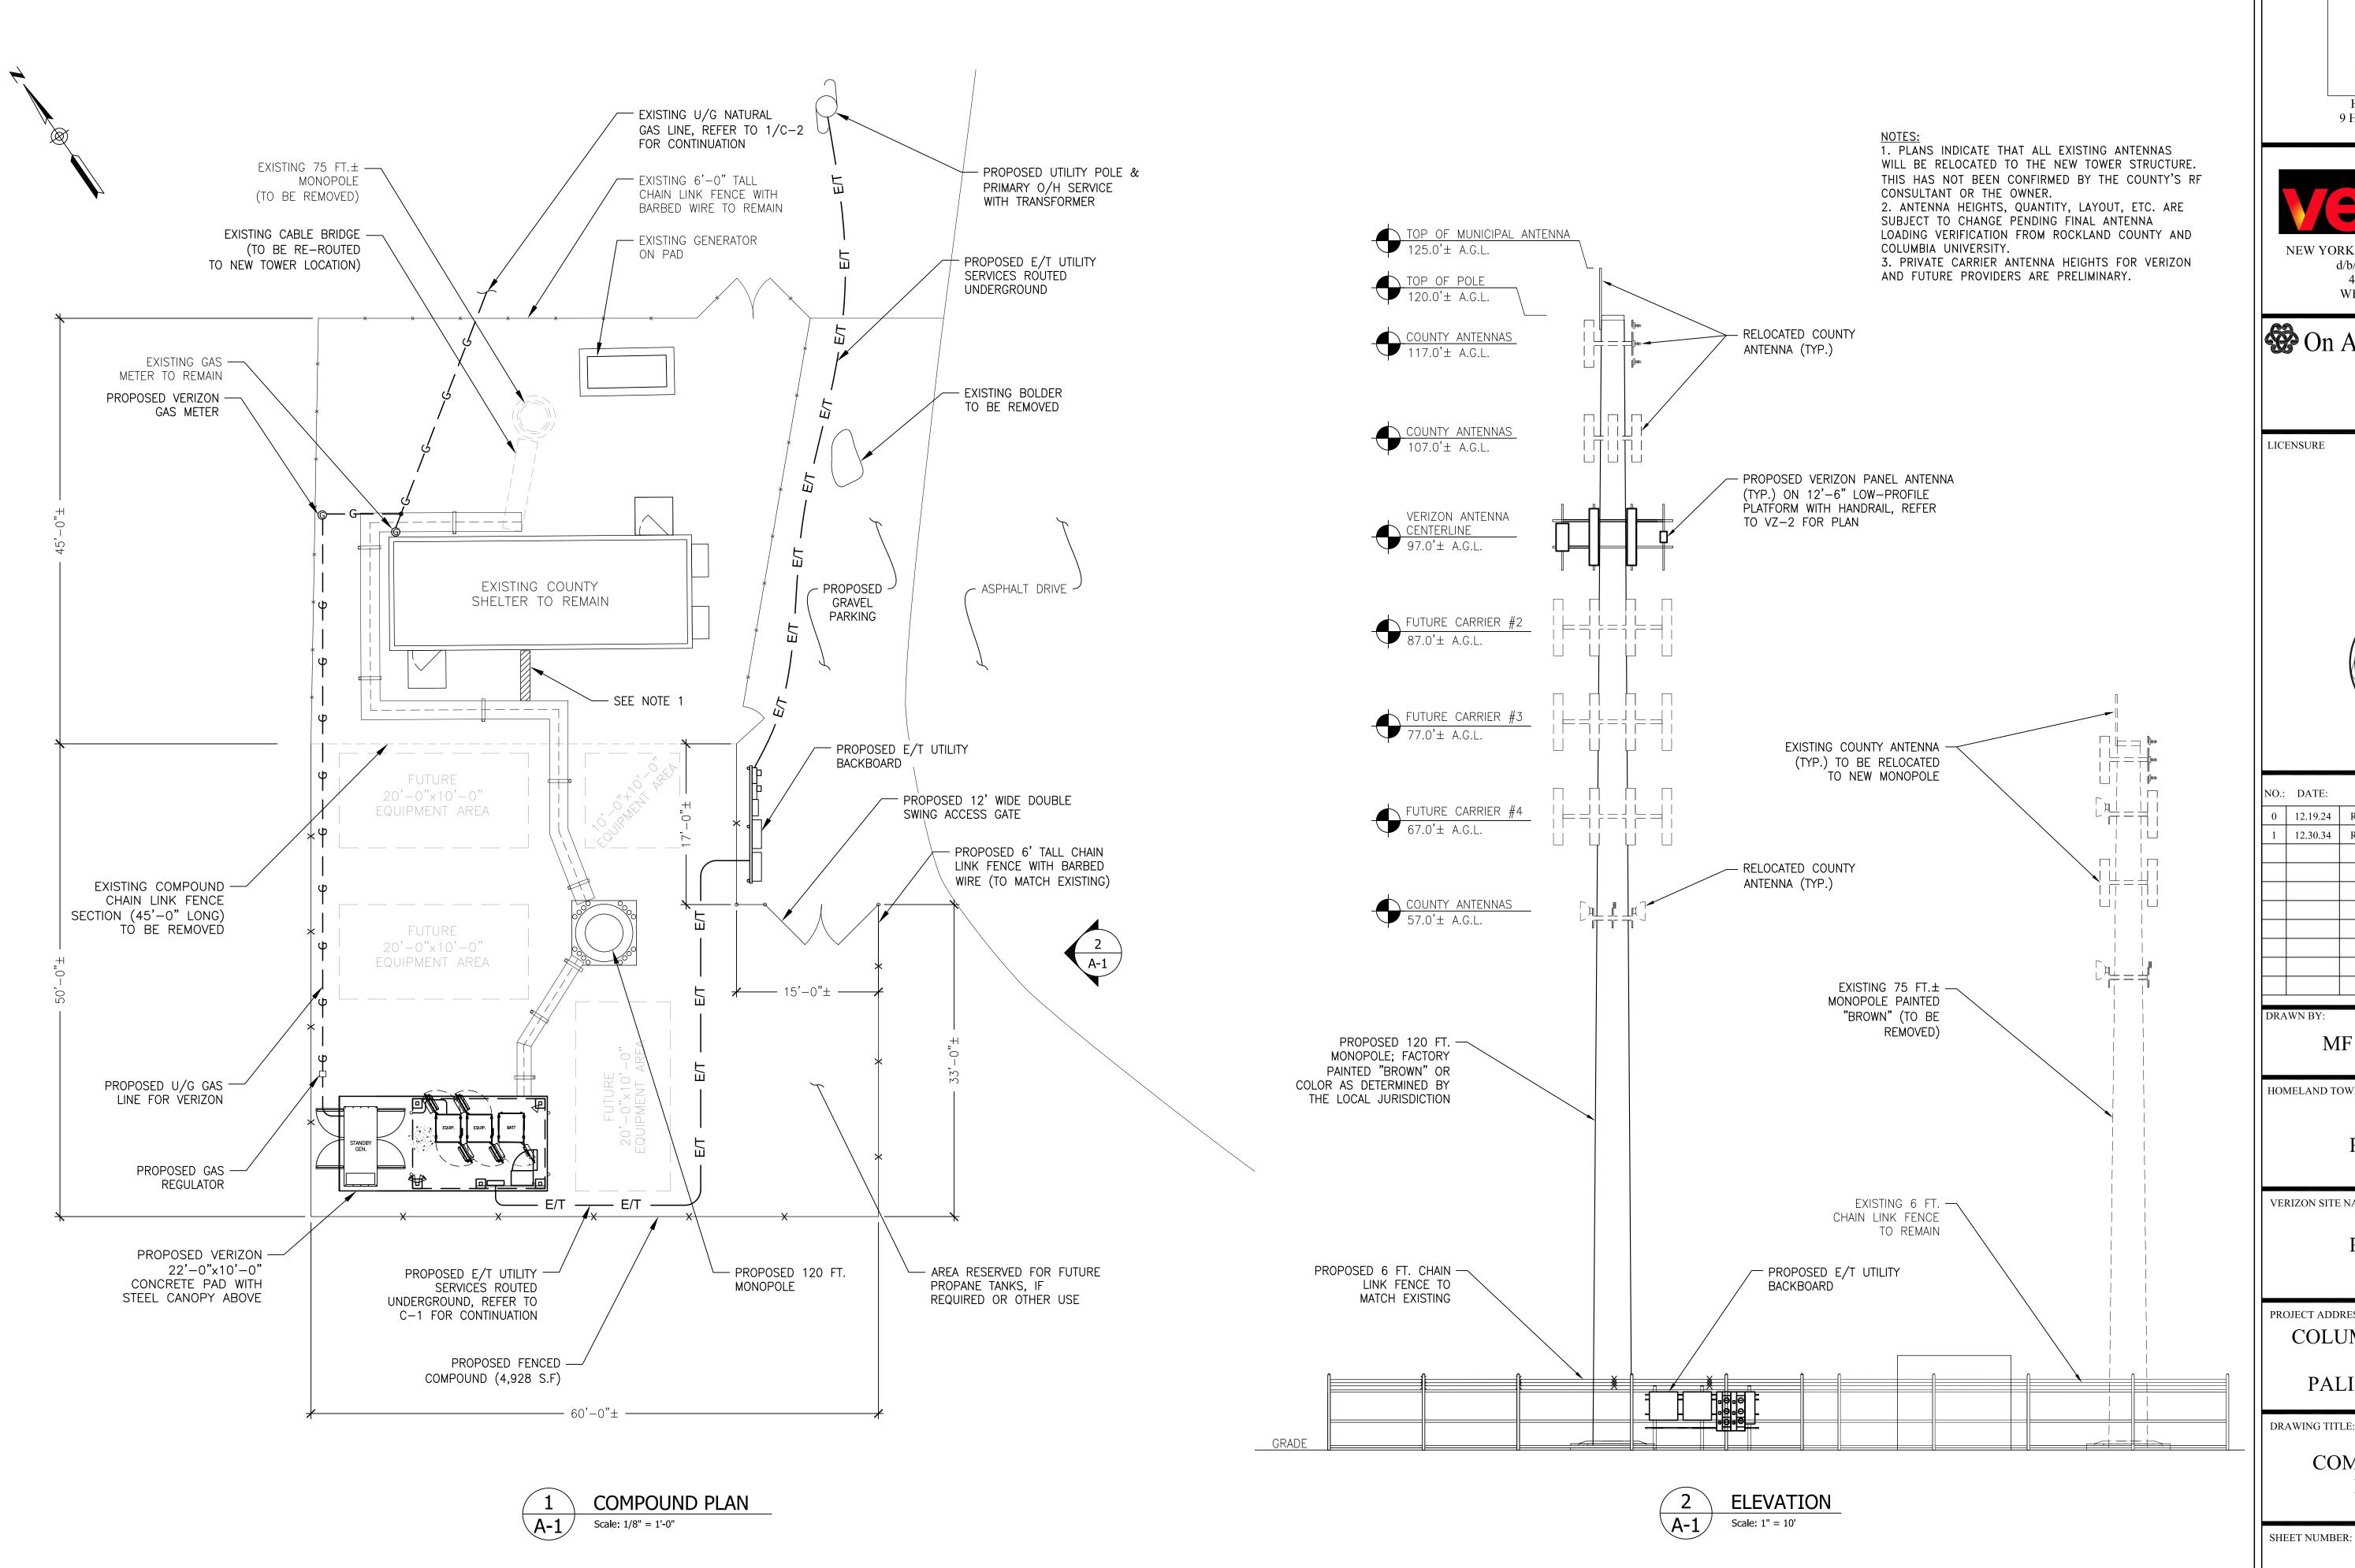




9 Harmony Street, 2nd Floor Danbury, CT 06810




NEW YORK SMSA LIMITED PARTNERSHIP d/b/a VERIZON WIRELESS 4 CENTEROCK ROAD WEST NYACK, NY 10994

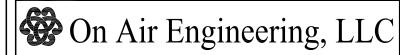

88 Foundry Pond Road Cold Spring, NY 10516 onair@optonline.net 201-456-4624

LICENSURE

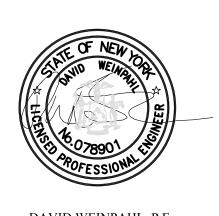

DAVID WEINPAHL, P.E. NY LIC NO. 078901

SUBMISSIONS

0	12.19.24	REVIEW SET	
1	12.30.34	REVISED PER	R ATTORNEY COMMENTS
DRA	WN BY:		CHECKED BY:
MF			DW
	1 V1	Γ	$ $ \mathcal{D} \mathcal{W}

HOMELAND TOWERS SITE ID:

NY452 PALISADES 2


VERIZON SITE NAME:


PALISADES 2

PROJECT ADDRESS: COLUMBIA UNIVERSITY 61 RT. 9W PALISADES, NY 10964

DRAWING TITLE:

COMPOUND PLAN & **ELEVATION**

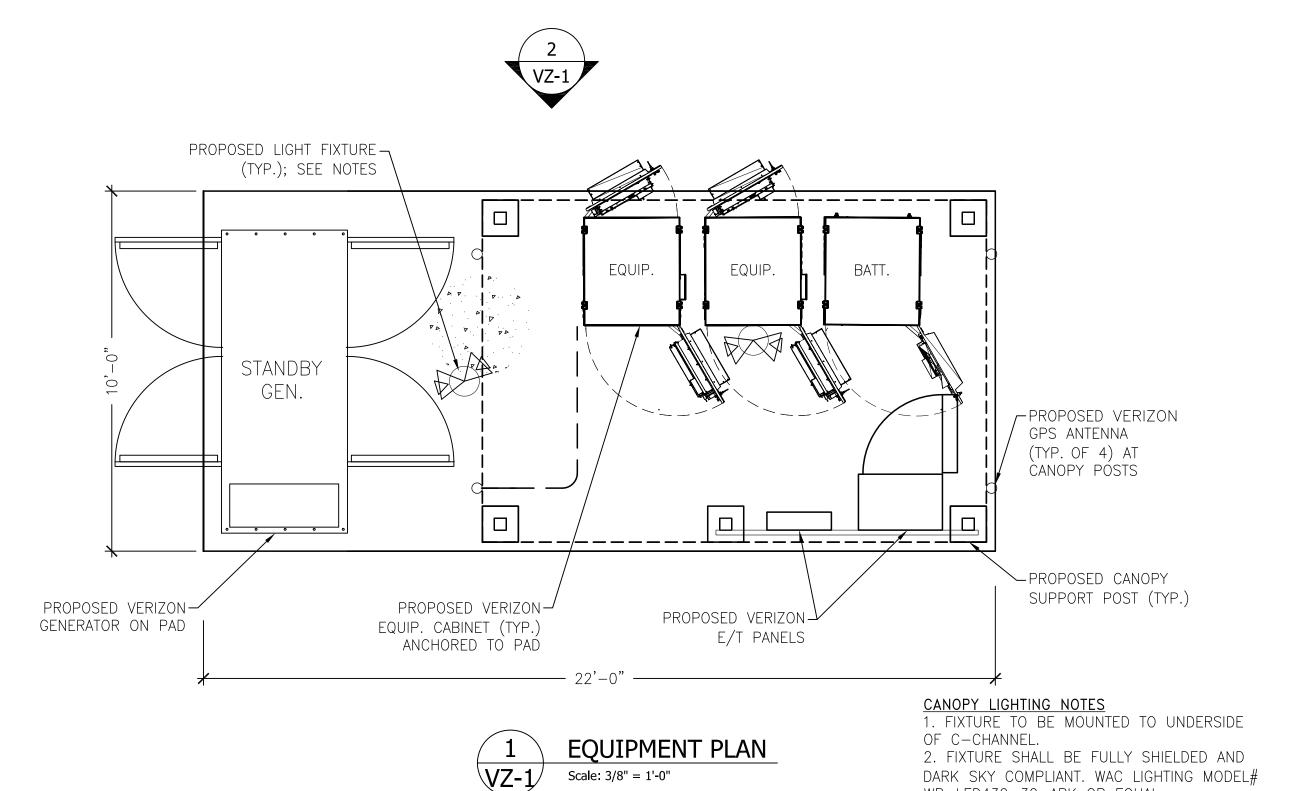

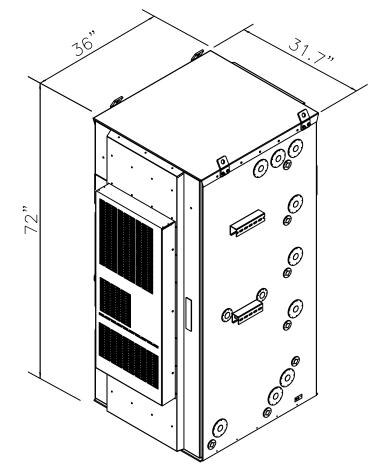

72"	
7	
7	
	0.

HEIGHT | WIDTH |

31.7"


72"

6	•	
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010	:#: :\u:	

GENERAC GENERATOR SPECIFICATIONS					
MODEL #	LENGTH	WIDTH	HEIGHT	WEIGHT	
SG050NA	94.8"	38.0"	57.5"	2,341 LBS	



50kW GENERAC GAS GENERATOR Scale: N.T.S.

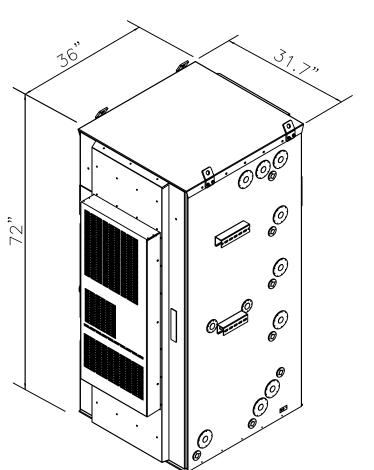

DELTA BATTERY CABINET				
HEIGHT	WIDTH	DEPTH	WEIGHT	
72"	31.7"	36"	2,500 LBS	



WP-LED430-30-ABK OR EQUAL.

3. CONTROL ON 4-HOUR MANUAL TIMER SWITCH BY LEVITON OR EQUAL. LOCATE SWITCH ADJACENT TO PANELBOARD.




DELTA EQUIPMENT CABINET


DEPTH

36"

WEIGHT

800 LBS

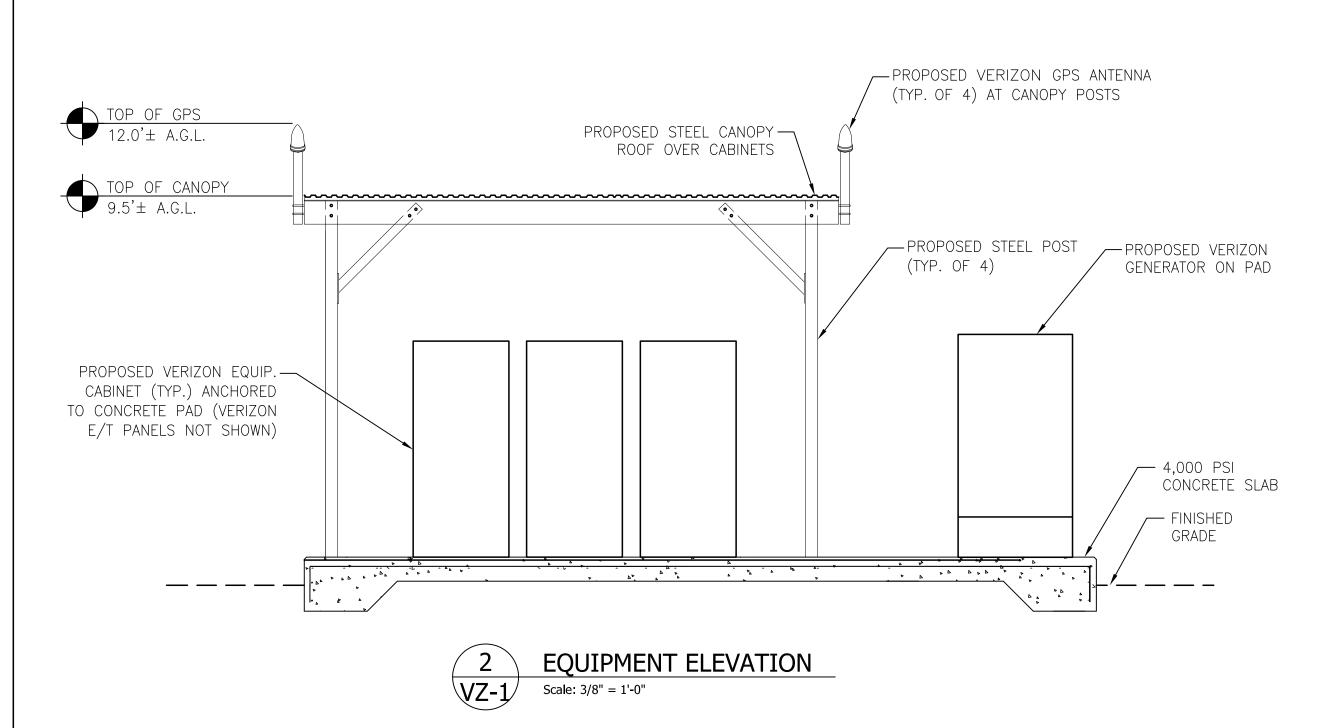

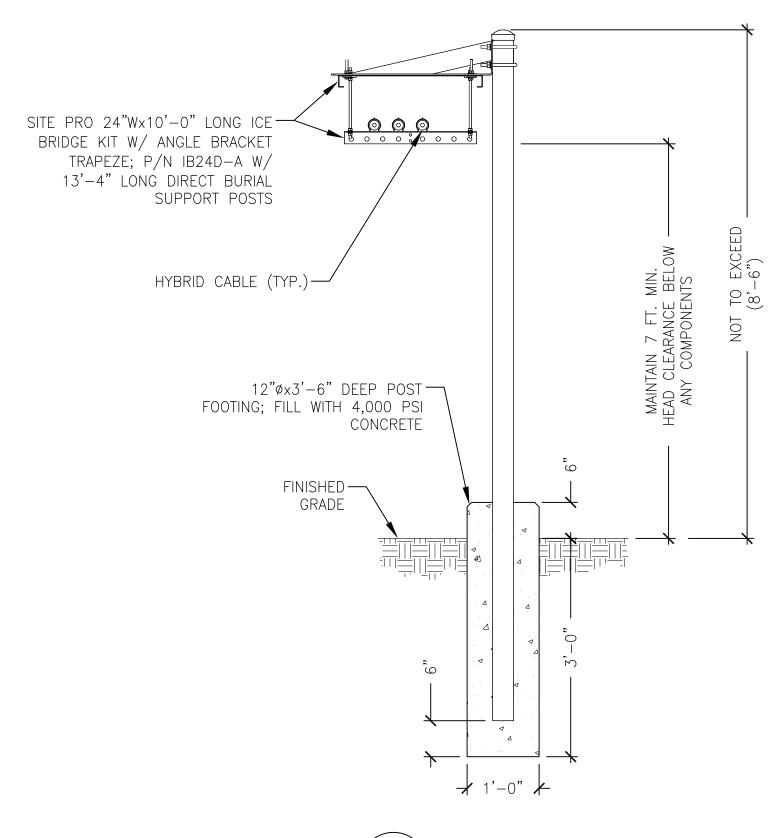

CABLE BRIDGE DETAIL Scale: N.T.S.





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On Air Engineering, LLC

88 Foundry Pond Road Cold Spring, NY 10516 onair@optonline.net 201-456-4624

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DRA	WN BY:	CHECKED BY:

DW

HOMELAND TOWERS SITE ID:

MF

NY452 PALISADES 2

VERIZON SITE NAME:

PALISADES 2


PROJECT ADDRESS:

COLUMBIA UNIVERSITY 61 RT. 9W PALISADES, NY 10964


DRAWING TITLE:

VERIZON EQUIPMENT PLAN & DETAILS

SHEET NUMBER: VZ-1

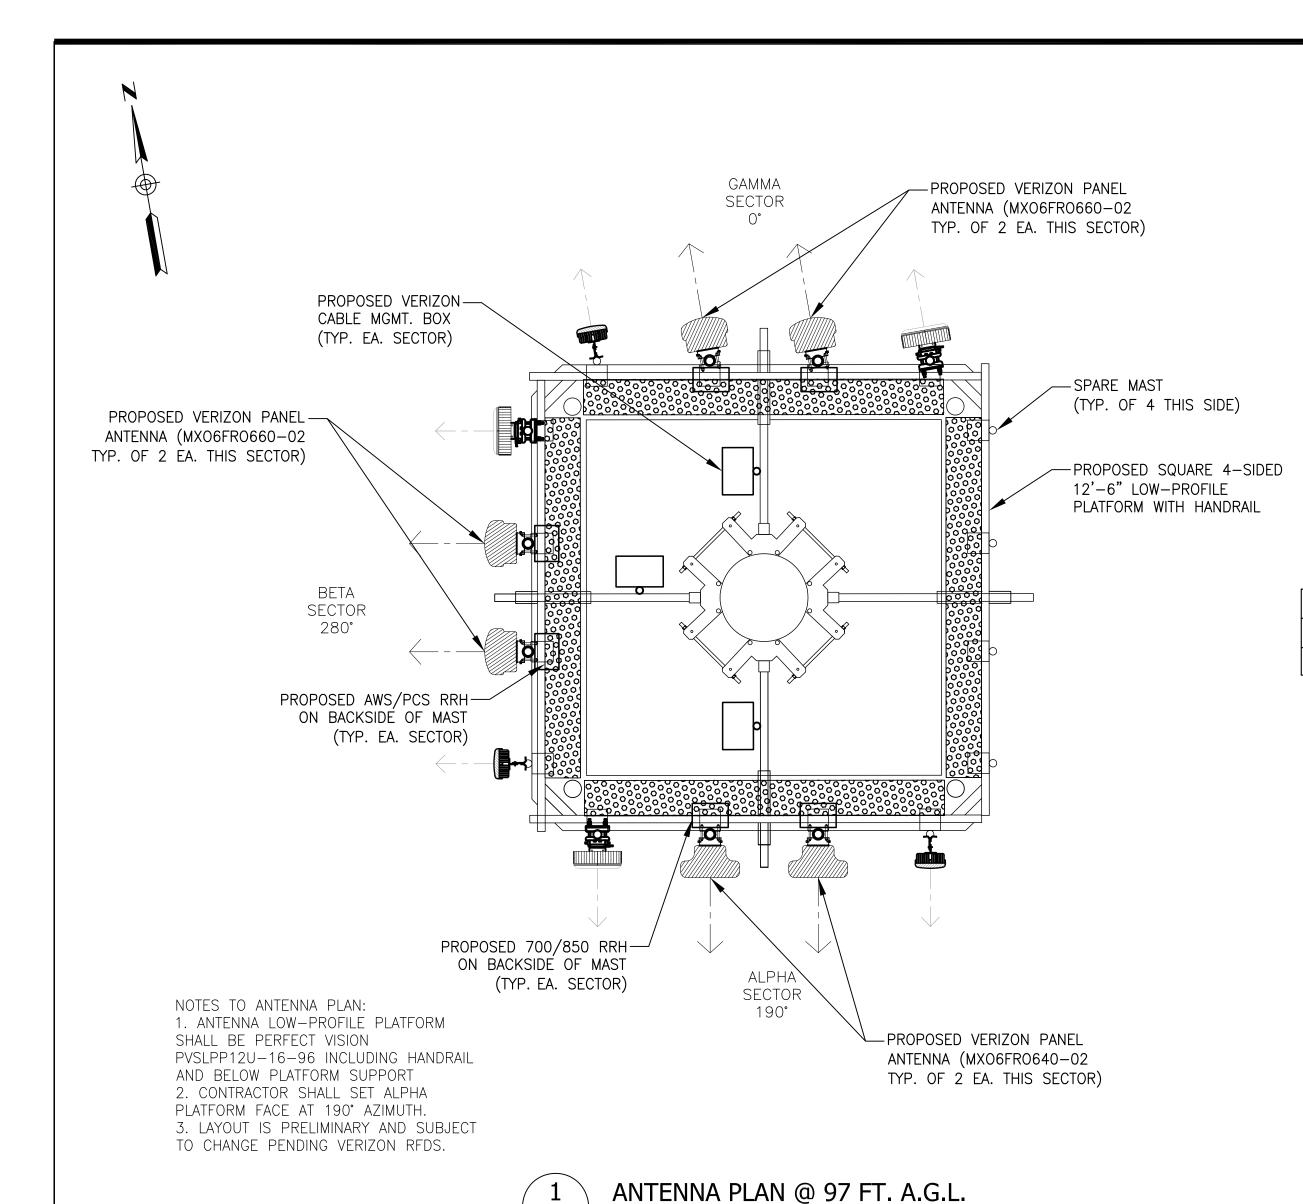

Scale: 3/8"=1'-0"

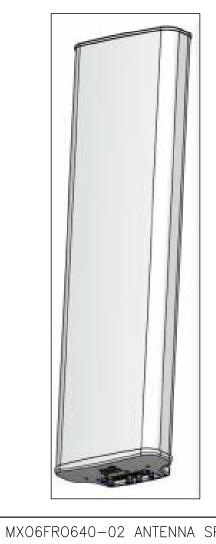

MXO6FRO640-02 ANTENNA SPEC. DEPTH WEIGHT 19.8" 10.7" | 60.1 LBS



MXO6FRO660-02 ANTENNA SPEC.

DEPTH WEIGHT

10.7" | 60.1 LBS

HEIGHT WIDTH

71.3"

'MXO6' ANTENNA SPEC.

Scale: N.T.S.

NOTES TO VERIZON EQUIPMENT DETAILS/SPECIFICATIONS:

1. ANTENNAS AND EQUIPMENT ARE SUBJECT TO CHANGE
BASED ON AVAILABILITY AT TIME OF CONSTRUCTION.

KS-24119L-112A GPS ANTENNA SPEC

HEIGHT WIDTH DIAMETER WEIGHT

5" | 16.06" | 3.17" | 0.6 LBS

GPS ANTENNA DETAIL

*ALL MOUNTING OPTIONS FIT PIPES OF 1"-1.45" MAX. DIA.

VZ-2 Scale: N.T.S

15.4"

MT6413 ANTENNA/RRH SPECIFICATIONS				
HEIGHT WIDTH DEPTH WEIGH				
28.9"	15.75"	5.5"	57.3 LBS	






CBRS INTEGRATED ANTENNA SPECIFICATIONS					
COMPONENT	HEIGHT	WIDTH	DEPTH	WEIGHT	
ANTENNA	ANTENNA 12.3"		1.4"	4.4 LBS	
RRH	11.8"	8.7"	4.2"	18.7 LBS	



CBRS ANTENNA SPEC.


SAMSUNG RRH 750/800 ORAN SPECIFICATIONS			
HEIGHT	WIDTH	DIAMETER	WEIGHT
15"	15"	9.1"	70.3 LBS

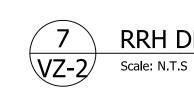

RRH DETAIL - 700/850



1					
	SAMSUNG RRH AWS/PCS ORAN SPECIFICATIONS				
	HEIGHT WIDTH		DIAMETER	WEIGHT	
	15"	15"	10"	74.7 LBS	

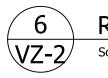

RRH DETAIL - AWS/PCS Scale: N.T.S



For your safety, obey all posted signs and site guidelines for working in radio frequency environments.


1. "YELLOW" CAUTION SIGN SHALL BE LOCATED AT COMPOUND ENTRY LOCATION AND VERIZON EQUIPMENT. 2. SIGN MEASURES 12"Hx8"W





This is an ACCESS POINT to an area with transmitting antennas. Obey all postings and boundaries beyond this point. Call Verizon Wireless at 1-800-264-6620 for more information. STATE: Site ID:


NOTE: 1. "GREEN" INFORMATION SIGN SHALL BE LOCATED AT COMPOUND ENTRY LOCATION AND VERIZON EQUIPMENT. 2. SIGN MEASURES 12"Wx8"H

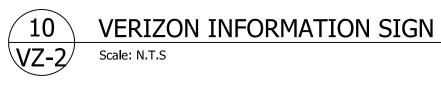





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DRAWN BY: DWMF

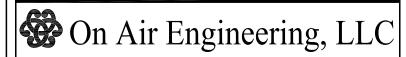HOMELAND TOWERS SITE ID:

NY452 PALISADES 2

VERIZON SITE NAME:

PALISADES 2

PROJECT ADDRESS: COLUMBIA UNIVERSITY 61 RT. 9W PALISADES, NY 10964

DRAWING TITLE:

ANTENNA PLAN & VERIZON EQUIP. SPECS

VZ-2



RAYCAP EQUIPMENT SPECIFICATIONS					
MODEL # HEIGHT WIDTH DEPTH WEIGHT COLOR					COLOR
RVZDC-6627-PF-48	29.5"	16.5"	12.6"	32 LBS	LIGHT GREY

CABLE DIST. BOX DETAIL VZ-2 Scale: N.T.S

CAUTION SIGN VZ-2 Scale: N.T.S