## BATTAGLIA RESIDENCE

8 MARYCREST ROAD, WEST NYACK, NY 10994

**OWNER:** 

JOE & FRAN BATTAGLIA 6 CHESTNUT PARK COURT NEW CITY, NY 10956

ARCHITECT:
MICHAEL SHILALE ARCHITECTS, LLP
140 Park Avenue
New City, NY 10956


STRUCTURAL + CIVIL ENGINEER:
ATZL, NASHER, & ZIGLER
234 North Main Street
New City, NY 10956



# 1. ALL PLAN DIMENSIONS ARE NOMINAL U.O.N. DIMENSIONS TO THE FINISHED FACE OF AN ELEMENT OR WALL WILL BE DESIGNATED WITH AN "F" AS SHOWN

 G.C. TO VERIFY ALL DIMENSIONS IN THE FIELD AND IS TO NOTIFY ARCHITECT IF THERE ARE ANY DISCREPANCIES

### **GENERAL NOTES**

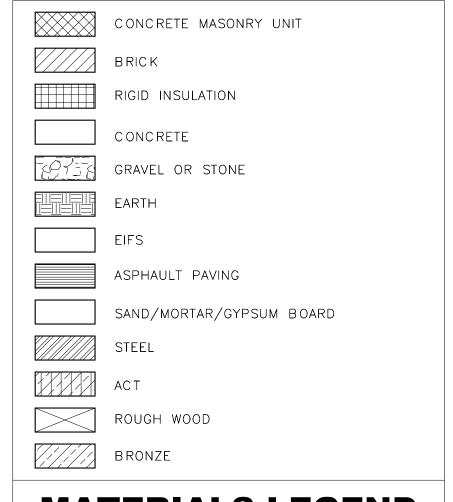

### MATERIALS LEGEND

∧ ∧ ⊤	
ACT	ACOUSTICAL CEILING TILE
A.F.F	ABOVE FINISH FLOOR
ASPH	ASPHAULT
BLK	BLOCK
BLK'G	BLOCKING
BUR	BUILT UP ROOFING
CLG	CEILING
CONC	CONCRETE
CONT	CONTINUOUS
C .J.	CONTROL JOINT
DN	DOWN
DIA	DIAMETER
DWG	DRAWING
E.F	EACH FACE
EIFS	EXTERIOR INSULATION AND
	FINISH SYSTEM
E.W	EACH WAY
E.W.C	ELECTRICAL WATER COOLER
EL	ELEVATION
ELC	ELECTRICAL CONTRACTOR
EXIST	EXISTING
EXP	EXPANSION
EXT'G	EXISTING
EXTR	EXTERIOR
FP	FIREPROOF
FIN.	FINISH(ED)
	• •
GA	GAUGE
GC	GENERAL CONTRACTOR
GALV	GALVANIZED
GL	GLASS
GWB	GYPSUM WALL BOARD
НМ	HOLLOW METAL
H.P.	HIGH POINT
HAC	HEATING & A/C CONTRACTOR
ITR	INDIVIDUAL TREATMENT ROOM
JT	JOINT
LAM	LAMINATE
LAV	LAVATORY
LP	LOW POINT
MAX	MAXIMUM
MFR	MANUFACTURER
MTL	METAL
MIN	MINIMUM
MO	MASONRY OPENING
N.I.C	NOT IN CONTRACT
NO.	NUMBER
OC	ON CENTER
OPN'G	OPENING
DRC	
PBC	PLUMBING CONTRACTOR
PLAS.LAM.	PLUMBING CONTRACTOR PLASTIC LAMINATE
	PLUMBING CONTRACTOR
PLAS.LAM. PL	PLUMBING CONTRACTOR PLASTIC LAMINATE PLATE
PLAS.LAM. PL PLY'D	PLUMBING CONTRACTOR PLASTIC LAMINATE PLATE PLYWOOD
PLAS.LAM. PL PLY'D RAD	PLUMBING CONTRACTOR PLASTIC LAMINATE PLATE PLYWOOD RADIUS
PLAS.LAM. PL PLY'D	PLUMBING CONTRACTOR PLASTIC LAMINATE PLATE PLYWOOD
PLAS.LAM. PL PLY'D RAD REF.CLG.	PLUMBING CONTRACTOR PLASTIC LAMINATE PLATE PLYWOOD RADIUS REFLECTED CEILING
PLAS.LAM. PL PLY'D RAD REF.CLG. REQ'D	PLUMBING CONTRACTOR PLASTIC LAMINATE PLATE PLYWOOD RADIUS REFLECTED CEILING REQUIRED
PLAS.LAM. PL PLY'D RAD REF.CLG. REQ'D RO	PLUMBING CONTRACTOR PLASTIC LAMINATE PLATE PLYWOOD RADIUS REFLECTED CEILING REQUIRED ROUGH OPENING
PLAS.LAM. PL PLY'D RAD REF.CLG. REQ'D	PLUMBING CONTRACTOR PLASTIC LAMINATE PLATE PLYWOOD RADIUS REFLECTED CEILING REQUIRED
PLAS.LAM. PL PLY'D RAD REF.CLG. REQ'D RO	PLUMBING CONTRACTOR PLASTIC LAMINATE PLATE PLYWOOD RADIUS REFLECTED CEILING REQUIRED ROUGH OPENING SIMILAR
PLAS.LAM. PL PLY'D RAD REF.CLG. REQ'D RO SIM STL	PLUMBING CONTRACTOR PLASTIC LAMINATE PLATE PLYWOOD RADIUS REFLECTED CEILING REQUIRED ROUGH OPENING SIMILAR STEEL
PLAS.LAM. PL PLY'D RAD REF.CLG. REQ'D RO SIM STL SUSP.CLG	PLUMBING CONTRACTOR PLASTIC LAMINATE PLATE PLYWOOD RADIUS REFLECTED CEILING REQUIRED ROUGH OPENING SIMILAR STEEL SUSPENDED CEILING
PLAS.LAM. PL PLY'D RAD REF.CLG. REQ'D RO SIM STL SUSP.CLG T.O.M.	PLUMBING CONTRACTOR PLASTIC LAMINATE PLATE PLYWOOD RADIUS REFLECTED CEILING REQUIRED ROUGH OPENING SIMILAR STEEL SUSPENDED CEILING TOP OF MASONRY
PLAS.LAM. PL PLY'D RAD REF.CLG. REQ'D RO SIM STL SUSP.CLG	PLUMBING CONTRACTOR PLASTIC LAMINATE PLATE PLYWOOD RADIUS REFLECTED CEILING REQUIRED ROUGH OPENING SIMILAR STEEL SUSPENDED CEILING TOP OF MASONRY
PLAS.LAM. PL PLY'D RAD REF.CLG. REQ'D RO SIM STL SUSP.CLG T.O.M. T.O.S.	PLUMBING CONTRACTOR PLASTIC LAMINATE PLATE PLYWOOD RADIUS REFLECTED CEILING REQUIRED ROUGH OPENING SIMILAR STEEL SUSPENDED CEILING TOP OF MASONRY TOP OF STEEL
PLAS.LAM. PL PLY'D RAD REF.CLG. REQ'D RO SIM STL SUSP.CLG T.O.M. T.O.S.	PLUMBING CONTRACTOR PLASTIC LAMINATE PLATE PLYWOOD RADIUS REFLECTED CEILING REQUIRED ROUGH OPENING SIMILAR STEEL SUSPENDED CEILING TOP OF MASONRY TOP OF STEEL TYPICAL
PLAS.LAM. PL PLY'D RAD REF.CLG. REQ'D RO SIM STL SUSP.CLG T.O.M. T.O.S. TYP U.O.N	PLUMBING CONTRACTOR PLASTIC LAMINATE PLATE PLYWOOD RADIUS REFLECTED CEILING REQUIRED ROUGH OPENING SIMILAR STEEL SUSPENDED CEILING TOP OF MASONRY TOP OF STEEL TYPICAL UNLESS OTHERWISE NOTED
PLAS.LAM. PL PLY'D RAD REF.CLG. REQ'D RO SIM STL SUSP.CLG T.O.M. T.O.S.	PLUMBING CONTRACTOR PLASTIC LAMINATE PLATE PLYWOOD RADIUS REFLECTED CEILING REQUIRED ROUGH OPENING SIMILAR STEEL SUSPENDED CEILING TOP OF MASONRY TOP OF STEEL TYPICAL
PLAS.LAM. PL PLY'D RAD REF.CLG. REQ'D RO SIM STL SUSP.CLG T.O.M. T.O.S. TYP U.O.N V.I.F.	PLUMBING CONTRACTOR PLASTIC LAMINATE PLATE PLYWOOD RADIUS REFLECTED CEILING REQUIRED ROUGH OPENING SIMILAR STEEL SUSPENDED CEILING TOP OF MASONRY TOP OF STEEL TYPICAL UNLESS OTHERWISE NOTED VERIFY IN FEILD
PLAS.LAM. PL PLY'D RAD REF.CLG. REQ'D RO SIM STL SUSP.CLG T.O.M. T.O.S. TYP U.O.N V.I.F. VCT	PLUMBING CONTRACTOR PLASTIC LAMINATE PLATE PLYWOOD RADIUS REFLECTED CEILING REQUIRED ROUGH OPENING SIMILAR STEEL SUSPENDED CEILING TOP OF MASONRY TOP OF STEEL TYPICAL UNLESS OTHERWISE NOTED VERIFY IN FEILD VINYL COMPOSITE TILE
PLAS.LAM. PL PLY'D RAD REF.CLG. REQ'D RO SIM STL SUSP.CLG T.O.M. T.O.S. TYP U.O.N V.I.F.	PLUMBING CONTRACTOR PLASTIC LAMINATE PLATE PLYWOOD RADIUS REFLECTED CEILING REQUIRED ROUGH OPENING SIMILAR STEEL SUSPENDED CEILING TOP OF MASONRY TOP OF STEEL TYPICAL UNLESS OTHERWISE NOTED VERIFY IN FEILD


### **ABBREVIATIONS**

DRAWING NO.	DRAWING NAME	DATE
T-000	COVER SHEET	1/20/25
A-001	GENERAL NOTES	1/20/25
C-101	SITE PLAN	1/20/25
C-102	EXISTING CONDITION PLAN	1/20/25
C-103	GRADING PLAN	1/20/25
C-104	EROSION & SEDIMENT CONTROL PLAN	1/20/25
C-105	TREE PLAN	1/20/25
C-106	SEWER PLAN & PROFILE	1/20/25
S-001	NOTES & SPECIFICATIONS	1/20/25
S-002	FOUNDATION PLAN	1/20/25
S-003	FRAMING PLAN	1/20/25
S-004	FRAMING PLAN	1/20/25
S-005	ROOF FRAMING PLAN	1/20/25
S-006	GARAGE FRAMING PLAN	1/20/25
S-007	DETAILS	1/20/25
S-008	DETAILS	1/20/25
S-009	DETAILS	1/20/25
A-010	PROPOSED ARCHITECTURAL SITE PLAN	1/20/25
A-100	PROPOSED CELLAR PLAN	1/20/25
A-101	PROPOSED FIRST FLOOR PLAN	1/20/25
A-102	PROPOSED SECOND FLOOR PLAN	1/20/25
A-103	PROPOSED ROOF PLAN	1/20/25
A-110	PROPOSED GARAGE FLOOR PLAN	1/20/25
A-111	PROPOSED GARAGE ROOF PLAN	1/20/25
A-200	PROPOSED BUILDING ELEVATIONS	1/20/25
A-210	PROPOSED GARAGE ELEVATIONS	1/20/25
A-300	PROPOSED BUILDING SECTIONS	1/20/25
A-310	PROPOSED GARAGE SECTIONS	1/20/25
A-350	PROPOSED WALL SECTIONS AND ENERGY NOTES	1/20/25
A-400	PROPOSED CELLAR RCP	1/20/25
A-401	PROPOSED FIRST FLOOR RCP	1/20/25
A-402	PROPOSED SECOND FLOOR RCP	1/20/25
A-410	PROPOSED GARAGE RCP	1/20/25
A-500	ROOF DETAILS	1/20/25
A-501	DOOR & WINDOW DETAILS	1/20/25
A-502	ARCHITECTURAL DETAILS	1/20/25
A-503	ARCHITECTURAL DETAILS	1/20/25
A-600	WINDOW + DOOR SCHEDULES	1/20/25
A-900	3D VIEWS	1/20/25
A-901	EXTERIOR PERSPECTIVE VIEWS	1/20/25


# Mechanical & Checked by Electrical Engineer: Structural Engineer: Engineer: Date Date

### LIST OF DRAWINGS



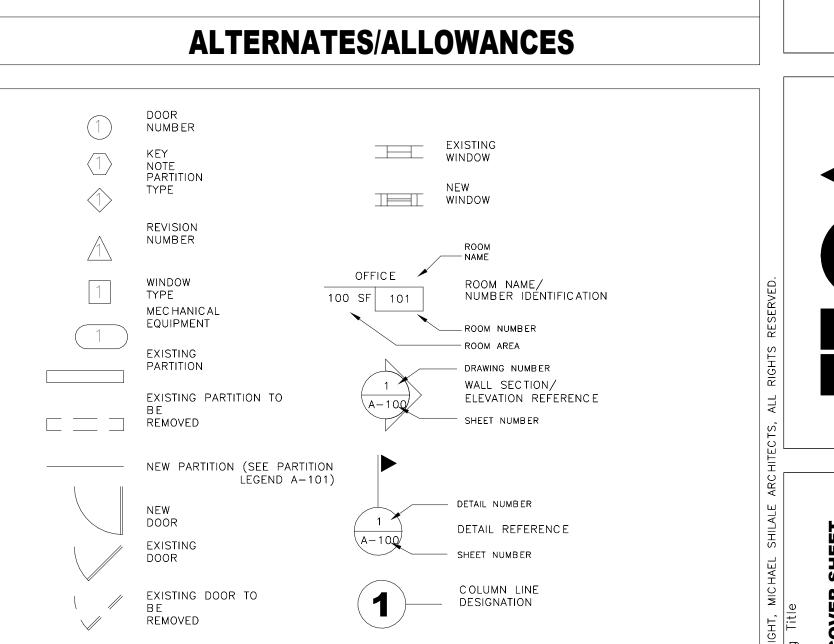

**SYMBOLS LEGEND** 

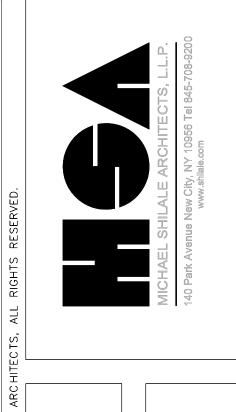


COVER SHEET


TODO


TOTAL


TODO

TOTAL

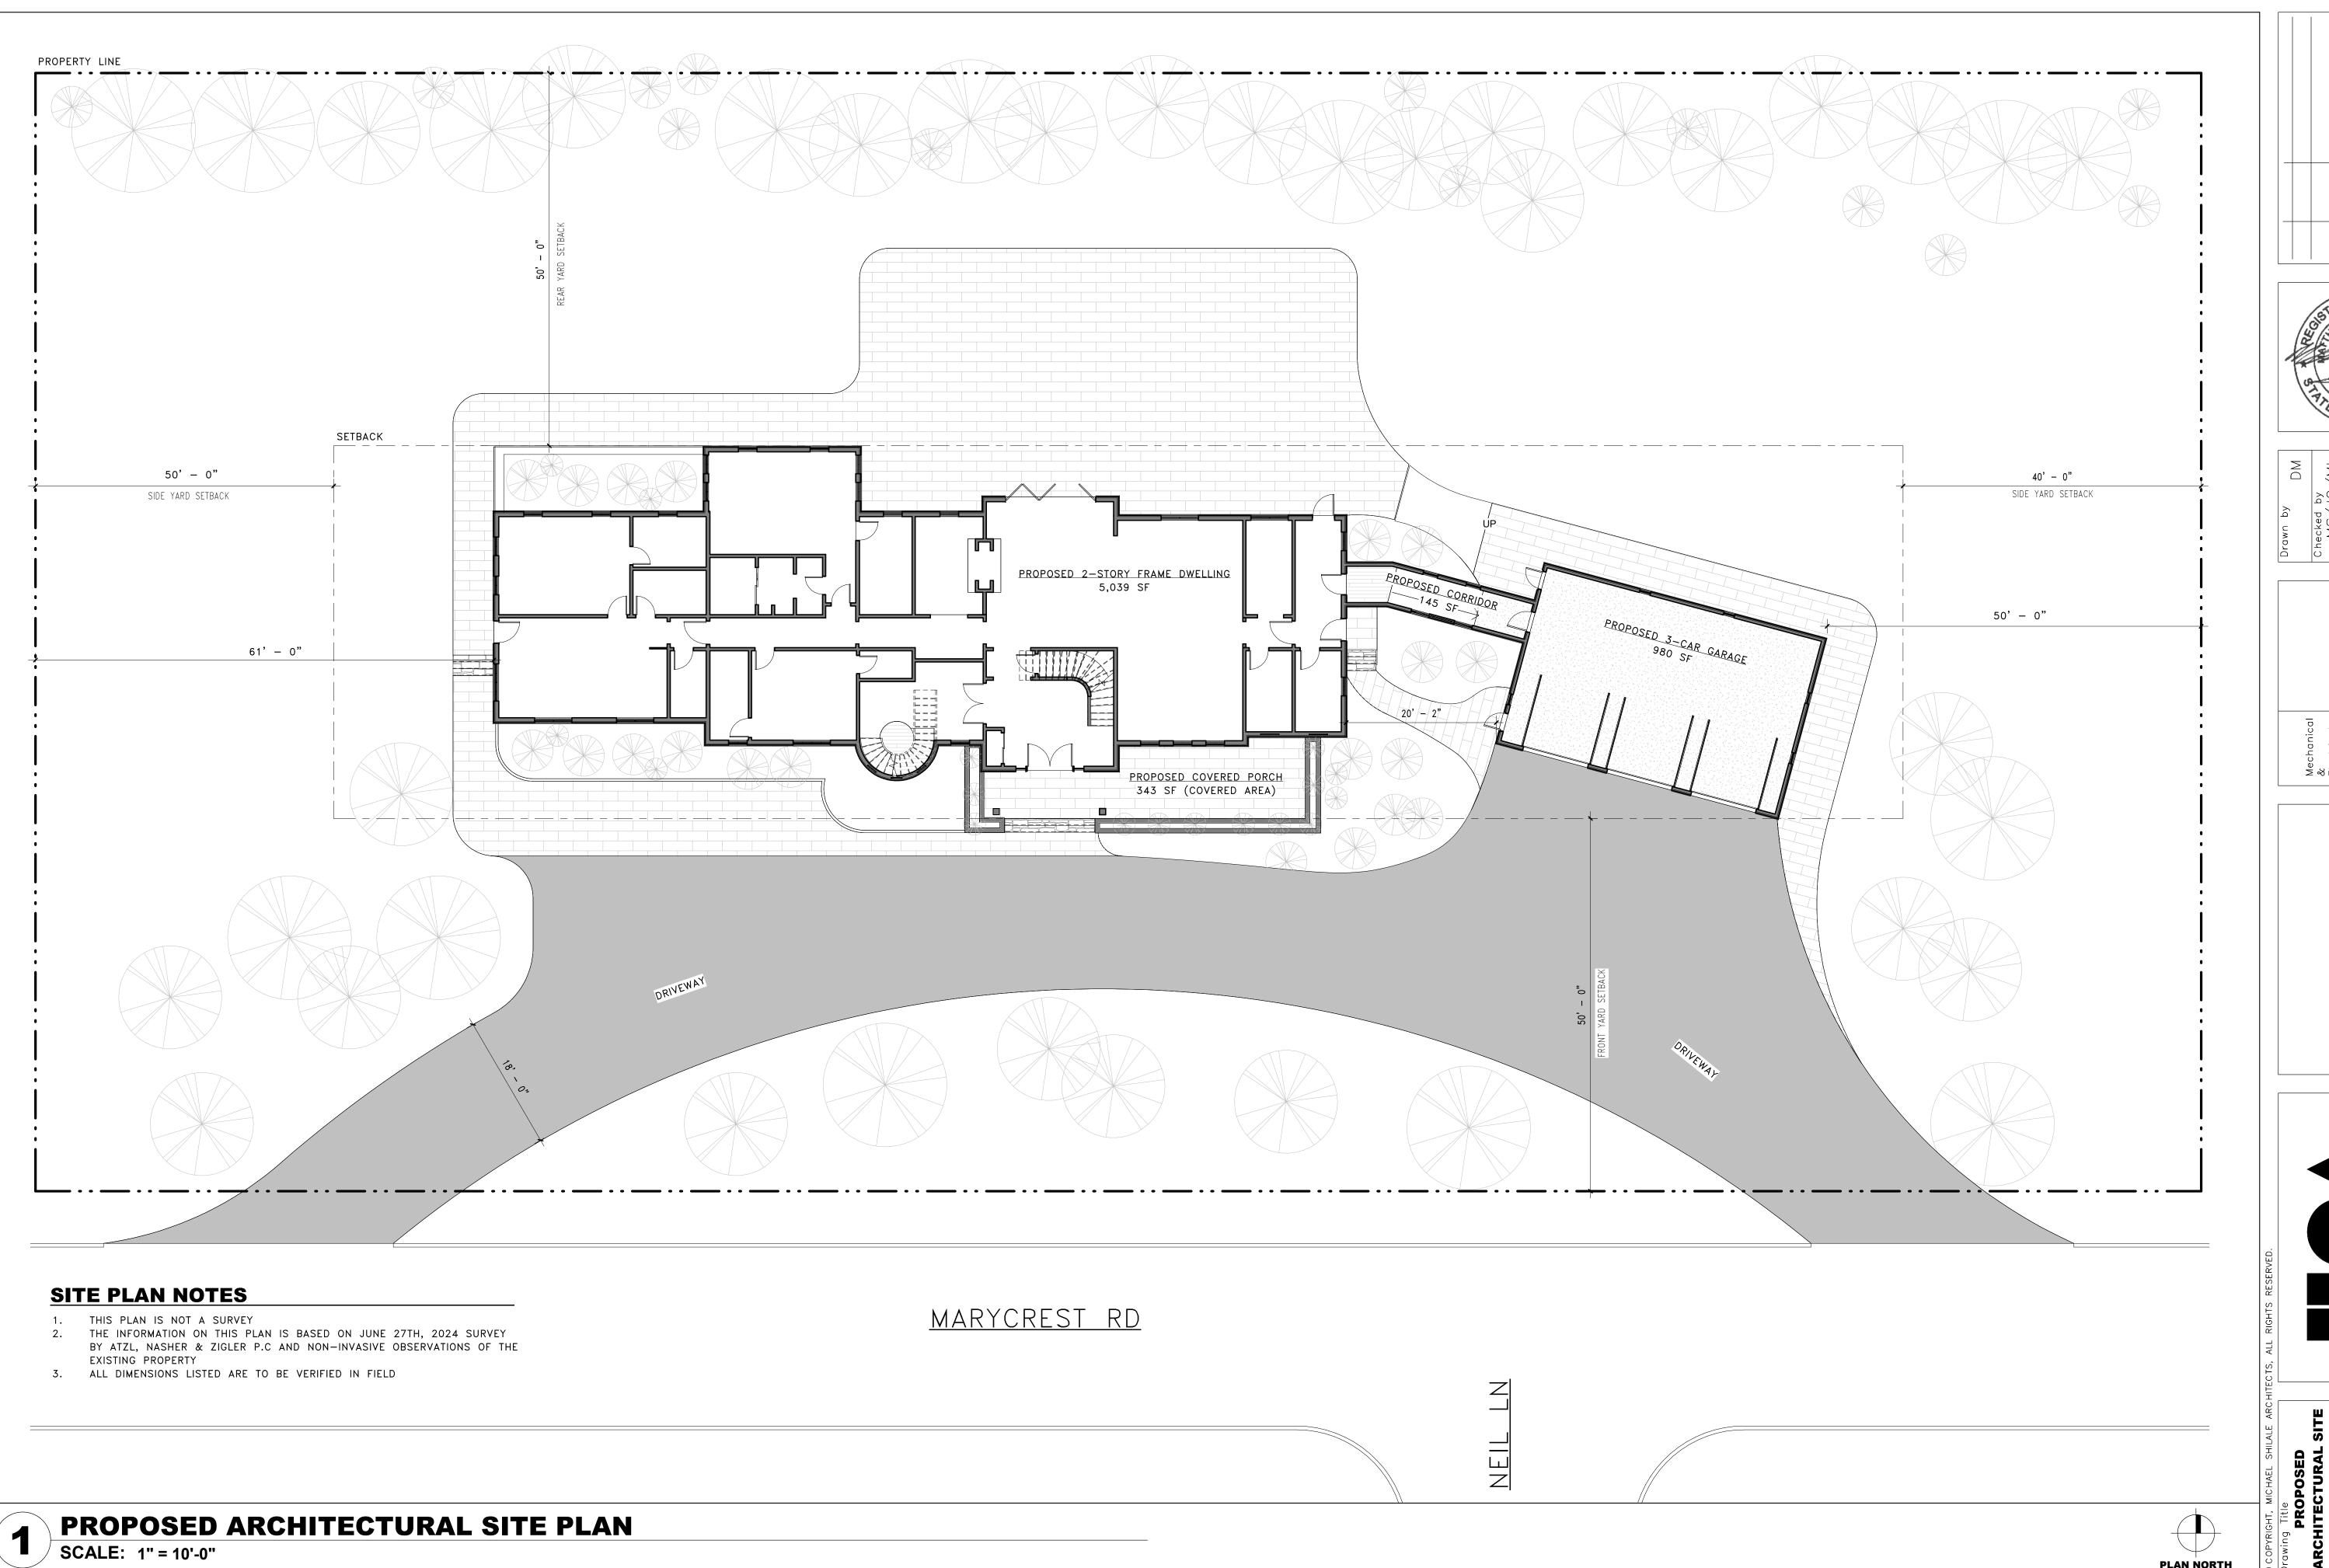


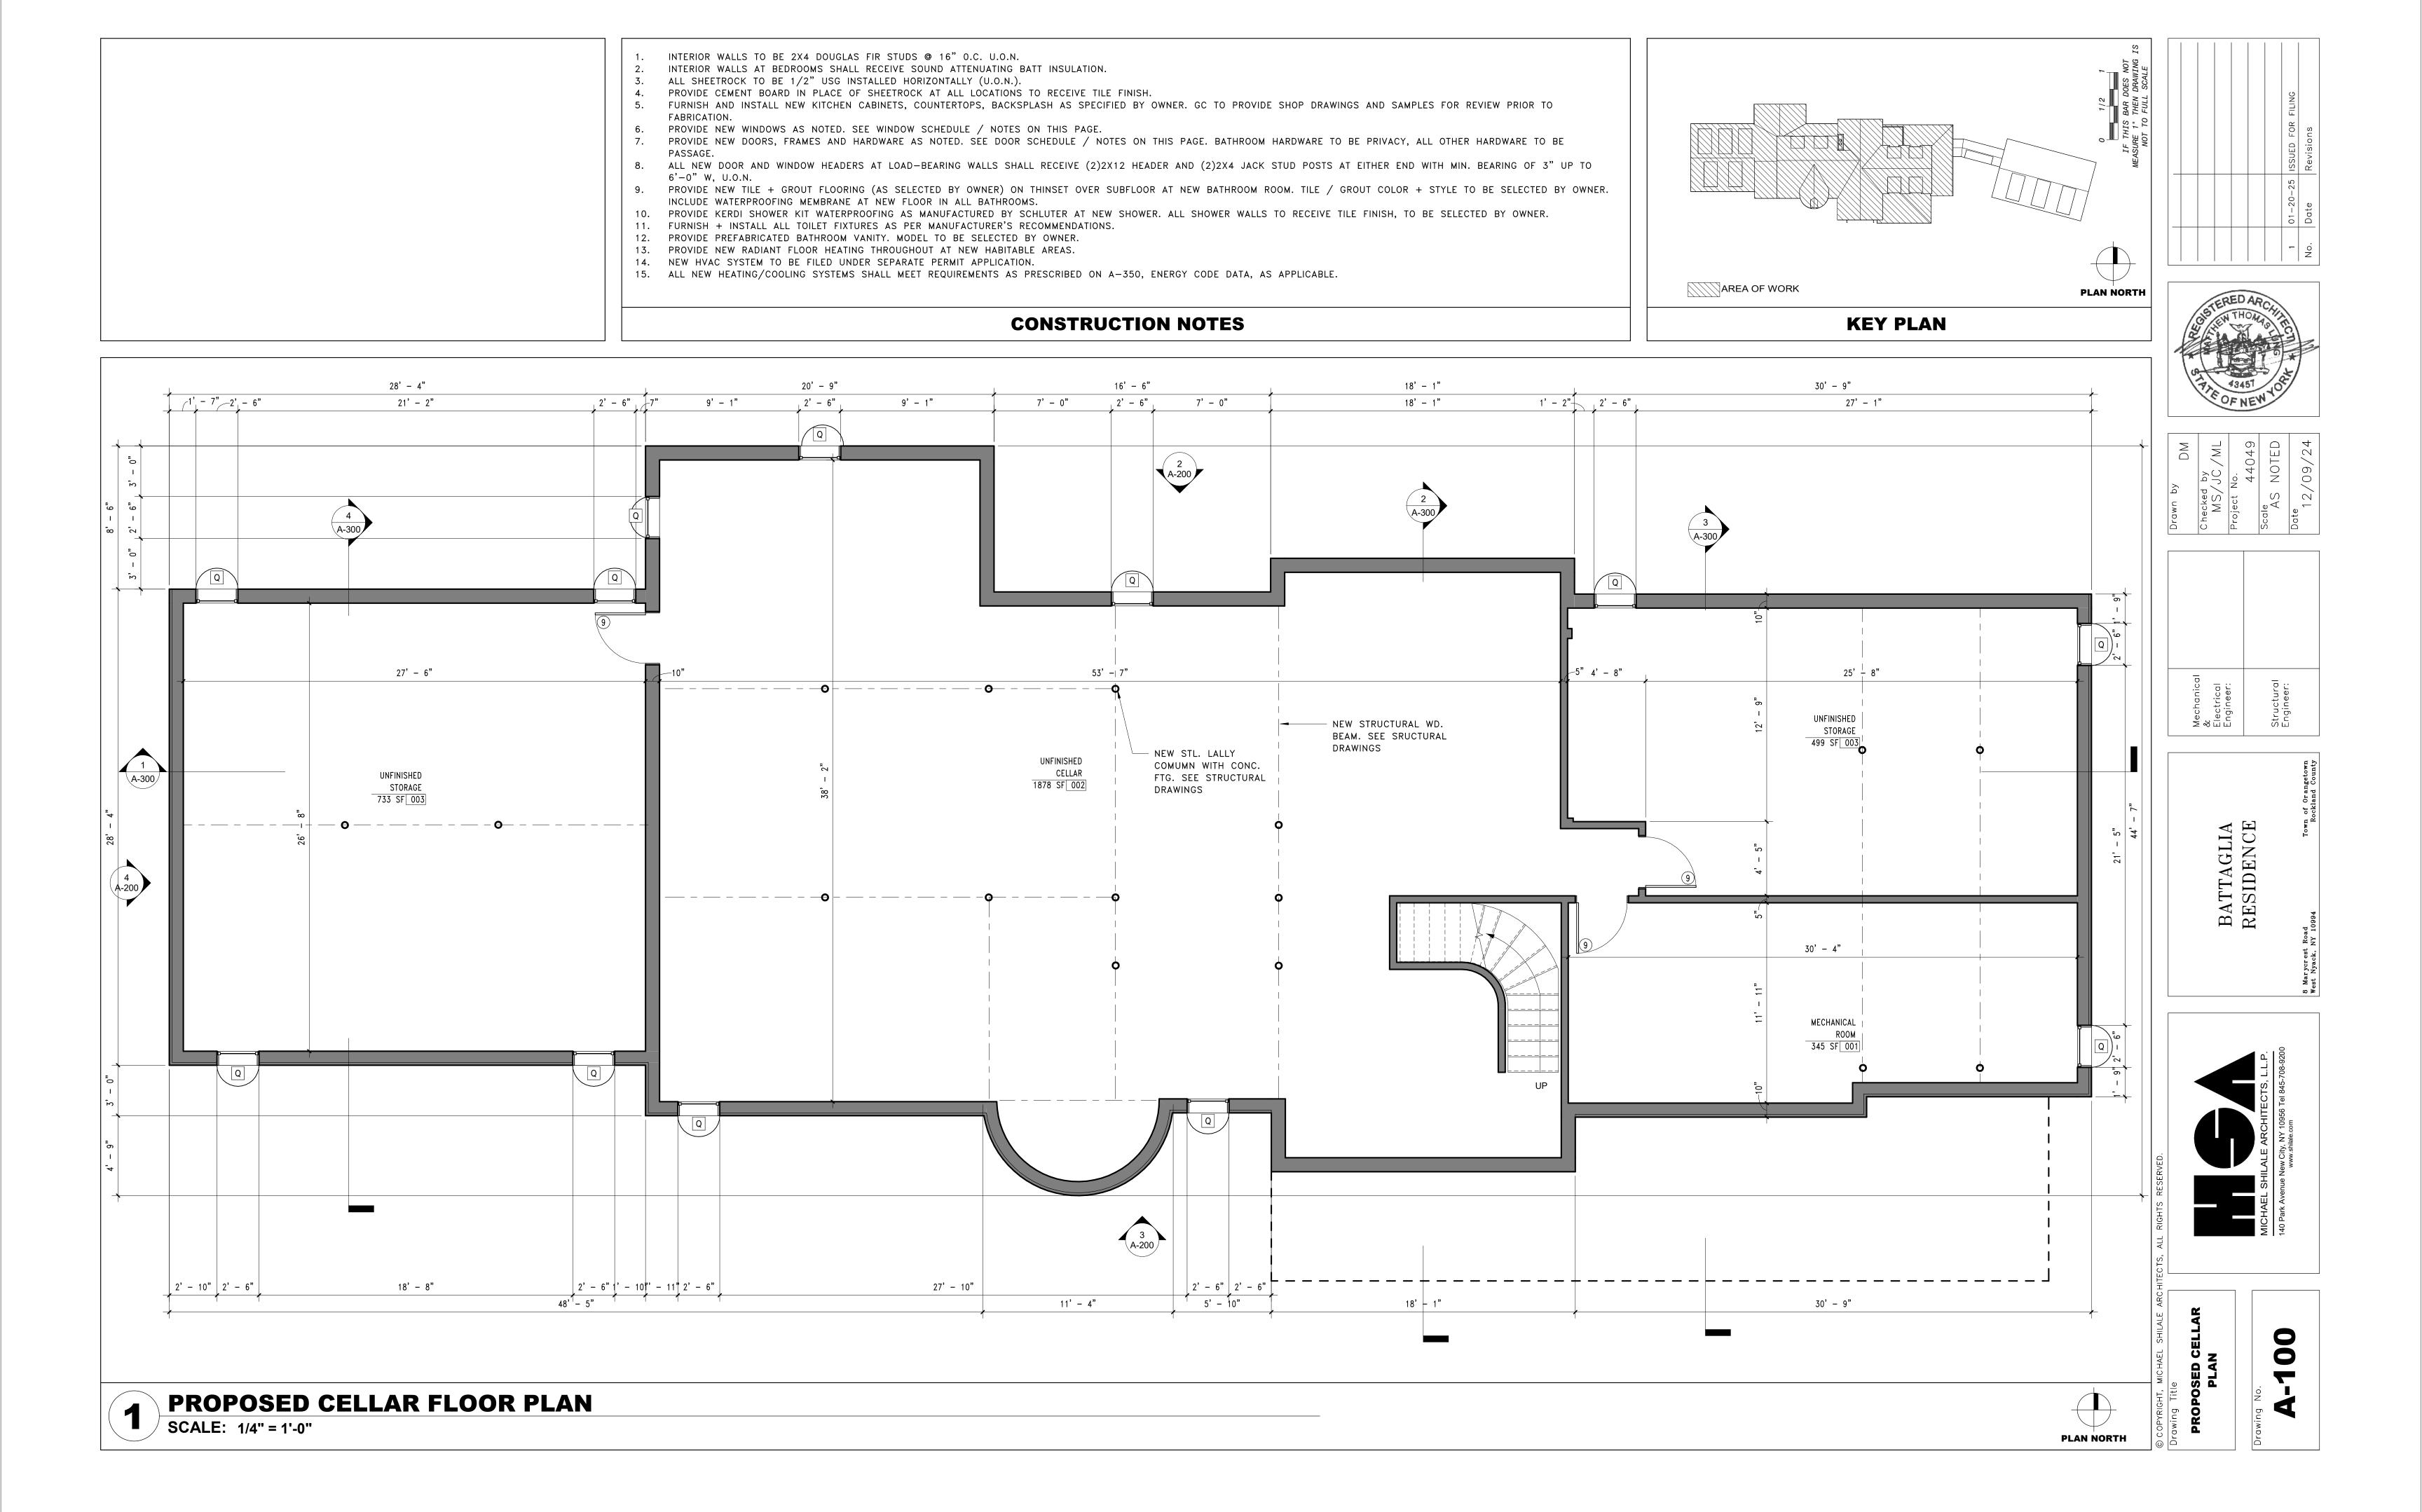


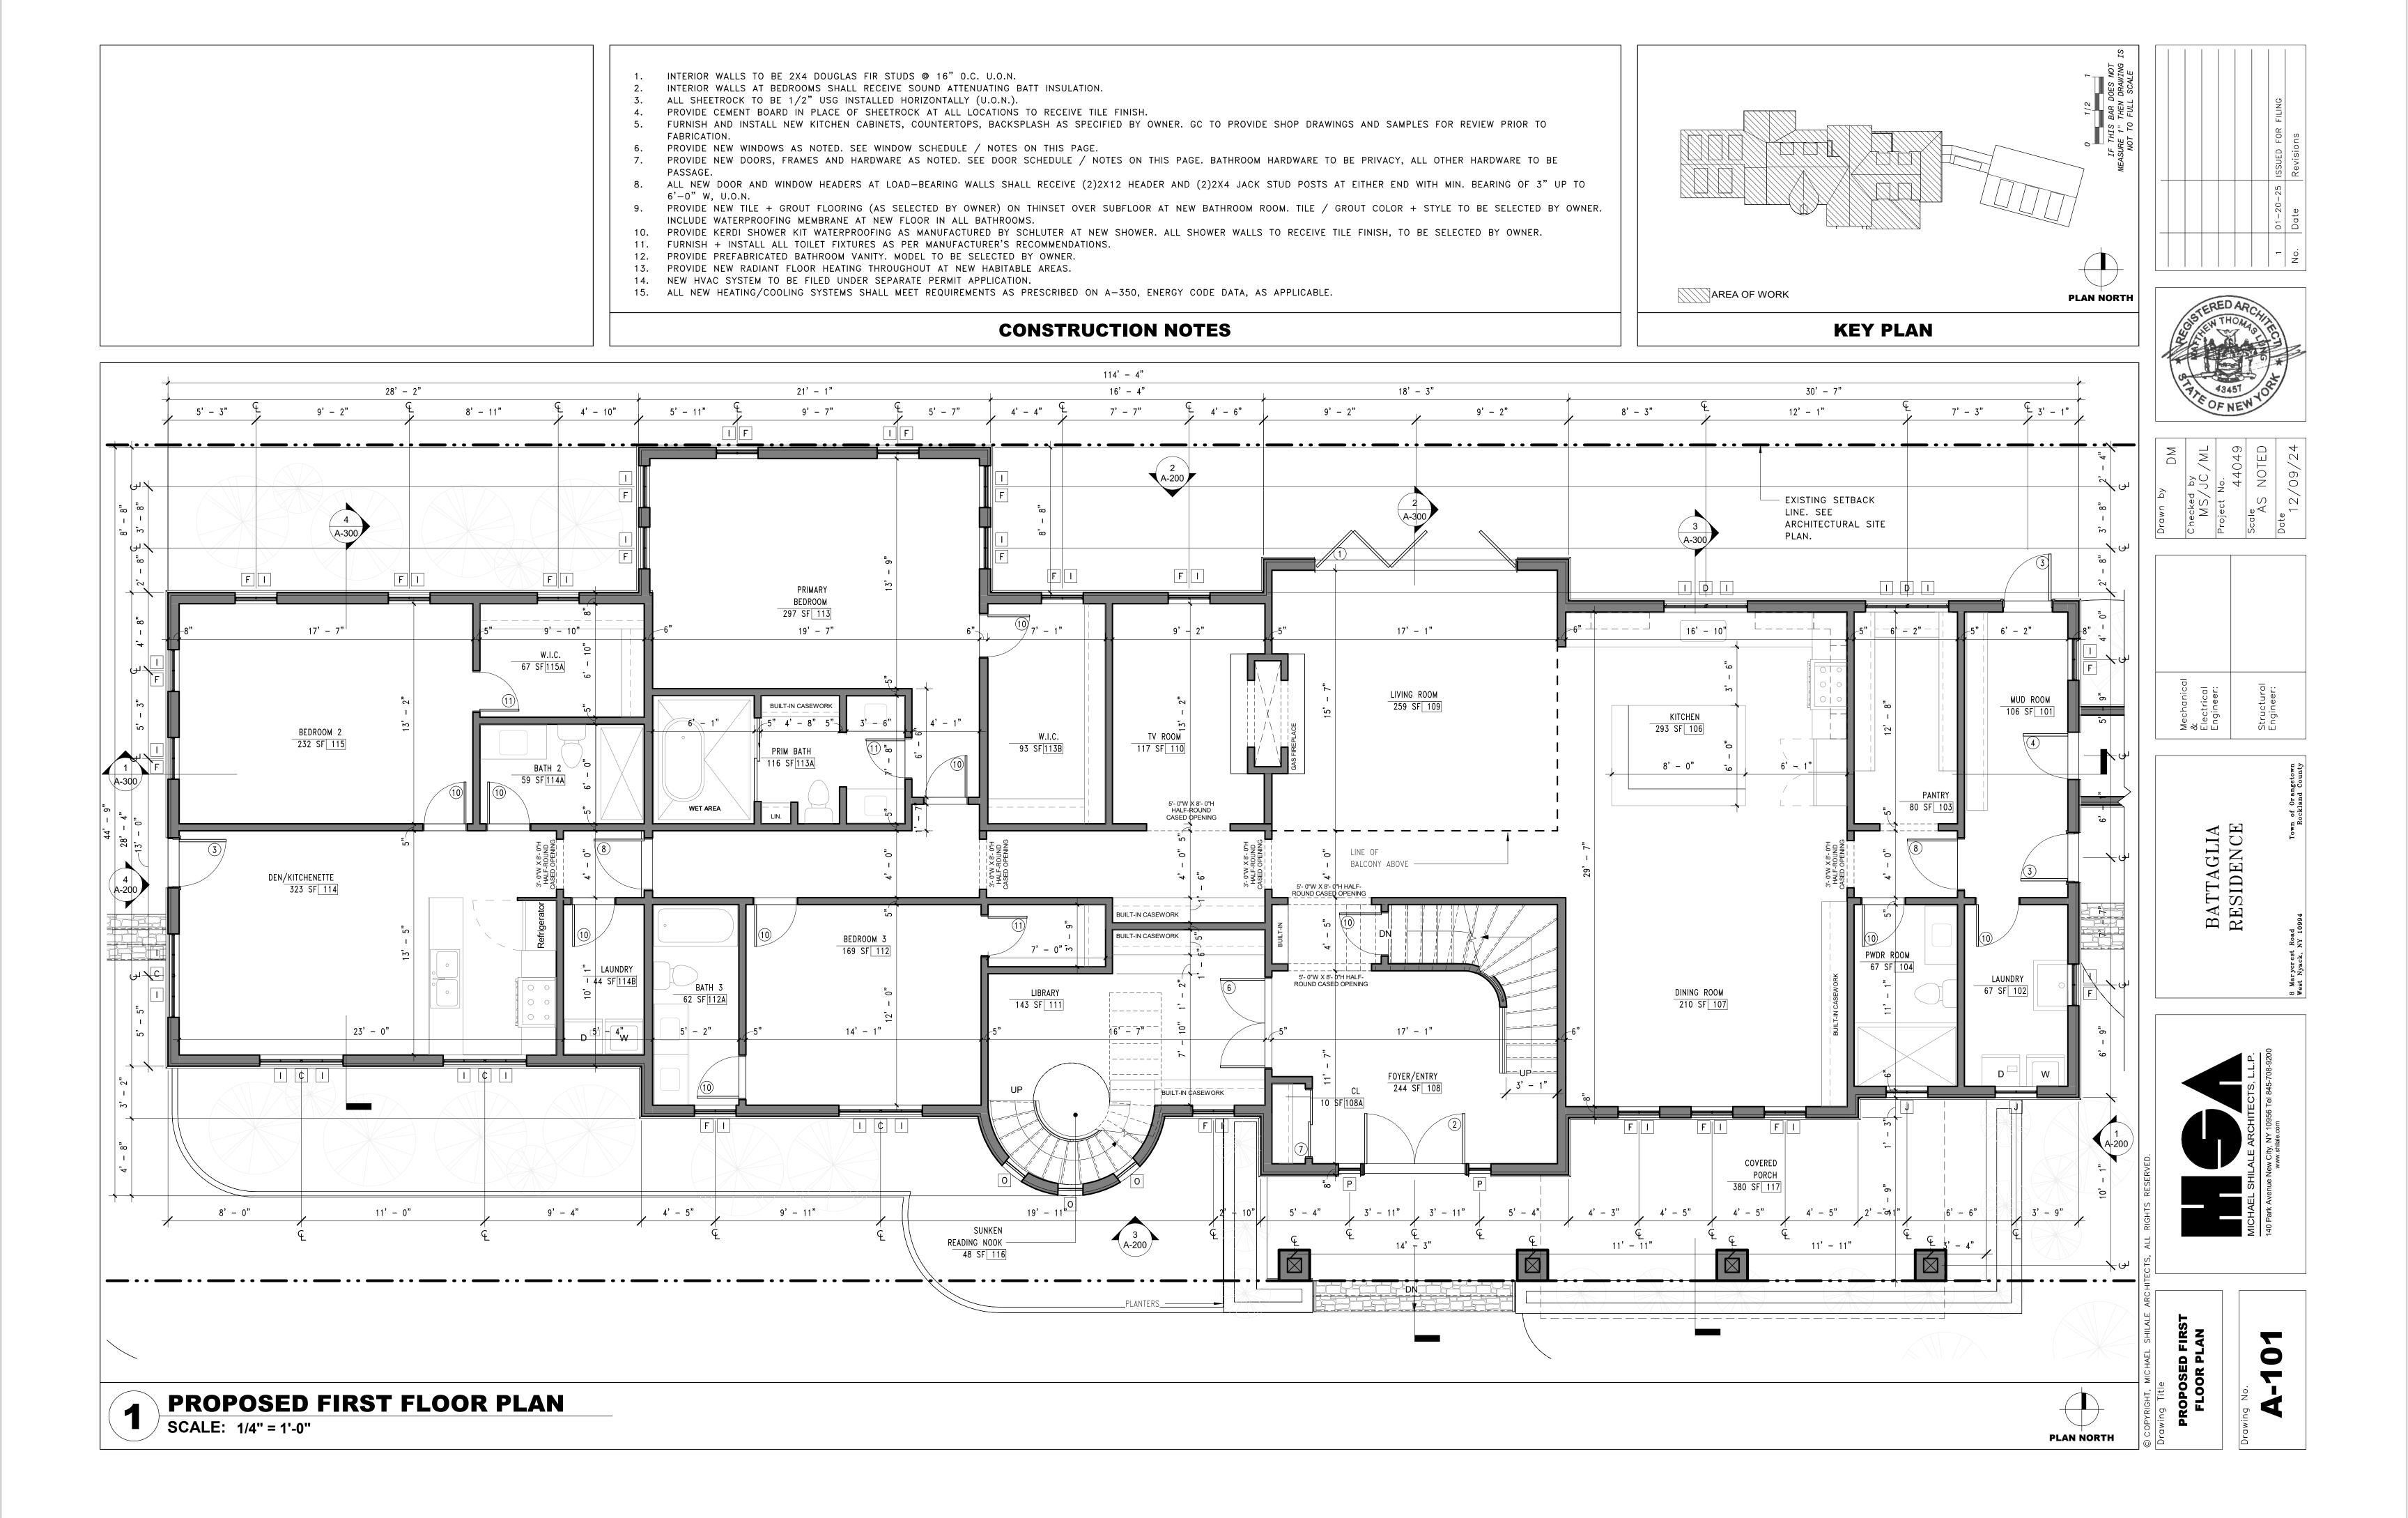

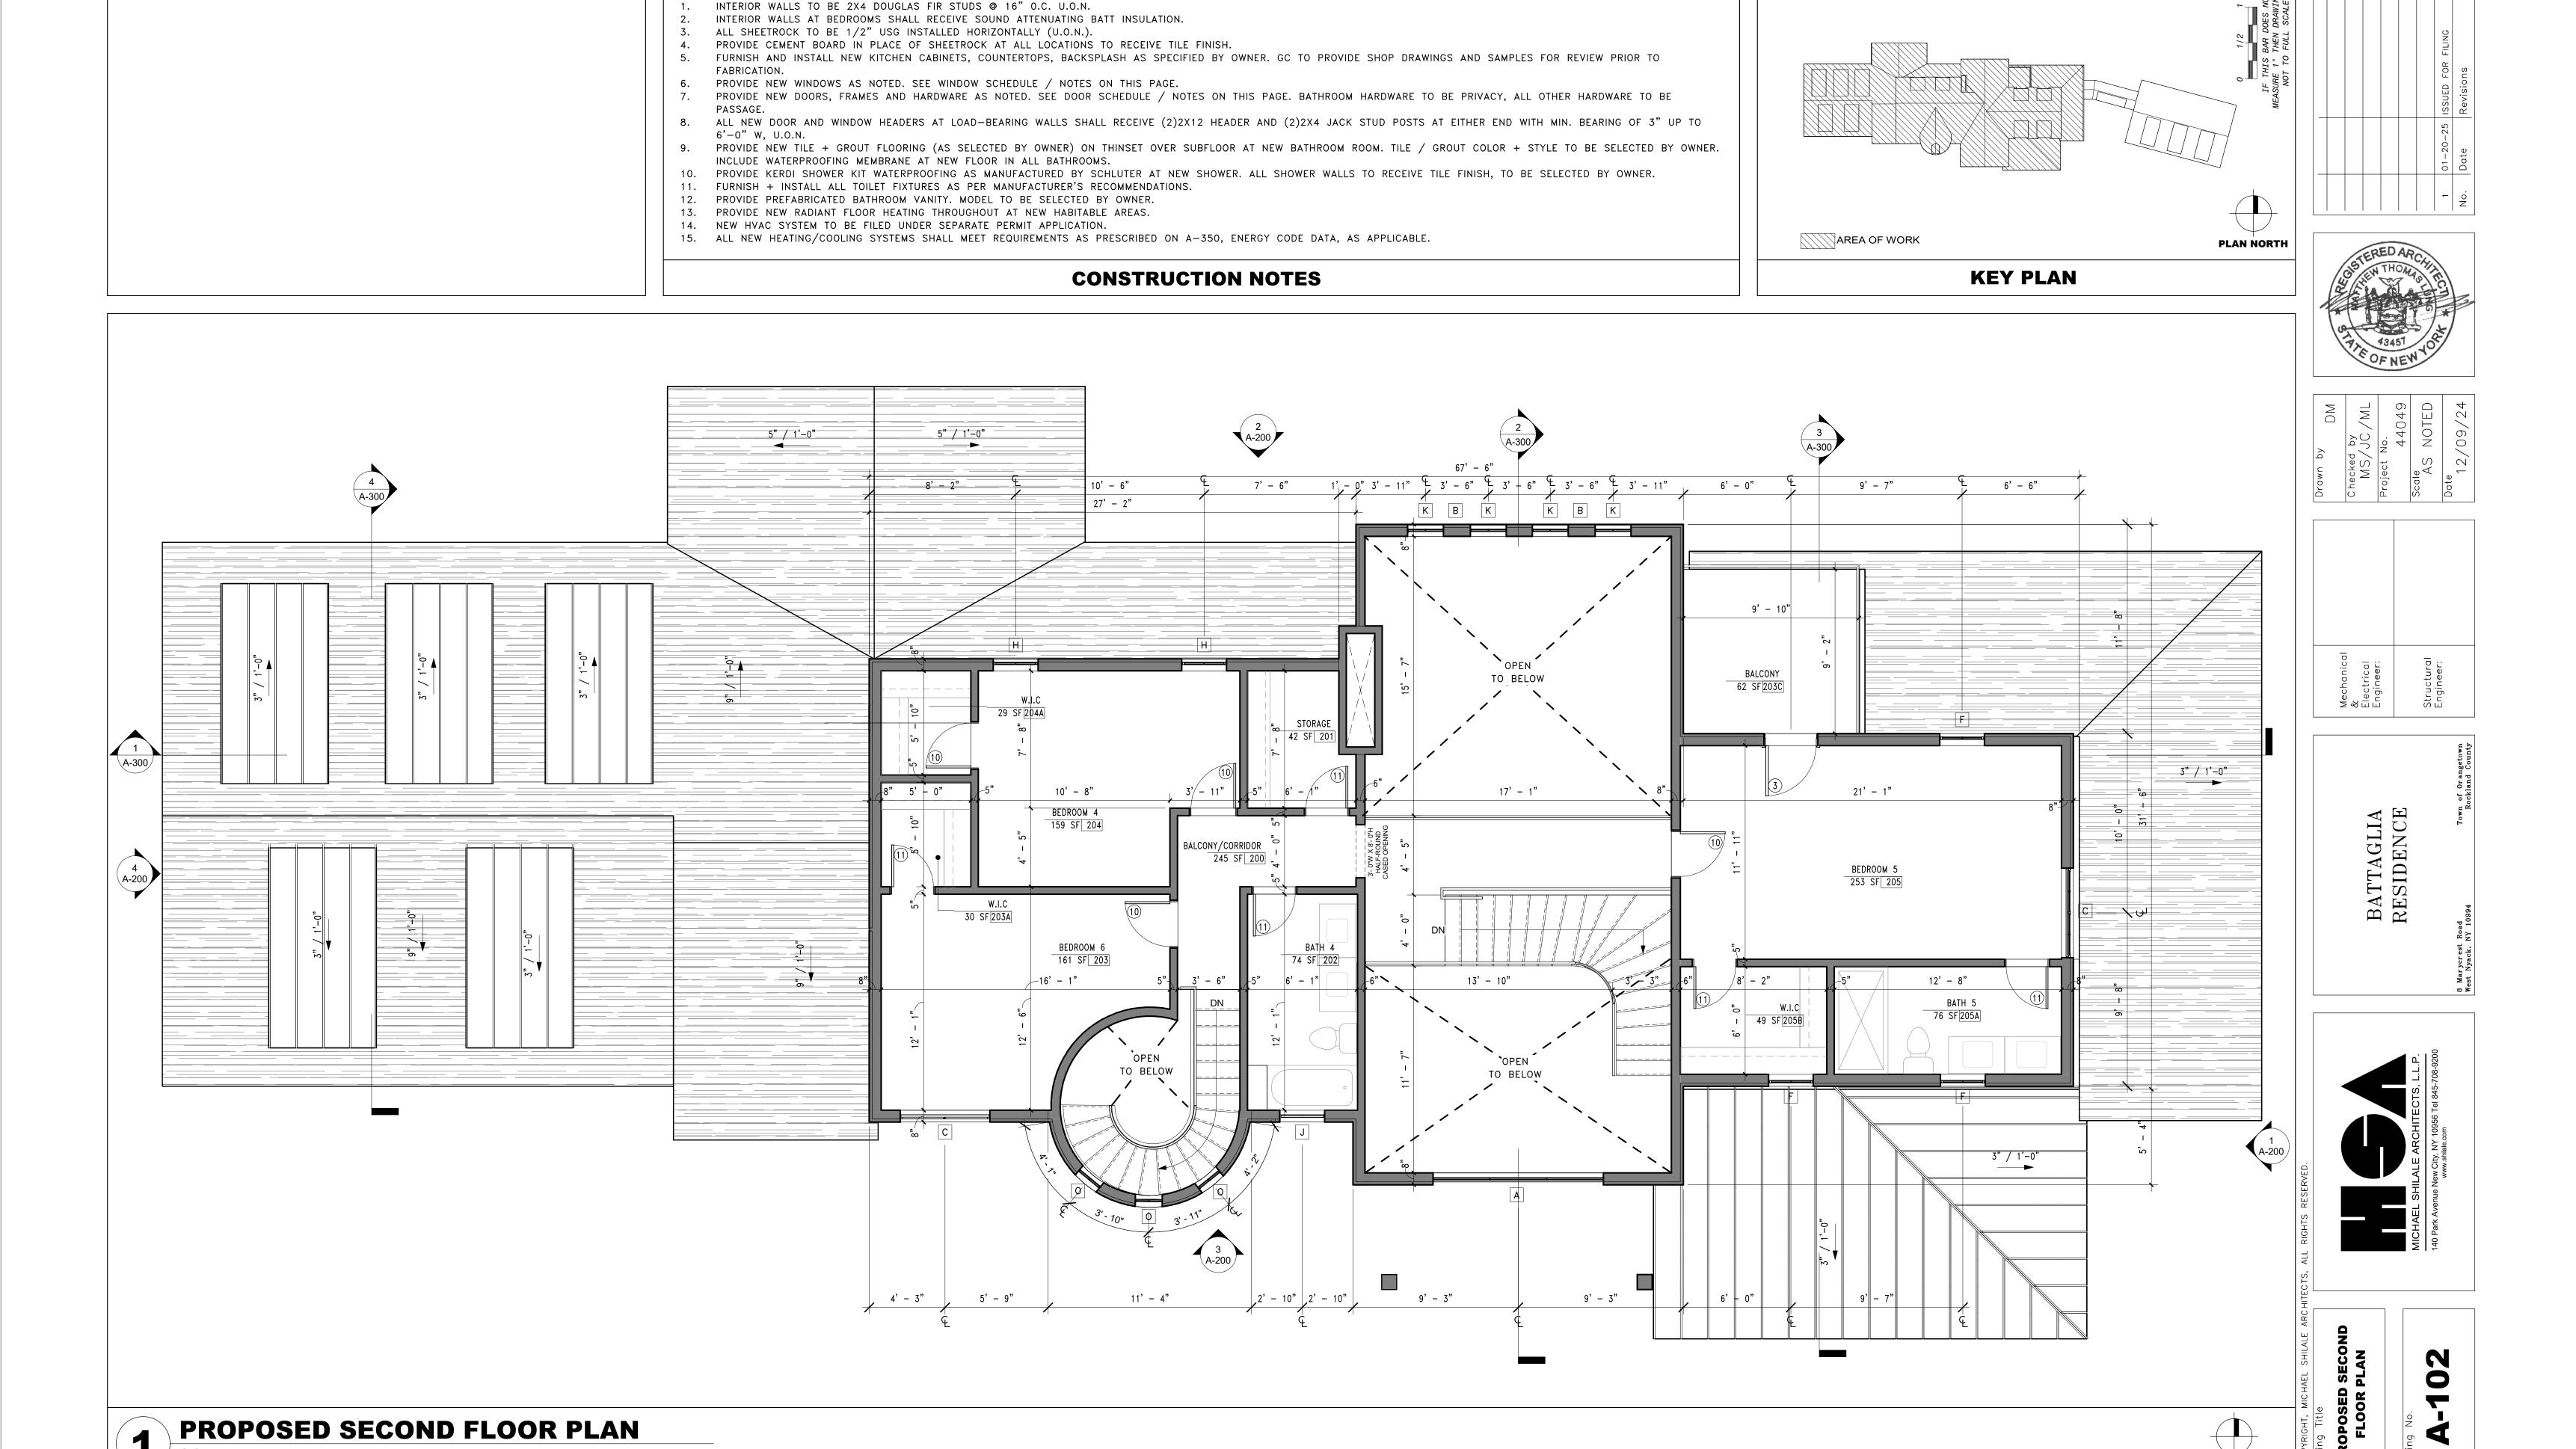


SCALE: 1/4" = 1'-0"

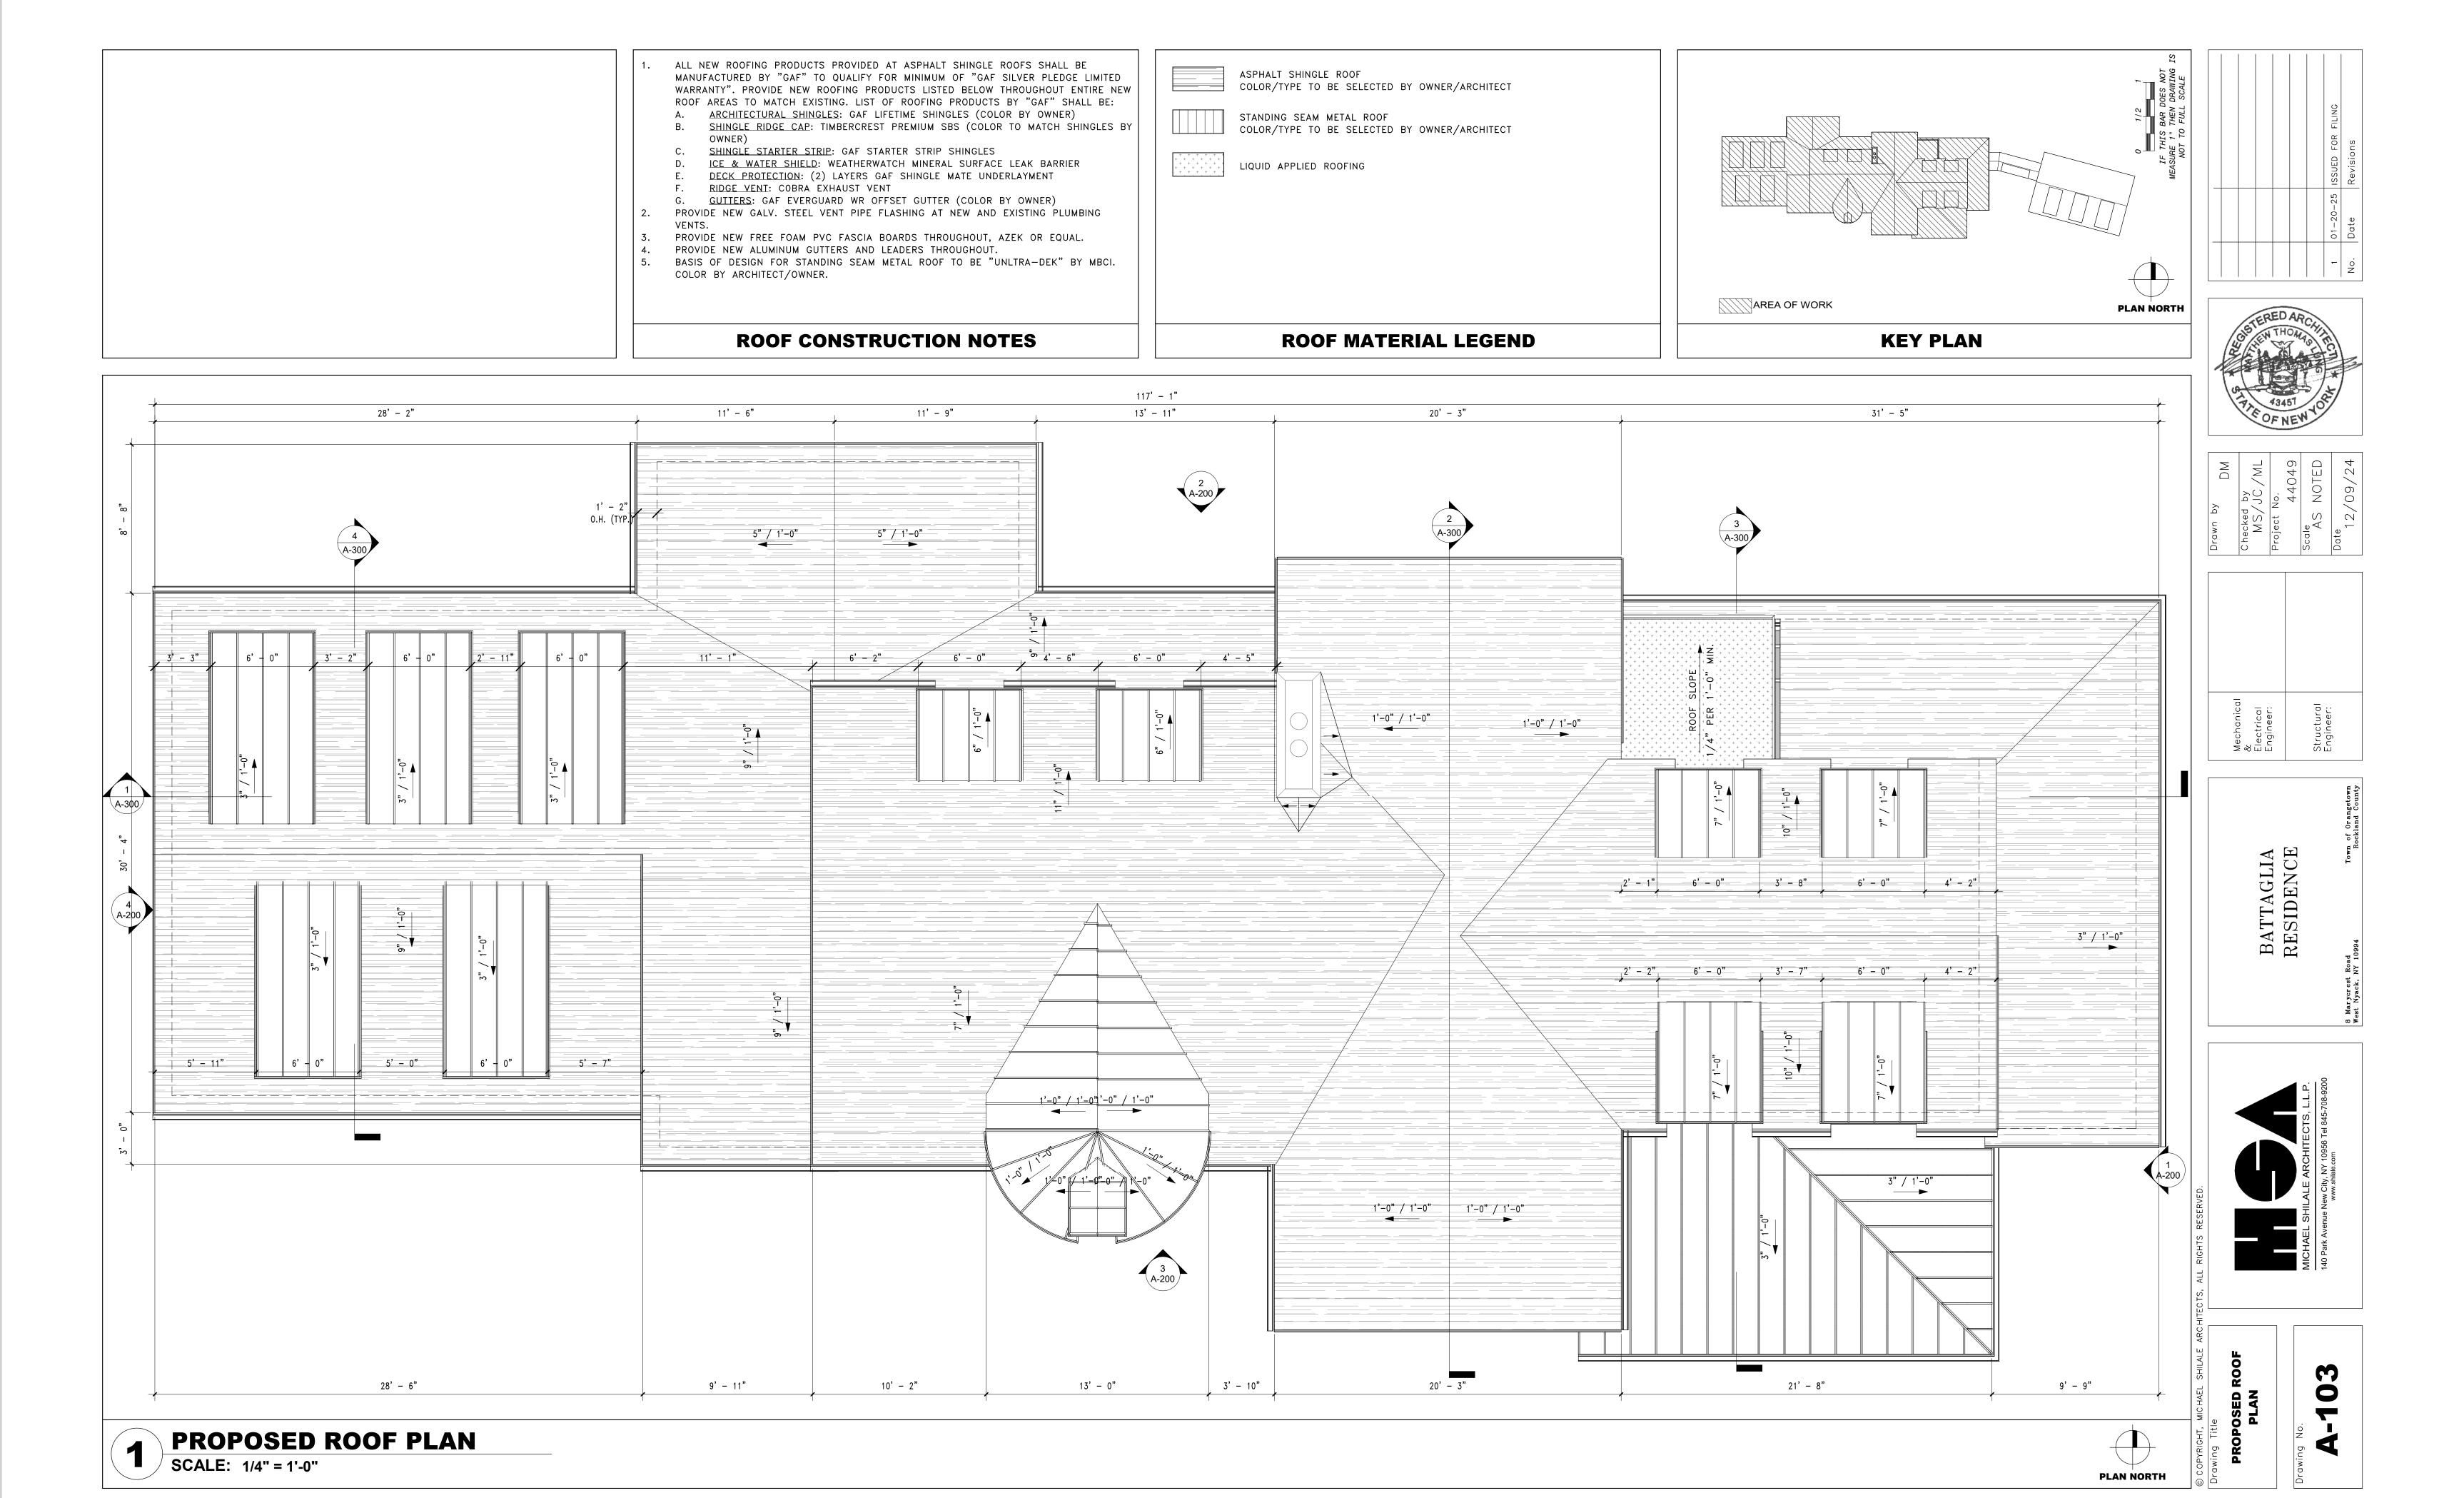


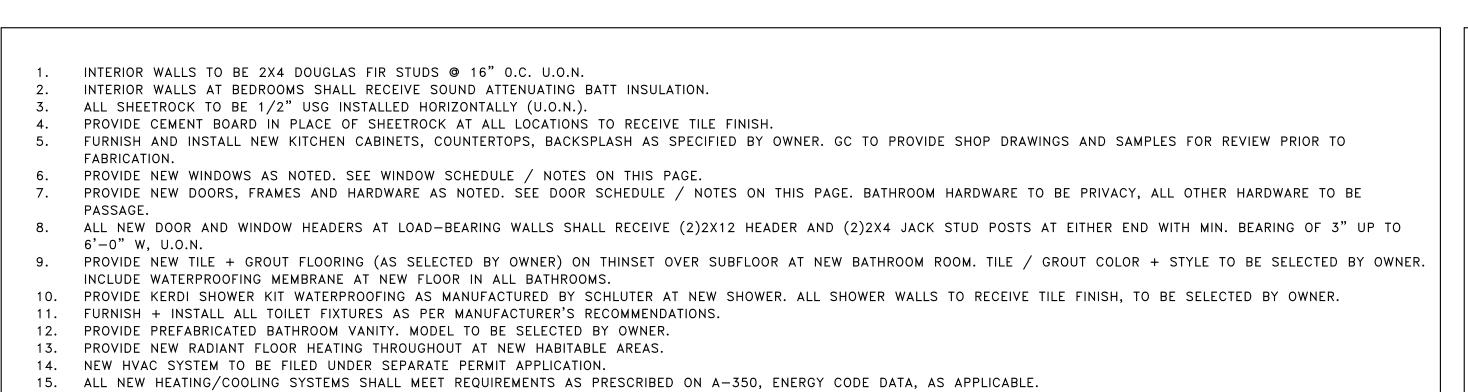


**CONSTRUCTION NOTES** 

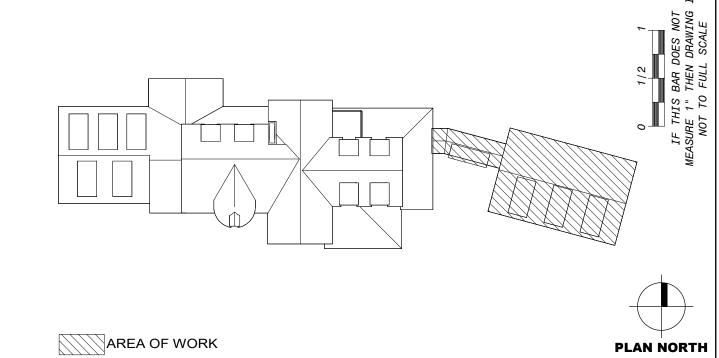


**KEY PLAN** 

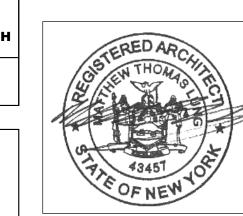

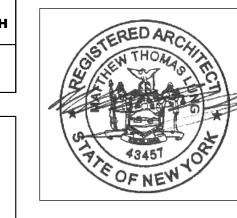


BATTAGLIA RESIDENCE



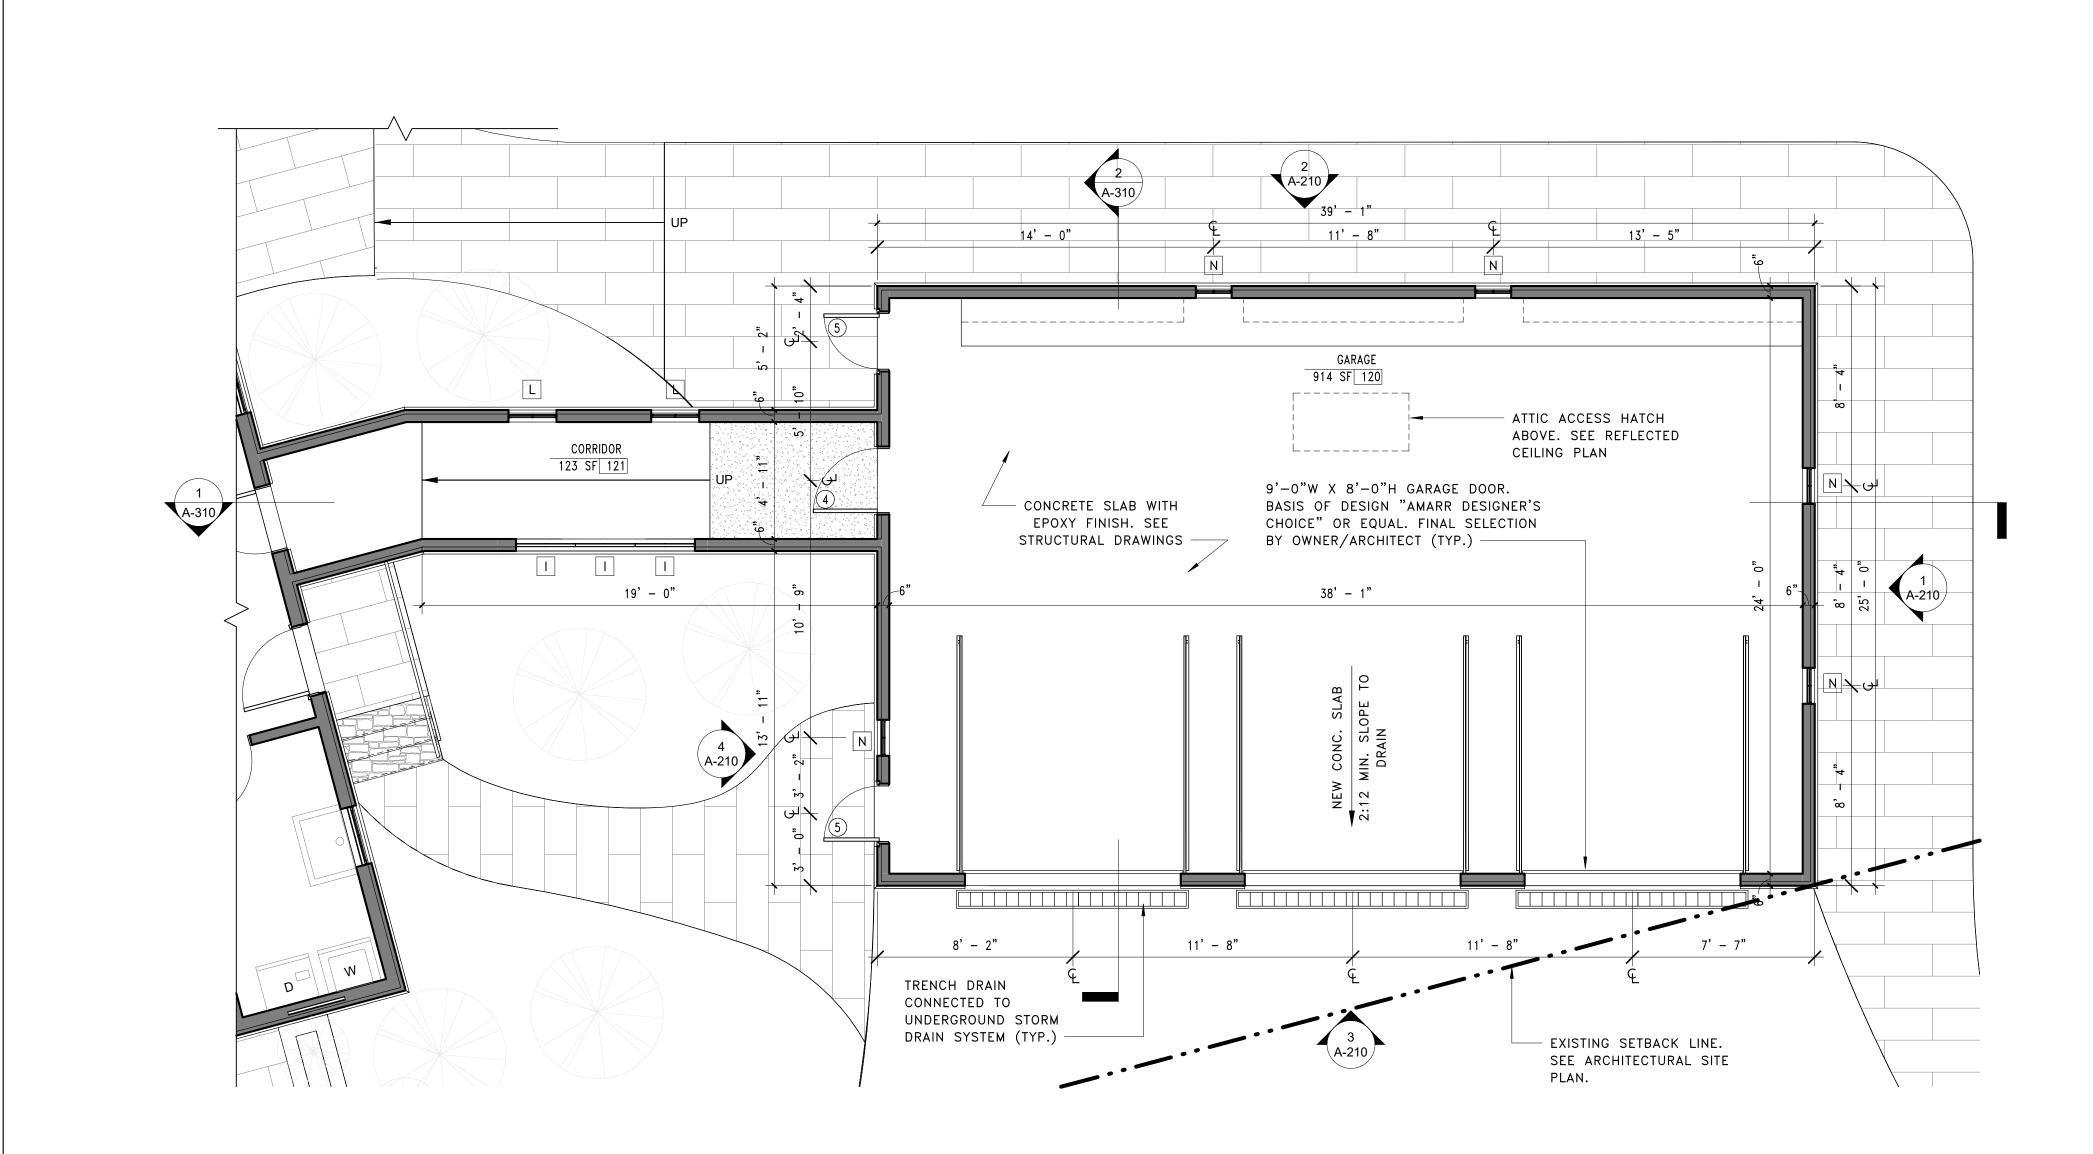




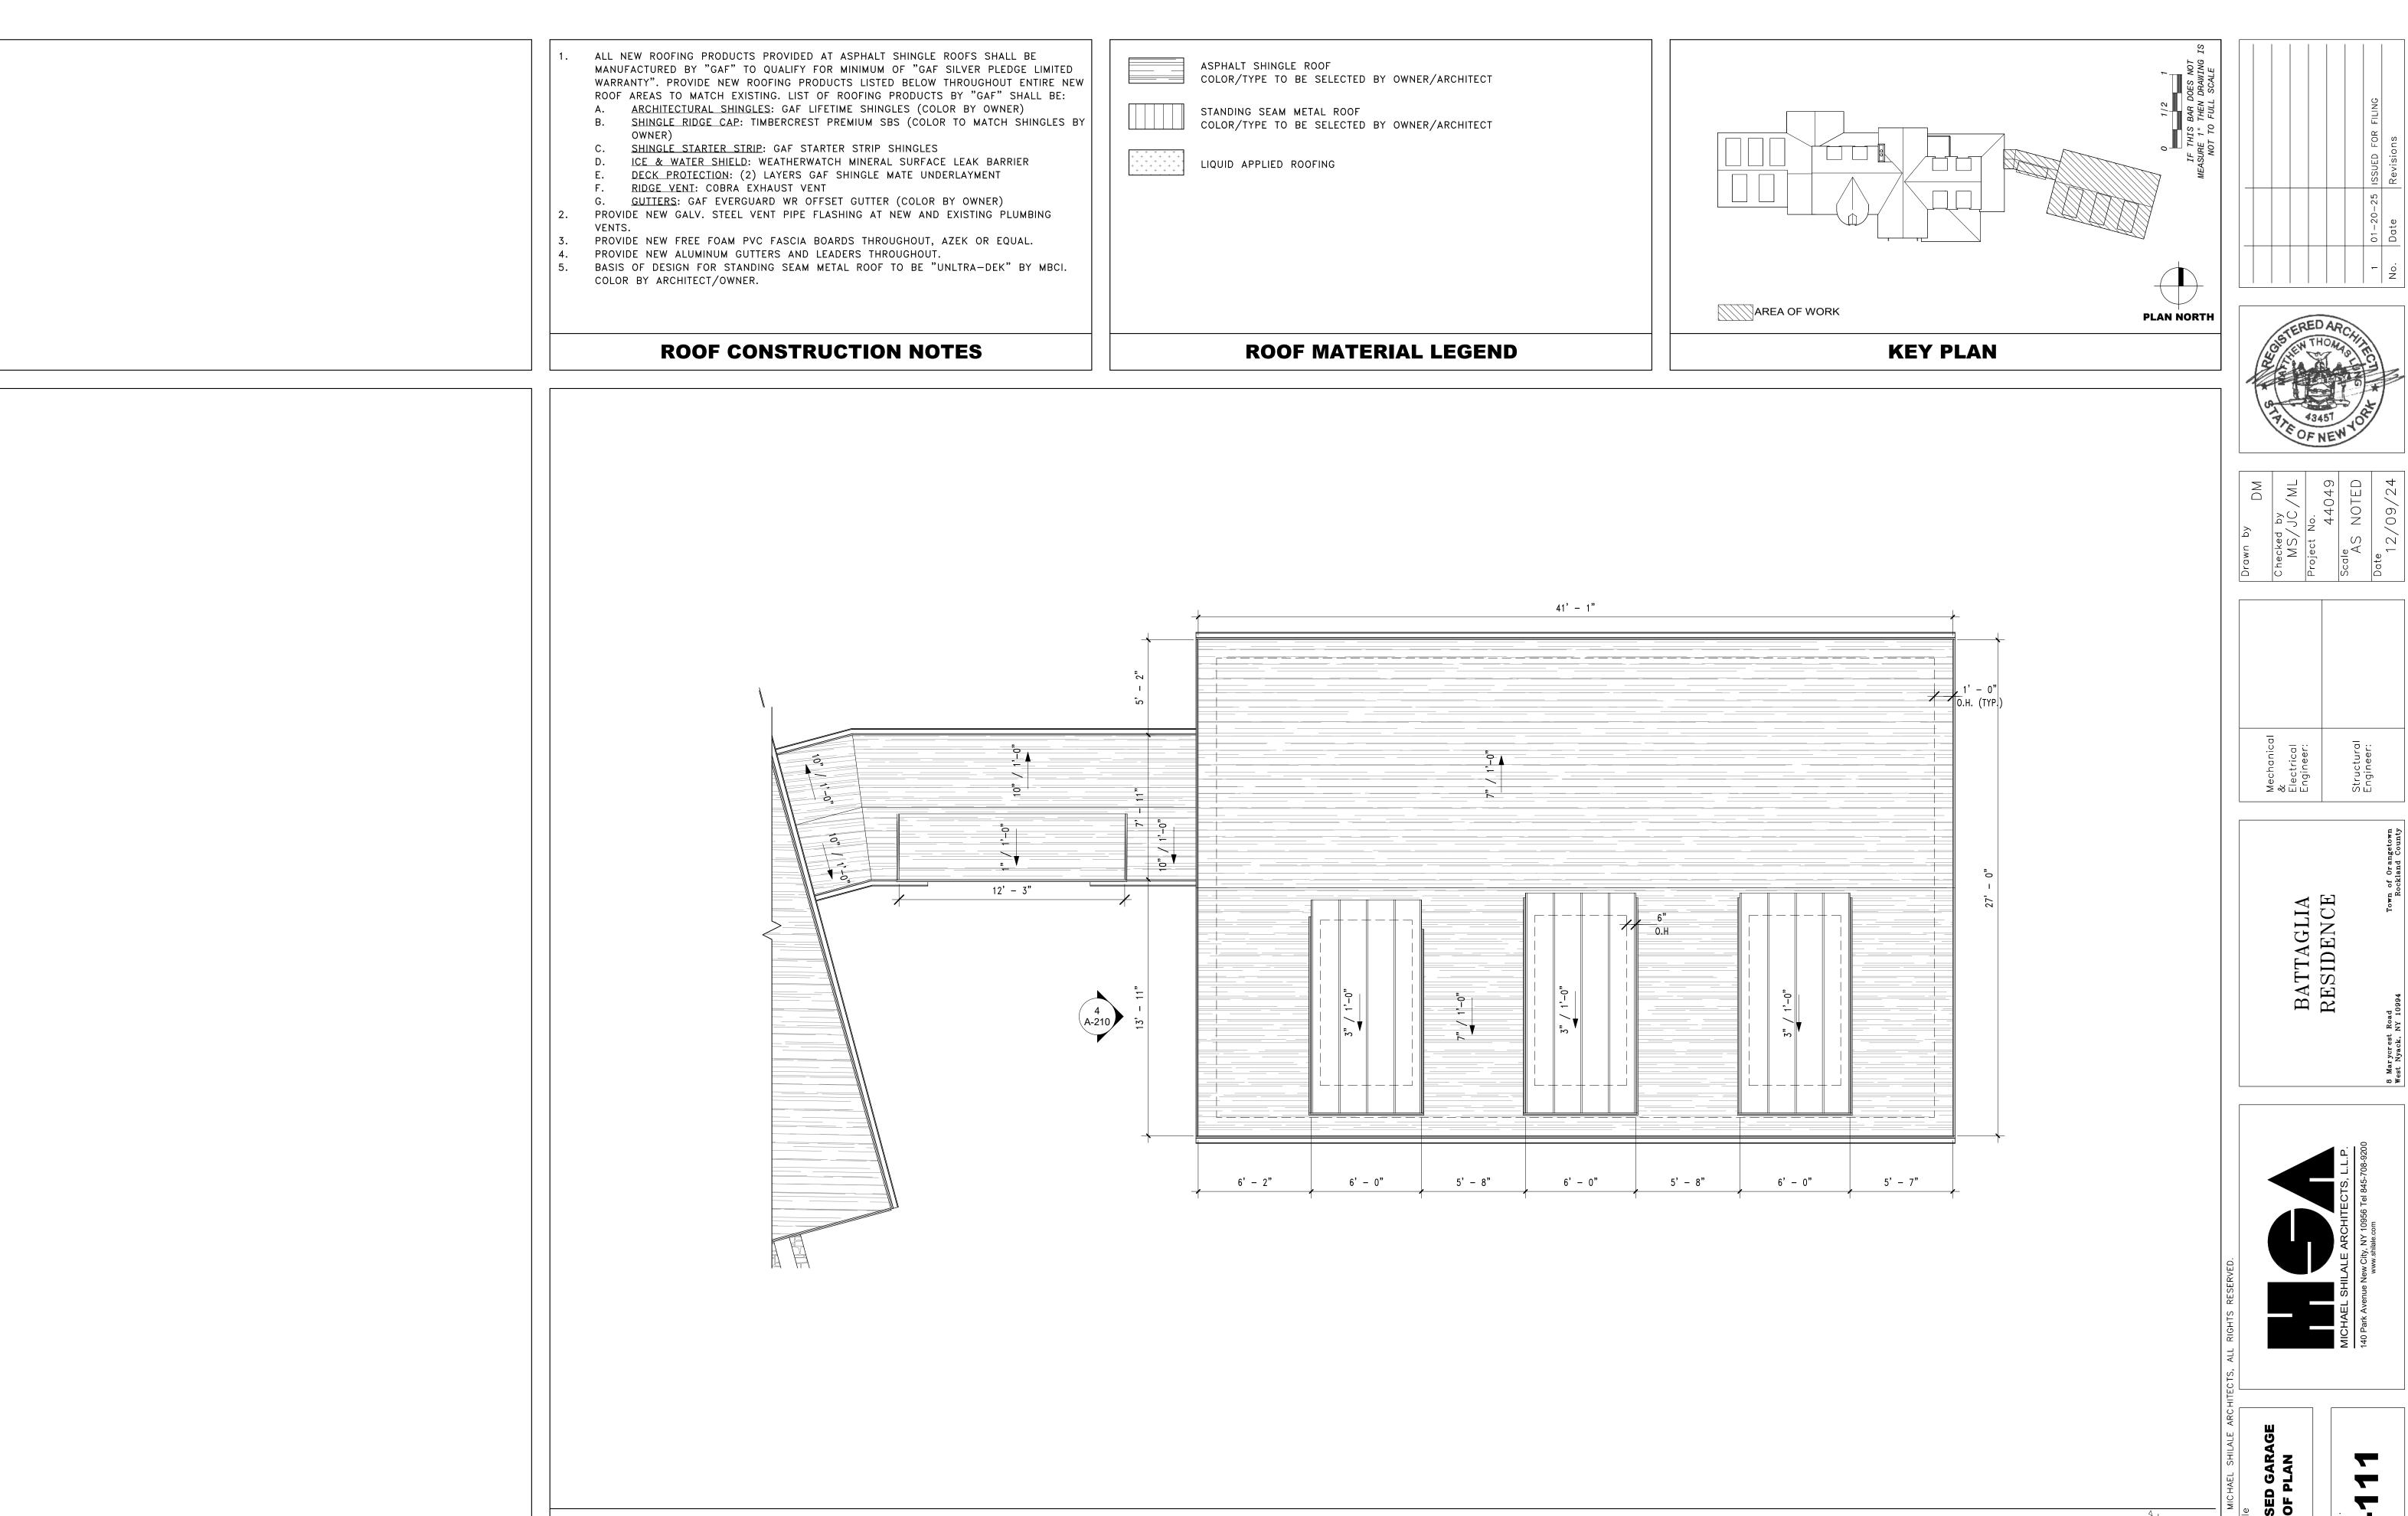



**GARAGE ROOF PLAN** 


SCALE: 1/4" = 1'-0"



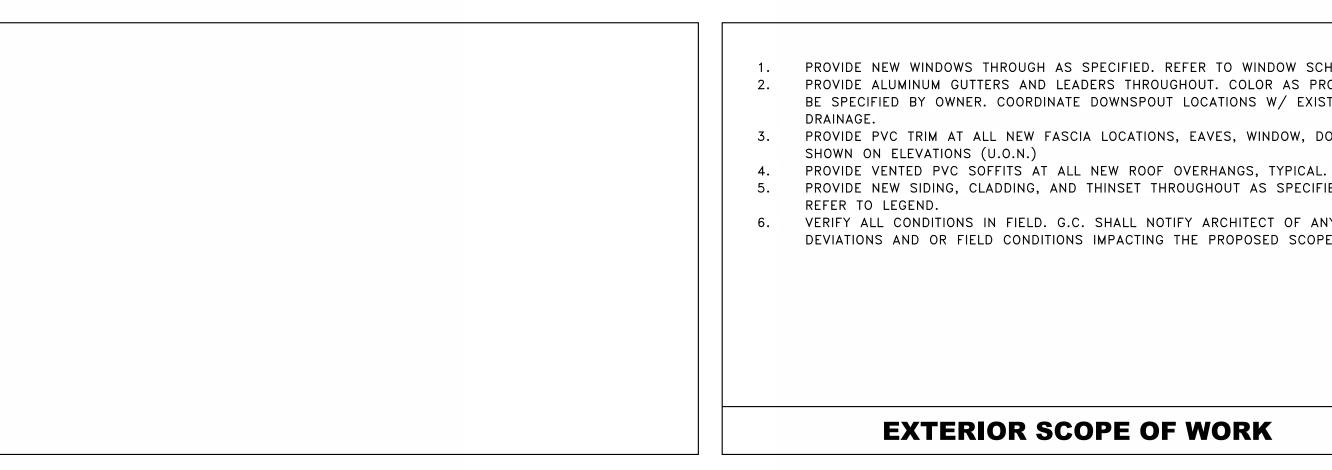

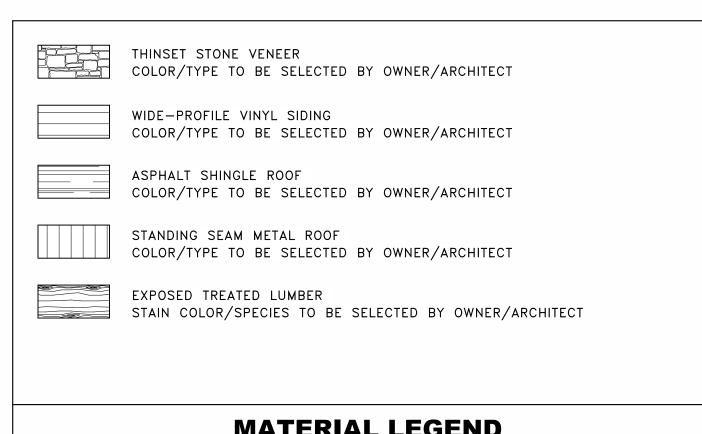

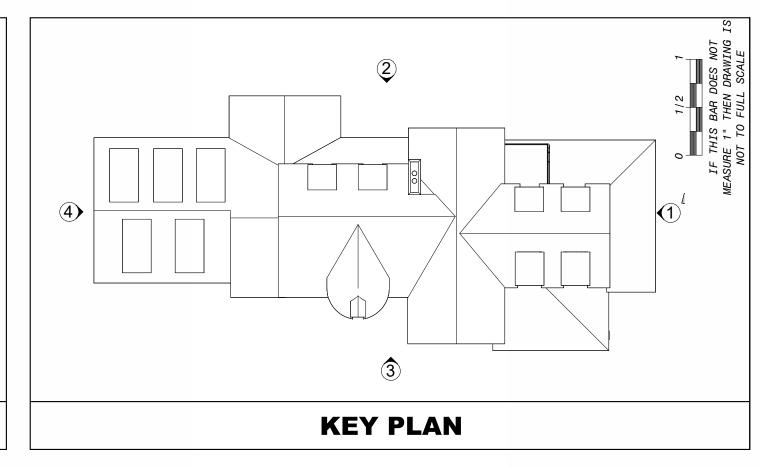

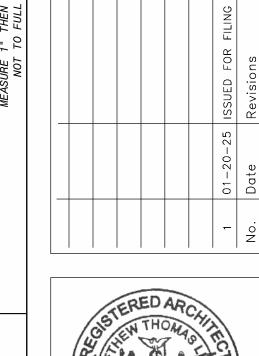



BATTAGLIA RESIDENCE

A-200

PROVIDE NEW WINDOWS THROUGH AS SPECIFIED. REFER TO WINDOW SCHEDULE. PROVIDE ALUMINUM GUTTERS AND LEADERS THROUGHOUT. COLOR AS PROFILE TO BE SPECIFIED BY OWNER. COORDINATE DOWNSPOUT LOCATIONS W/ EXISTING SITE


PROVIDE PVC TRIM AT ALL NEW FASCIA LOCATIONS, EAVES, WINDOW, DOORS AS

PROVIDE NEW SIDING, CLADDING, AND THINSET THROUGHOUT AS SPECIFIED HEREIN.

VERIFY ALL CONDITIONS IN FIELD. G.C. SHALL NOTIFY ARCHITECT OF ANY

DEVIATIONS AND OR FIELD CONDITIONS IMPACTING THE PROPOSED SCOPE OF WORK.

**MATERIAL LEGEND** 

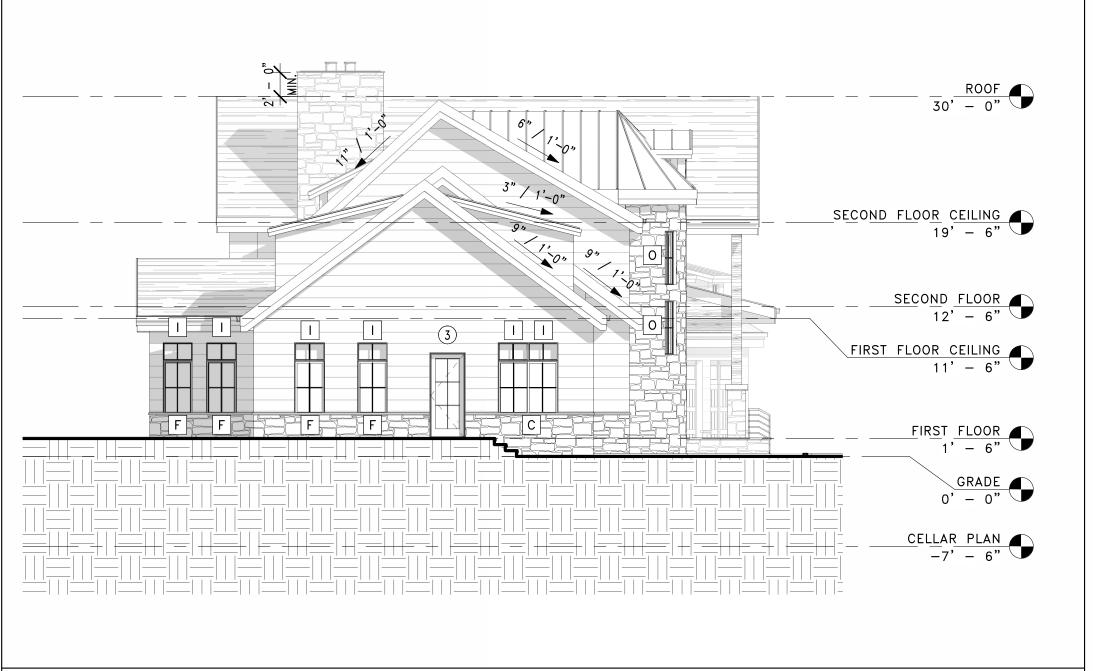






SCALE: 1/8" = 1'-0"







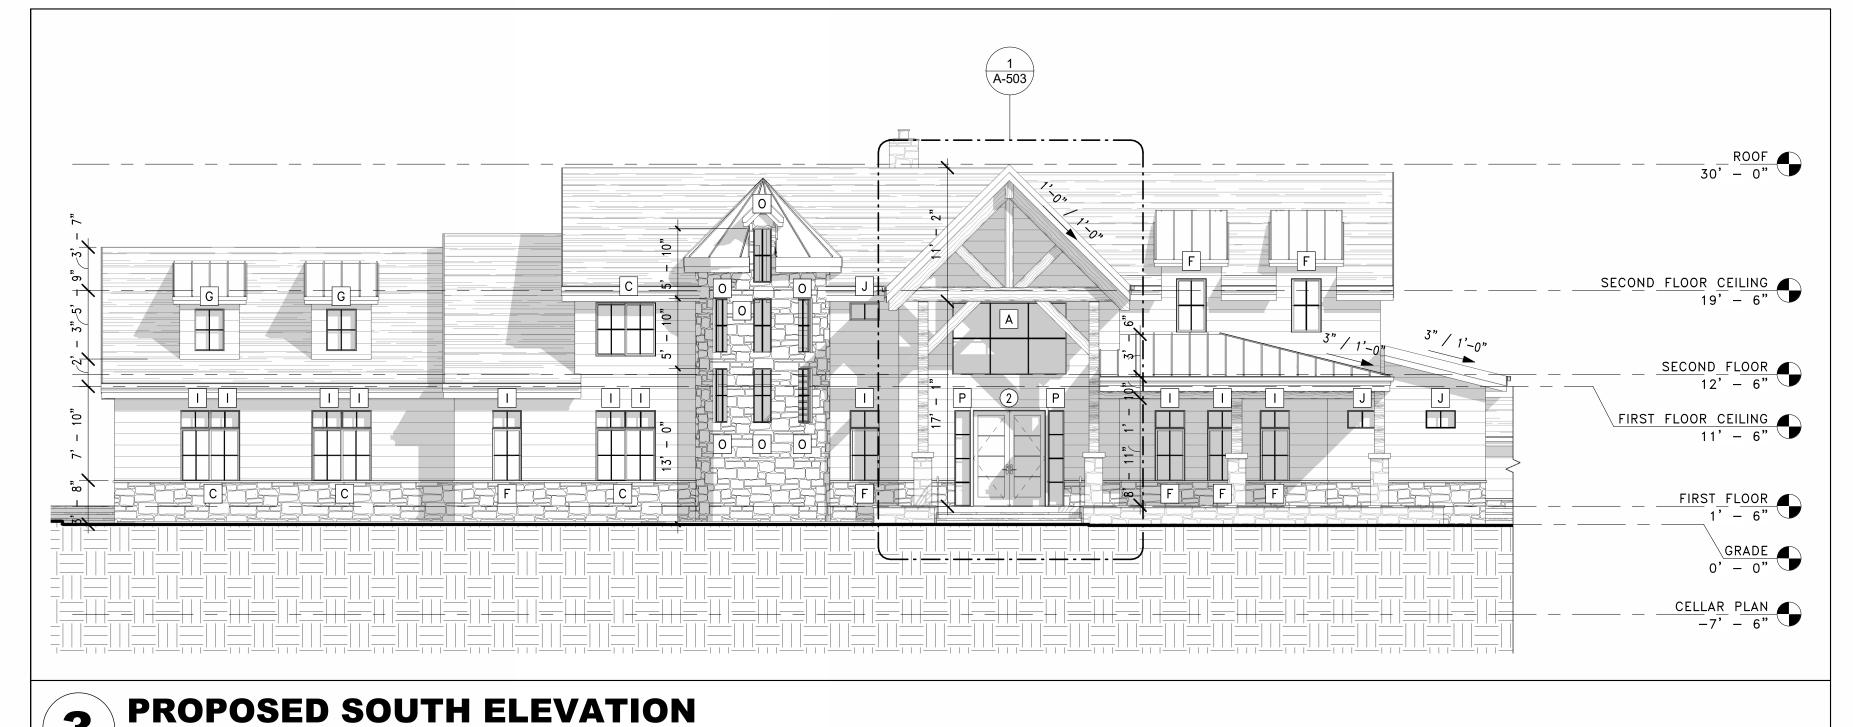

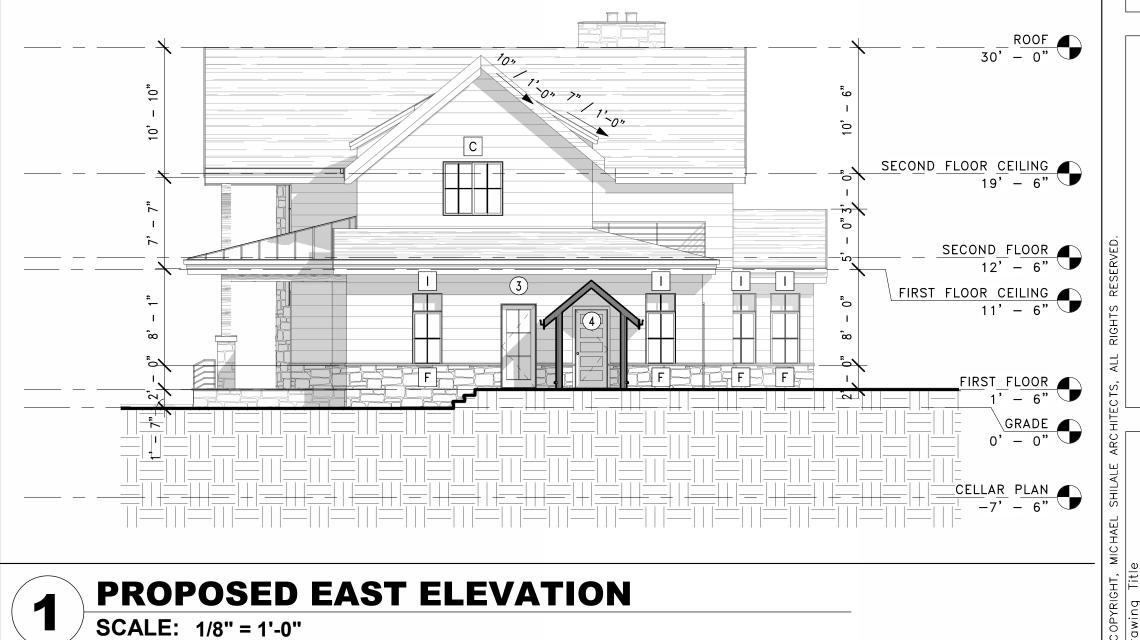

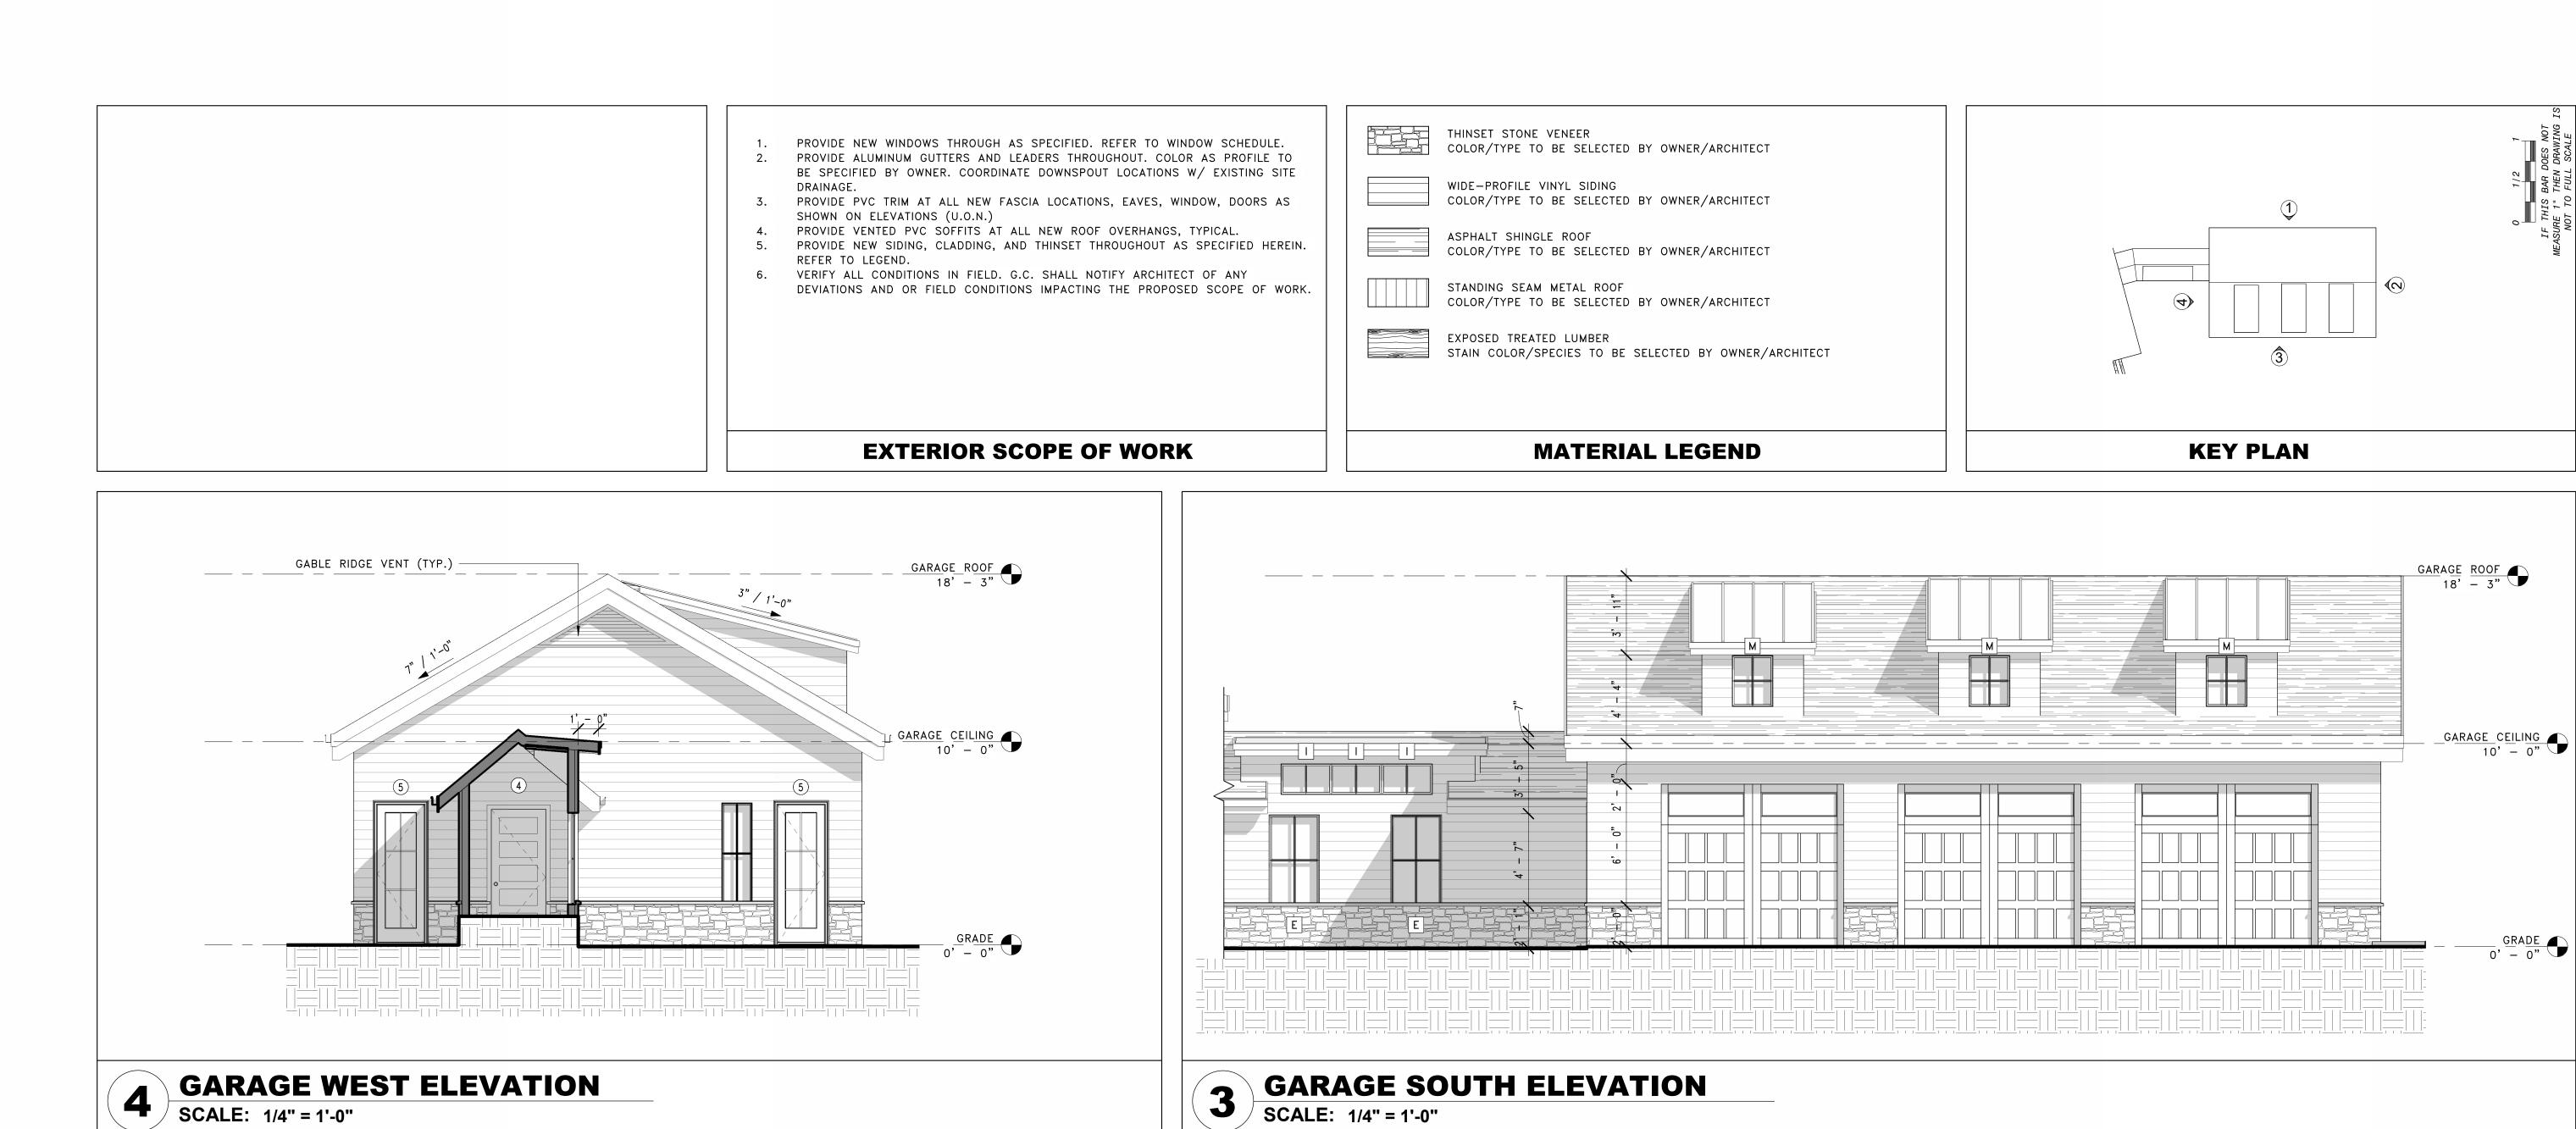

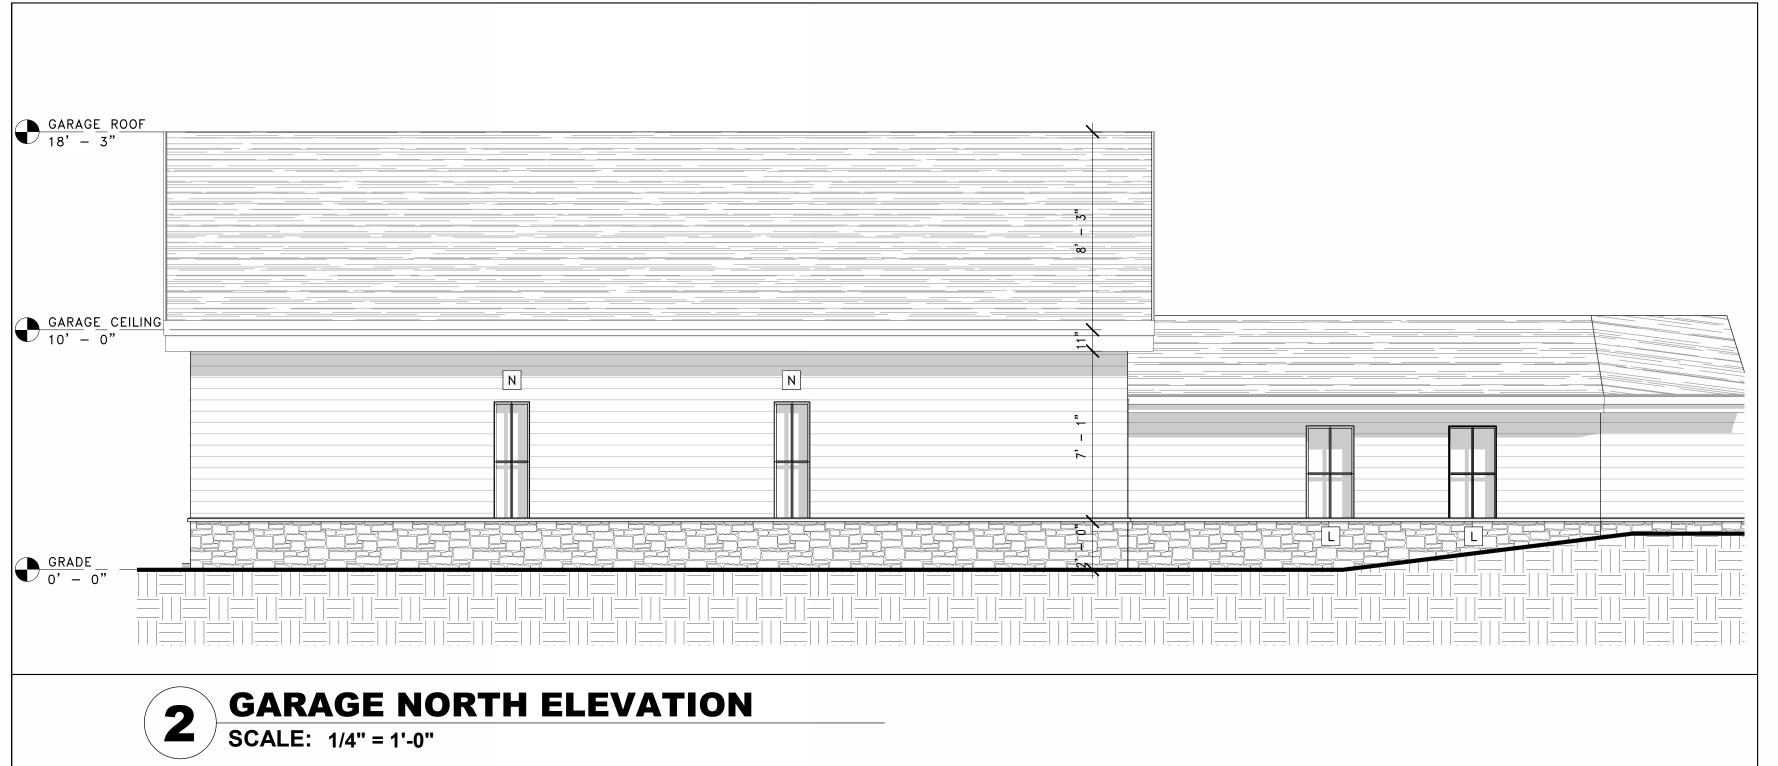

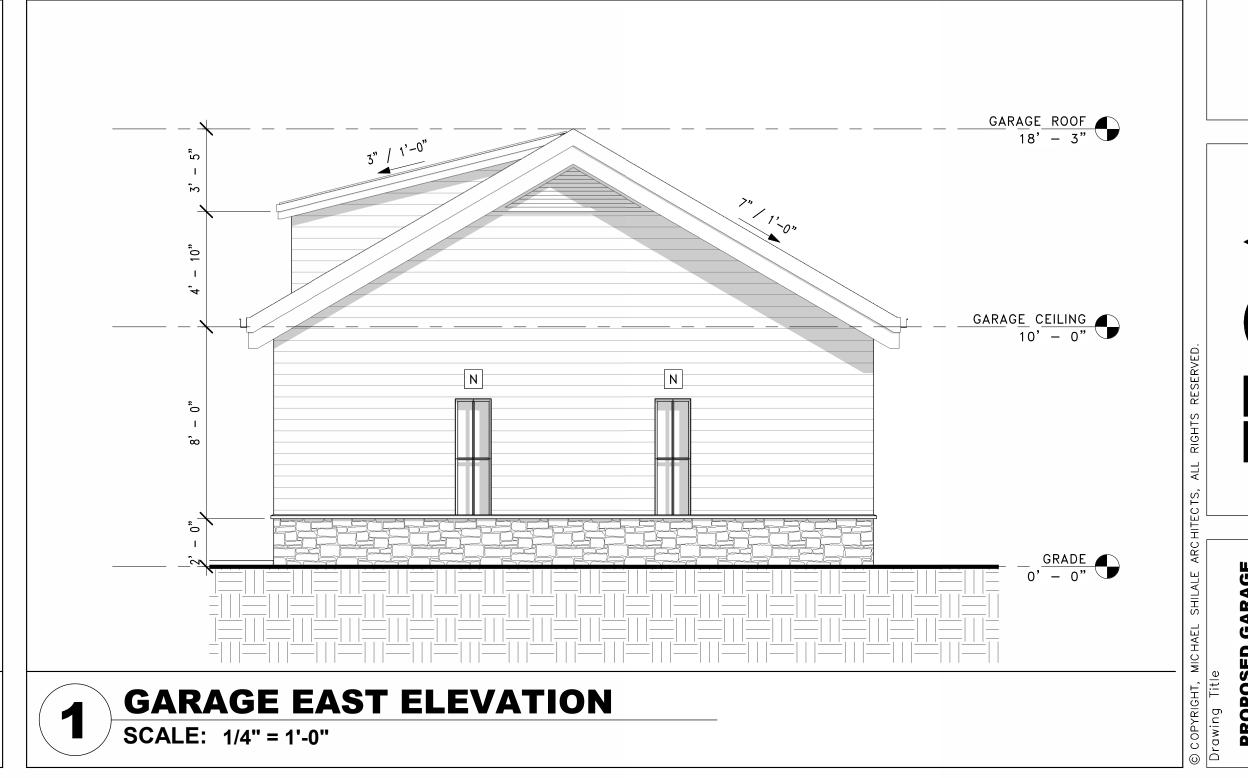

BATTAGLIA RESIDENCE

A-210




SOUTH-WEST AXONOMETRIC VIEW
SCALE:




NORTH-WEST AXONOMETRIC VIEW SCALE:





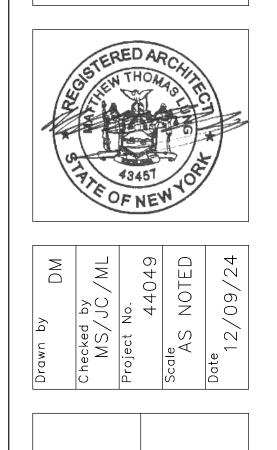


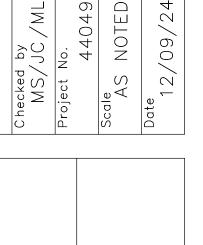

SOUTHWEST PERSPECTIVE VIEW
SCALE: N.T.S





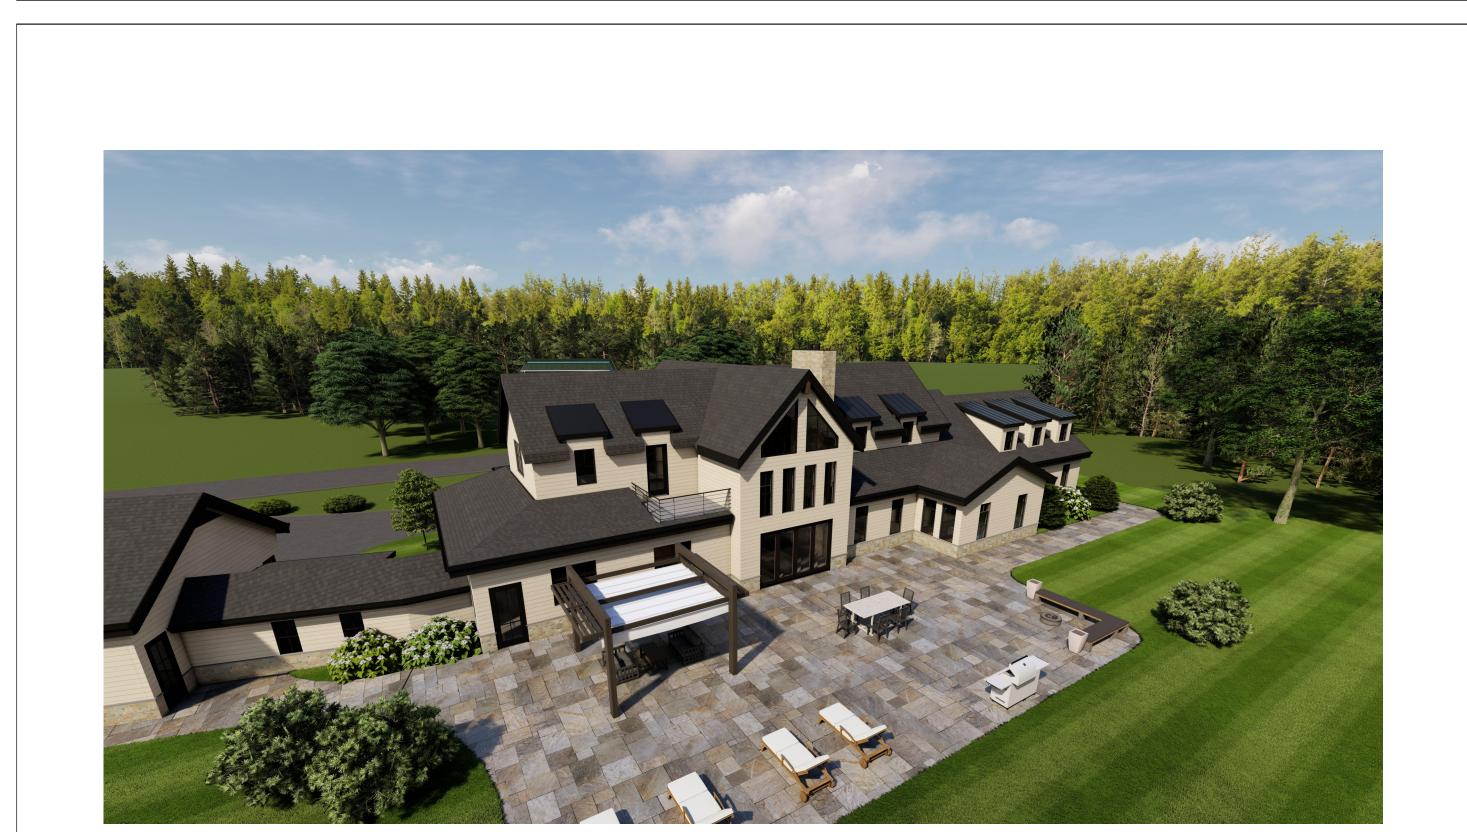



2 SOUTHEAST PERSPECTIVE VIEW SCALE: N.T.S