

SITE ADDRESS: 44 HENRY KAUFMANN ROAD ORANGEBURG, NEW YORK 10962

APPLICANT: UJA FEDERATION OF NEW YORK 130 EAST 59TH STREET NEW YORK, NEW YORK 10022

PEARL RIVER

HENRY KAUFMANN CAMPGROUNDS

SITE PLANS FOR DRAINAGE IMPROVEMENTS SICKLETOWN ROAD AREAS





UJA Federation

NEW YORK





	INDE>	K OF DRAWINGS
SHEET NO.	DRAWING <u>NO.</u>	TITLE
	COVER	COVER SHEET
1	C001-SW	GENERAL NOTES
2	C002-SW	EXISTING CONDITIONS BY OTHERS
3	C003-SW	EXISTING CONDITIONS BY OTHERS
4	C100-SW	EXISTING CONDITIONS AND REMOVALS PLAN
5	C200-SW	SITE, DRAINAGE AND GRADING PLAN
6	C300-SW	EROSION AND SEDIMENT CONTROL PLAN
7	C400-SW	STORMWATER UTLITY PROFILES
8	C-401-SW	DRY DETENTION BASIN CROSS SECTIONS
9	C500-SW	LANDSCAPE PLAN
10	D100-SW	DETAILS

EXISTING CONDITIONS NOTES

- 1. EXISTING CONDITIONS ARE TAKEN FROM A SURVEY PREPARED BY JAY A. GREENWELL, PLS, LLC, LAST UPDATED AUGUST 2019. 2. THE 100 YEAR FLOOD PLAIN SHOWN HEREON IS AS DEPICTED ON THE FLOOD
- INSURANCE RATE MAP (FIRM) FOR ROCKLAND COUNTY, NY PANELS 186 AND 178 OF 207 (MAP NUMBERS 36087C0186G AND 36087C0178G RESPECTIVELY). THESE MAPS HAVE BEEN ISSUED AS "PRELIMINARY 3/31/2011" AND HAVE NOT YFT BEEN OFFICIALLY ADOPTED BY FEMA. THE CURRENT FIRM PANELS ARE STILL IN EFFECT BUT WERE PUBLISHED IN 1962 AND DO NOT REFLECT THE CURRENT CONFIGURATION OF THE STREAM CHANNEL, CULVERTS. PHYSICAL FEATURES. ETC THE DEPICTION OF THE 2011 PRELIMINARY ELEVATIONS IS ALSO PREPARED IN NAVD 1988 AS IS THE TOPO SHOWN HEREON. WHILE THE 2011 PRELIMINARY MAPPING HAS NOT BEEN OFFICIALLY ADOPTED, IT IS MORE ACCURATE WITH RESPECT TO THE STREAM CHANNEL, CURRENT FLOW
- AND MORE CURRENT TOPOGRAPHIC DATA. 3. FEDERAL WETLANDS AREAS SHOWN AS DELINEATED BY ECOLOGICAL SOLUTIONS, ON MAY 5. 2017. AS PER ECOLOGICAL SOLUTIONS ALL WATER COURES SHOWN ARE REGULATED BY THE A.C.O.E.
- 4. WETLANDS SHOWN HEREON ARE SUBJECT TO VERIFICATION BY THE U. S. ARMY CORP OF ENGINEERS AND OR OTHER GOVERNMENT AGENCIES, IF APPLICABLE 5. UNDER AUTHORITY OF CHAPTER 486 OF THE LAWS OF 1975, THE ROCKLAND COUNTY DRAINAGE AGENCY HAS JURISDICTION OVER ACTIVITIES WITHIN CHANNEL LINES OF THE NAURASHAUN OR WITHIN 100 FEET THEREFROM. NOTE THAT NOTWITHSTANDING THAT LIMITED REGULATED AREA THE AGENCY HAS BEEN REGULATING ACTIVITIES ON ANY SITE
- CONTAINING A REGULATED STREAM. 6. PHYSICAL IMPROVEMENTS SHOWN HEREON HAVE BEEN LOCATED BY AERIAL PHOTOGRAMMETRY WITH FIELD AUGMENTATION WHERE SIGHT LINES OBSCURED. BUILDING DETAILS AND FEATURES NOT VISIBLE MAY OR MAY NOT BE SHOWN.
- 7. DATUM: NAVD 88 8. UNDERGROUND UTILITY LOCATIONS ARE DETERMINED BY OBSERVED PHYSICAL FEATURES AND/OR VERBAL INFORMATION PROVIDED BY JEFFERY COOPERSMITH, EXEC. DIR. ON 9/19/14. LOCATIONS ARE APPROXIMATE AND SHOULD NOT BE RELIED UPON FOR DESIGN OR CONSTRUCTION PURPOSES.

REFERENCES

- SUBJECT TO EASEMENTS OF RECORD AS WOULD BE DIVULGED BY AN UP-TO-DATE TITLE REPORT, INCLUDING BUT NOT NECESSARILY LIMITED TO THE FOLLOWING:
- I. PERMANENT DRAINAGE EASEMENT TO THE COUNTY OF ROCKLAND IN L 1046 PAGE 1047 (MAINTAINING AND REPAIRING BANK AND CHANNEL IMPROVEMENTS, ETC.). 2. PERPETUAL RIGHTS OF INGRESS AND EGRESS OVER A 50' STRIP EXTENDING EASTERLY TO SICKLETOWN ROAD (INCLUDING "?ALL CONDUITS OF PUBLIC
- UTILITIES") IN L 724 P 542, AND RIGHTS GRANTED ADJOINING OWNERS IN L 596 P 231. AS NOTED IN L 724 P 542, THE PREMISES MAY BE SUBJECT TO COVENANTS AND RESTRICTIONS IN L137 P 587 AND L 469 P 387.
- 3. ANY EASEMENTS GRANTED TO LOUIS GERMAIN AND WIFE (OR HEIRS AND/OR ASSIGNS) DESCRIBED IN DEED FROM TIERNEY IN L 671 P 278.
- 4. ANY EASEMENTS RESERVED BY POYNTON K. BISHOP (OR HEIRS AND/OR ASSIGNS) DESCRIBED IN DEED FROM PETTIT IN L 622 P 1. 5. DRAINAGE EASEMENT TO THE TOWN OF ORANGETOWN IN L 649 P 204.
- 6. SANITARY SEWER EASEMENT TO THE TOWN OF ORANGETOWN IN L 649 P 210. 7. SANITARY SEWER EASEMENT TO THE TOWN OF ORANGETOWN IN L 756 P 239
- 8. PERMANENT EASEMENTS FOR MORRIS C. VAN HOUTEN AND EVA F. VAN HOUTEN (OR HEIRS AND/OR ASSIGNEES) AS DESCRIBED IN L 1040 P1042, INCLUDING INGRESS AND EGRESS AND UTILITIES AS NOTED. 9. EASEMENT TO DR. WILLARD L. NASH FOR MAINTENANCE OF A WATER PIPE AND
- ELECTRIC POWER LINE FROM THE NAURASHAUN BROOK, 10' IN WIDTH IN L 699 P 475. 10. 100' BUFFER IN FAVOR OF MANHATTAN WOODS CORPORATION ALONG THE
- NORTHERLY PROPERTY LINE AS SHOWN HEREON, PERMITTING USAGE OF THE BUFFER AREA FOR GOLF EVENTS AND RESTRICTING USE BY SURVEYED SITE AS DESCRIBED IN L 472 P 2734. 1. 6' WIDE PEDESTRIAN EASEMENT TO NAURASHAUN PRESBYTERIAN CHURCH AS DESCRIBED IN L 775 P 1181.
- 12. UTILITY EASEMENTS IN FAVOR OF ORANGE AND ROCKLAND UTILITIES TO PROVIDE ELECTRIC AND GAS SERVICE TO SURVEYED SITE AS DESCRIBED IN L 157 P 2924 AND L 1073 P 154. DOCUMENTS OF RECORD INDICATE THAT THE PROPERTY MAY BE SUBJECT TO RIGHTS OF OTHERS AS NOTED ABOVE TO USE PORTIONS OF THE PREMISES FOR ACCESS, UTILITIES, WATER, DRAINAGE, ETC. THE PREPARATION OF A COMPREHENSIVE TITLE REPORT IS ADVISED TO REVIEW AND ASSESS ANY AND ALL ENCUMBRANCES ON THE PROPERTY, AND TO DETERMINE WHAT EASEMENTS ARE STILL IN EFFECT AND WHICH MAY HAVE BEEN FLIMINATED.

DEMOLITION NOTES

- 1. CONTRACTOR SHALL COMPLY WITH DIG SAFE NEW YORK PRIOR TO INITIATING ANY DEMOLITION WORK ONSITE.
- 2. CONTRACTOR SHALL INSTALL APPROPRIATE EROSION CONTROL MEASURES PRIOR TO INITIATING ANY DEMOLITION WORK ONSITE.
- 3. STOCKPILING OF EXCAVATED OR DEMOLITION MATERIAL IS NOT PERMITTED ONSITE WITHOUT APPROVAL FROM THE OWNER.
- 4. ALL UTILITIES SHALL BE ABANDONED OR REMOVED IN ACCORDANCE WITH UTILITY PROVIDER'S REQUIREMENTS.
- 5. ALL DEMOLITION MATERIAL MUST BE REMOVED FROM THE PROJECT SITE AND DISPOSED OF IN ACCORDANCE WITH LOCAL AND STATE REQUIREMENTS.

EROSION AND SEDIMENT CONTROL NOTES PRE-CONSTRUCTION ACTIVITIES

- WETLANDS, SHOULD BE NOTED AND REPORTED TO THE DESIGN ENGINEER.
- 3. NOTIFY THE DESIGN ENGINEER OF ANY OTHER DISCREPANCIES NOTED IN THE FIELD. 4. IDENTIFY ON-SITE AND DOWNSTREAM SURFACE WATER BODIES AND INSTALL CONTROLS TO PROTECT THEM FROM SEDIMENTATION.
- **CONSTRUCTION ACTIVITIES FOR ALL STAGES**
- FROM THE TIRES OF CONSTRUCTION VEHICLES.
- DISTURBED.
- APPROVAL BEFORE CONTINUING WITH EARTH DISTURBING ACTIVITIES.
- OF THE WORK.
- 7. CONSTRUCT TEMPORARY MATERIAL STORAGE AND SOIL STOCKPILE AREAS
- FROM ENTERING WASHOUT LOCATION.
- CONSTRUCTION, ALL MATERIAL FROM THE WASHOUT AREA SHALL BE REMOVED AND DISPOSED OF. 10. STABILIZE TOPSOIL STOCKPILE AREAS WITH SEED AND MULCH.
- INDICATED ON CONSTRUCTION PLANS.
- 13. CLEAN, RE-GRADE AND STABILIZE TEMPORARY SEDIMENT TRAP FOR CONVERSION TO PERMANENT PRACTICE. 14. REMOVE PERIMETER SILT FENCE WHEN A STABILIZING PERMANENT STAND OF VEGETATION IS ACHIEVED.

EROSION AND SEDIMENT CONTROL MEASURES:

- AND SPECIFICATIONS FOR EROSION AND SEDIMENT CONTROL", AUGUST 2005.
- DISTURBED AREAS AND BY REMOVING SEDIMENT FROM CONSTRUCTION SITE DISCHARGES.
- EXPOSED SOILS.
- 6. SEEDED AREAS TO BE MULCHED WITH STRAW OR HAY MULCH IN ACCORDANCE WITH VEGETATIVE COVER SPECIFICATIONS.
- MEASURES THROUGHOUT THE COURSE OF CONSTRUCTION.
- WATER AS REQUIRED. THE CONTRACTOR IS TO SUPPLY ALL EQUIPMENT AND WATER.

MAINTENANCE OF EROSION AND SEDIMENT CONTROL MEASURES: PERMANENT AND TEMPORARY VEGETATION: INSPECT ALL AREAS THAT HAVE RECEIVED VEGETATION EVERY SEVEN DAYS AND AFTER EVERY STORM EVENT THAT EQUALS OR EXCEEDS 1/2 INCH. ALL AREAS DAMAGED BY EROSION OR WHERE SEED HAS NOT ESTABLISHED SHALL BE REPAIRED AND RE-STABILIZED IMMEDIATELY.

STABILIZED CONSTRUCTION ENTRANCE: INSPECT THE ENTRANCE PAD EVERY SEVEN DAYS AND AFTER EVERY STORM EVENT THAT EQUALS OR EXCEEDS 1/2 INCH. CHECK FOR MUD, SEDIMENT BUILD-UP AND PAD INTEGRITY. MAKE DAILY INSPECTIONS DURING WET WEATHER. RESHAPE PAD AS NEEDED FOR DRAINAGE AND RUNOFF CONTROL. WASH AND REPLACE STONE AS NEEDED. THE STONE IN THE ENTRANCE SHOULD BE WASHED OR REPLACED WHENEVER THE ENTRANCE FAILS TO REDUCE MUD BEING CARRIED OFF-SITE BY VEHICLES. IMMEDIATELY REMOVE MUD AND SEDIMENT TRACKED OR WASHED ONTO PUBLIC ROADS BY BRUSHING OR SWEEPING. REMOVE TEMPORARY CONSTRUCTION ENTRANCE AS SOON AS THEY ARE NO LONGER NEEDED TO PROVIDE ACCESS TO THE SITE.

<u>SILT FENCE:</u> INSPECT FOR DAMAGE EVERY SEVEN DAYS AND AFTER EVERY STORM EVENT THAT EQUALS OR EXCEEDS 1/2 INCH. MAKE ALL REPAIRS IMMEDIATELY. REMOVE SEDIMENT FROM THE UP-SLOPE FACE OF THE FENCE BEFORE IT ACCUMULATES TO A HEIGHT EQUAL TO 1/3 THE HEIGHT OF THE FENCE. IF FENCE FABRIC TEARS, BEGINS TO DECOMPOSE, OR IN ANY WAY BECOMES INEFFECTIVE, REPLACE THE AFFECTED SECTION OF FENCE IMMEDIATELY.

SOIL STOCKPILE: INSPECT SEDIMENT CONTROL BARRIERS (SILT FENCE OR HAY BALE) AND VEGETATION FOR DAMAGE EVERY SEVEN DAYS AND AFTER EVERY STORM EVENT THAT EQUALS OR EXCEEDS 1/2 INCH. MAKE ALL REPAIRS IMMEDIATELY. REMOVE SEDIMENT FROM THE UP-SLOPE FACE OF THE SEDIMENT CONTROL BARRIER BEFORE IT ACCUMULATES TO A HEIGHT EQUAL TO 1/3 THE HEIGHT OF THE SEDIMENT CONTROL BARRIER. IF SEDIMENT CONTROL BARRIER TEARS, BEGINS TO DECOMPOSE, ÓR IN ANYWAY BECOMES INEFFECTIVE, REPLACE THE AFFECTED SECTION OF SEDIMENT CONTROL BARRIER IMMEDIATELY. REVEGETATE DISTURBED AREA TO STABILIZE SOIL STOCK PILE. REMOVE THE SEDIMENT CONTROL BARRIER WHEN THE SOIL STOCKPILE HAS BEEN REMOVED.

COULD CREATE RUNOFF AND EROSION PROBLEMS.

SNOW AND ICE CONTROL: PARKING LOTS, ROADWAYS, AND DRIVEWAYS ADJACENT TO WATER QUALITY FILTERS SHALL NOT BE SANDED DURING SNOW EVENTS DUE TO HIGH POTENTIAL FOR CLOGGING FROM SAND IN SURFACE WATER RUNOFF. USE SALT ONLY FOR SNOW AND ICE CONTROL.

1. THE CONTRACTOR IS TO REVIEW THIS DOCUMENT WITH ALL EMPLOYEES AND SUBCONTRACTORS IN ORDER TO GAIN UNDERSTANDING OF THE RELATIONSHIP BETWEEN THE STORMWATER ANALYSIS AND THE MANAGEMENT PRACTICES AND SEDIMENT CONTROLS OUTLINED IN THIS DOCUMENT AS THEY RELATE TO THE ENGINEERED PROJECT PLANS. 2. A SITE INVESTIGATION IS TO BE PERFORMED SO THAT ALL NATURAL RESOURCES ARE IDENTIFIED AND THEN MARKED SO THAT THEY ARE PROTECTED DURING CONSTRUCTION ACTIVITIES. THIS INCLUDES BUT IS NOT LIMITED TO TREES VEGETATION, AND WETLANDS. ANY DISCREPANCIES THAT MAY EXIST BETWEEN THE SITE AND WHAT IS SHOWN ON THE ENGINEERED PROJECT PLANS AS THEY PERTAIN TO EXISTING WATERCOURSES, GROUND COVER, TOPOGRAPHY,

5. CONTRACTORS MAY NOT DISTURB MORE THAN FIVE ACRES OF SOIL UNLESS SPECIFICALLY PERMITTED BY THE PROJECT'S SWPPP. ANY SIGNIFICANT DEVIATION TO THE PROJECT PHASING PLAN MUST BE REVIEWED BY THE OWNER OR OPERATOR AND THE DESIGN ENGINEER TO IDENTIFY IF NOTIFICATION TO NYSDEC OR MUNICIPALITY'S ENGINEER IS REQUIRED TO AMEND THE SWPPP OR THE APPROVED PHASING PLAN.

1. ESTABLISH A TEMPORARY STABILIZED CONSTRUCTION ENTRANCE PER THE LATEST EDITION OF THE "NEW YORK STATE STANDARDS AND SPECIFICATION FOR EROSION AND SEDIMENT CONTROL" (BLUE BOOK), TO CAPTURE MUD AND DEBRIS 2. INSTALL PERIMETER SEDIMENT CONTROL FENCE A MAXIMUM OF FIVE (5) FEET DOWN-SLOPE OF AREAS TO BE 3. CLEAR TREES AND BRUSH FROM WITHIN THE PROPOSED STORMWATER MANAGEMENT AREAS.

4. NOTIFY DESIGN ENGINEER FOR INSPECTION OF TEMPORARY SEDIMENT TRAPS/STORMWATER MANAGEMENT AREAS FOR 5. STABILIZE TEMPORARY SEDIMENT TRAPS AND STORMWATER MANAGEMENT AREAS WITH SEED AND MULCH PER NEW YORK STATE STANDARDS AND SPECIFICATION FOR EROSION AND SEDIMENT CONTROL AND PROJECT PLANS. 6. CLEAR THE MINIMUM AMOUNT OF BRUSH AND TREES WITHIN THE DEVELOPMENT AREA THAT WILL ALLOW PERFORMANCE 8. AS CONCRETE IS DELIVERED AND PLACED ON SITE, A CENTRALLY LOCATED CONCRETE WASHOUT AREA APPROXIMATELY

15-FEET SQUARE AND 2.5-FEET DEEP SHALL BE PROVIDED. THIS WASHOUT AREA SHALL BE ENCLOSED BY SILT FENCE, LOCATED NEXT TO A PAVED ROAD AND SITUATED A MINIMUM OF 50-FEET FROM A WATERCOURSE. REQUIRED, TEMPORARY DIVERSION DIKES SHALL BE INSTALLED AROUND WASHOUT AREA TO PREVENT STORMWATER 9. WASTE MATERIAL FROM CONCRETE WASHOUT OPERATIONS SHALL BE PERIODICALLY REMOVED AND LEGALLY DISPOSED OF WHEN TWO-THIRDS OF THE WASHOUT STORAGE AREA HAS ACCUMULATED WITH MATERIAL. AT THE END OF

11. PERFORM REQUIRED GRADING AND EARTHWORK (CUT AND FILL) OPERATIONS. INSTALL RIP RAP STABILIZATION WHERE 12. STABILIZE DISTURBED AREAS WITH SEED AND MULCH OUTSIDE AREAS TO RECEIVE PAVEMENT.

1. ALL EROSION AND SEDIMENT CONTROL MEASURES ARE TO BE IN STRICT COMPLIANCE WITH "NEW YORK STATE STANDARDS 2. DAMAGE TO SURFACE WATERS RESULTING FROM EROSION AND SEDIMENTATION SHALL BE MINIMIZED BY STABILIZING

3. AS MUCH AS IS PRACTICAL, EXISTING VEGETATION SHALL BE PRESERVED. FOLLOWING THE COMPLETION OF CONSTRUCTION ACTIVITIES IN ANY PORTION OF THE SITE, PERMANENT VEGETATION SHALL BE ESTABLISHED ON ALL

4. SITE PREPARATION ACTIVITIES SHALL BE PLANNED TO MINIMIZE THE SCOPE AND DURATION OF SOIL DISRUPTION. 5. PERMANENT TRAFFIC CORRIDORS SHALL BE ESTABLISHED AND "ROUTES OF CONVENIENCE" SHALL BE AVOIDED. STABILIZED CONSTRUCTION ENTRANCES SHALL BE INSTALLED AT ALL POINTS OF ENTRY ONTO THE PROJECT SITE.

7. THE CONTRACTOR IS RESPONSIBLE FOR THE INSTALLATION AND MAINTENANCE OF ALL EROSION AND SEDIMENT CONTROL 8. THE CONTRACTOR IS RESPONSIBLE FOR CONTROLLING DUST BY SPRINKLING EXPOSED SOIL AREAS PERIODICALLY WITH

9. WHEN ALL DISTURBED AREAS ARE STABLE, ALL TEMPORARY EROSION AND SEDIMENT CONTROL MEASURES SHALL BE

DUST CONTROL: SCHEDULE CONSTRUCTION OPERATIONS TO MINIMIZE THE AMOUNT OF DISTURBED AREAS AT ANY ONE TIME DURING THE COURSE OF WORK. APPLY TEMPORARY SOIL STABILIZATION PRACTICES SUCH AS MULCHING, SEEDING, AND SPRAYING (WATER). STRUCTURAL MEASURES (MULCH, SEEDING) SHALL BE INSTALLED IN DISTURBED AREAS BEFORE SIGNIFICANT BLOWING PROBLEMS DEVELOP. WATER SHALL BE SPRAYED AS NEEDED. REPEAT AS NEEDED, BUT AVOID EXCESSIVE SPRAYING, WHICH

GENERAL NOTES

- 1. ALL WORK SHALL BE PERFORMED IN STRICT COMPLIANCE WITH ALL THE REQUIREMENTS OF LOCAL, STATE, AND NATIONAL BUILDING AND SAFETY CODES AND ALL GOVERNING AGENCIES HAVING JURISDICTION OVER THE PROJECT
- 2. IN CASE OF ANY DISCREPANCY BETWEEN DRAWINGS AND SPECIFICATIONS, THE BETTER QUALITY OR GREATER QUANTITY OF WORK SHALL BE PROVIDED.
- 3. WORK UNDER THE CONTRACT SHALL INCLUDE, UNLESS OTHERWISE NOTED, ALL LABOR, MATERIAL, FINISHES, EQUIPMENT AND SERVICES NECESSARY FOR AND INCIDENTAL TO FURNISHING AND INSTALLING COMPLETE ALL WORK REQUIRED UNDER THE CONTRACT DOCUMENTS. 4. WHERE MANUFACTURER'S RECOMMENDATIONS OR INSTRUCTION ARE REFERENCED, WORK SHALL BE
- ACCOMPLISHED IN STRICT ACCORDANCE WITH SAME, UNLESS AT VARIANCE WITH CODES, OR MORE STRINGENT REQUIREMENTS SPECIFIED
- 5. CONTRACTOR SHALL HAVE ON THE JOBSITE, AT ALL TIMES, AND SHALL WORK FROM, A COMPLETE SET OF FINAL CONTRACT DOCUMENTS/DRAWINGS AND ANY CONTRACT MODIFICATIONS. 6. THE GENERAL CONTRACTOR SHALL COORDINATE WORK INVOLVING DIFFERENT TRADES AND NOTIFY
- THE ENGINEER OF ANY DISCREPANCY OR REQUIREMENT PRIOR TO START OF CONSTRUCTION. ELECTRICAL, MECHANICAL, AND PLUMBING DRAWINGS ARE SCHEMATIC AND PROPER FIELD COORDINATION SHALL BE DONE BY THE GENERAL CONTRACTOR PRIOR TO START OF CONSTRUCTION. 7. PRIOR TO BID THE CONTRACTOR SHALL EXAMINE ALL PROJECT DOCUMENTS TO DEVELOP A COMPLETE UNDERSTANDING OF THE PROJECT SCOPE. FAILURE TO REVIEW ALL CONTRACT
- DOCUMENTS WILL NOT RELIEVE THE CONTRACTOR OF HIS/HER RESPONSIBILITY TO PERFORM ALL WORK REQUIRED AND AT NO ADDITIONAL COST TO THE OWNER. THE CONTRACTOR SHALL, UPON REVIEW OF THE CONTRACT DOCUMENTS, IMMEDIATELY BRING TO THE ENGINEER'S ATTENTION ANY DISCREPANCIES WHICH WILL AFFECT THE WORK REQUIRED.
- 8. CONTRACTOR AND SUBCONTRACTORS SHALL REVIEW, CHECK, AND VERIFY ALL DIMENSIONS AND DETAILS ON THE DRAWINGS FOR CORRECTNESS AND COMPATIBILITY WITH ALL PHASES OF WORK. NOT SCALE THE DRAWINGS. THE CONTRACTOR SHALL TAKE FIELD MEASUREMENTS AND VERIFY FIELD CONDITIONS AND SHALL CARFFULLY COMPARE SUCH FIFLD CONDITIONS AND OTHER INFORMATION KNOWN TO THE CONTRACTOR WITH THE CONTRACT DOCUMENTS BEFORE SUBMITTING A BID. ERRORS, INCONSISTENCIES OR OMISSIONS DISCOVERED SHALL BE REPORTED TO THE ENGINEER FOR RESOLUTION IMMEDIATELY.
- 9. THE CONTRACTOR WILL BE REQUIRED TO CHECK ALL DRAWINGS ISSUED TO HIM/HER AGAINST CONDITIONS AT THE SITE. HE/SHE (THE CONTRACTOR) IS REQUIRED TO IMMEDIATELY REPORT TO THE ENGINEER ANY DISCREPANCY BETWEEN THE DRAWINGS AND EXISTING CONDITIONS. NO ALLOWANCE FOR ADDITIONAL PAYMENT WILL BE MADE FOR THE CONTRACTOR'S FAILURE TO VERIFY ALL EXISTING SITE CONDITIONS WITH THE CONTRACT DOCUMENTS. 10. ALL TESTS AND INSPECTIONS REQUIRED BY THE LOCAL, STATE AND GOVERNING AGENCIES SHALL
- BE CONDUCTED AND THE CONTRACTOR/SUBCONTRACTOR RESPONSIBLE FOR THE WORK SHALL NOTIFY THE GOVERNING AGENCY AND THE ENGINEER A MINIMUM OF 24 HOURS PRIOR TO CONDUCTION OF THE TEST AND/OR INSPECTION. 11. CONTRACTOR SHALL VERIFY ACTUAL LOCATIONS OF ALL UTILITIES PRIOR TO ANY EXCAVATING.
- 12. THE CONTRACTOR IS RESPONSIBLE FOR SAFEKEEPING OF MATERIALS INCLUDING THOSE SUPPLIED BY THE OWNER. 13. DETAILS MAY SHOW SELECTED REQUIRED FASTENER TYPES, SIZES AND LOCATIONS. WHERE FASTENERS ARE DETAILED OR SCHEDULED, SUCH FASTENERS SHALL NOT BE CONSIDERED A
- COMPLETE REPRESENTATION OF ALL FASTENING REQUIRED. 14. ALL MATERIALS AND SHAPES INDICATED IN SECTIONS ARE CONTINUOUS UNLESS SPECIFICALLY NOTED OTHERWISE
- 15. ALL PRODUCTS AND CONSTRUCTION INDICATED ON THE DRAWINGS AND SPECIFICATIONS SHALL BE CONSIDERED TO BEE NEW UNLESS SPECIFICALLY NOTED AS EXISTING OR REUSED. 16. ALL MATERIALS SHALL BE AS SPECIFIED OR EQUAL AS APPROVED BY ENGINEER. SPECIFIC
- MATERIALS SPECIFIED IS MEANT TO INDICATE QUALITY INTENT WHICH WILL BE USED AS A BASIS FOR COMPARISON WITH SUBSTITUTES SUBMITTED FOR APPROVAL.THE DECISION AS TO WHAT IS EQUAL IS TO BE DETERMINED BY THE ENGINEER.

17. CONTROL ACCUMULATION OF WASTE MATERIALS AND RUBBISH DURING CONSTRUCTION; PERIODICALLY

DISPOSE OF OFF-SITE. PERFORM A FINAL CLEANING AT THE COMPLETION OF THE CONTRACT.

EXISTING UTILTIES, STRUCTURES, AND SITE CONDITIONS

- 1. ALL UNDERGROUND UTILITIES ARE SHOWN IN THEIR RELATIVE POSITION AND ARE FOR INFORMATION ONLY. THEIR EXACT
- LOCATION SHALL BE CHECKED BY THE CONTRACTOR AT THE SITE BEFORE CONSTRUCTION BEGINS. 2. CONTRACTOR SHALL TAKE PHOTOGRAPHS OF SITE CONDITION PRIOR TO DISTURBANCE. PHOTOGRAPHS SHALL DEPICT
- CONDITION AND LOCATION OF ASSETS WITHIN THE PROJECT LIMITS AND ADJACENT ASSETS THAT MAY BE INFLUENCED/AFFECTED BY CONSTRUCTION ACTIVITIES. ALL REASONABLE EFFORTS SHALL BE MADE BY CONTRACTOR TO IDENTIFY AND BRING TO ATTENTION OF ENGINEER ANY ASSETS THAT ARE DAMAGED PRIOR TO SITE DISTURBANCE. CONTRACTOR IS ENCOURAGED TO VIDEOTAPE CONDITION OF SITE AND ADJACENT ASSETS PRIOR TO SITE DISTURBANCE. 3. CONTRACTOR SHALL RESTORE LAWNS DRIVEWAYS, WALKS, CURBS, FENCES ETC. TO A CONDITION AT LEAST AS GOOD AS
- THEY WERE BEFORE BEING DISTURBED. 4. ANY AND ALL EXISTING UTILITIES IF DAMAGED BY THE CONTRACTOR SHALL BE REPLACED IN KIND WITH NEW MATERIALS AT THE CONTRACTORS EXPENSE, TO THE SATISFACTION OF THE UTILITY OWNER.

LANDSCAPING NOTES

- LANDSCAPE ARCHITECT. 3. THE PLANT SIZES SHOWN ARE THE MINIMUMS FOR EACH CATEGORY (HEIGHT, SPREAD,
- 5. THE PLANT'S VEGETATIVE CANOPY SHALL BE SYMMETRICAL AND FREE OF LARGE VOIDS OR FLAT SURFACE AREAS ON ONE SIDE.
- MANUFACTURER'S RECOMMENDATIONS. COST
- SHALL BE AT NO COST TO THE OWNER.
- 10. ALL PLANT BEDS SHALL BE THOROUGHLY ROTO-TILLED A MINIMUM OF TWELVE
- APPROVED BY THE OWNER'S REPRESENTATIVE.
- WHENEVER POSSIBLE.
- MANUFACTURER.
- APPLICATIONS OF HERBICIDES, FUNGICIDES, INSECTICIDES AND PESTICIDES AS NECESSARY. PERENNIALS AND SEEDED AREAS.
- TIME OF FINAL ACCEPTANCE BY THE OWNER.
- SHRUBS, MULCH ENTIRE BED.
- ACCEPTANCE OF PLANT MATERIAL BY OWNER.

1. THE QUANTITIES INDICATED ON THE DRAWINGS AND ON THE PLANT MATERIAL SCHEDULE ARE PROVIDED FOR THE BENEFIT OF THE LANDSCAPE CONTRACTOR BUT SHOULD NOT BE ASSUMED TO BE CORRECT. THE LANDSCAPE CONTRACTOR SHALL BE RESPONSIBLE FOR VERIFYING THE QUANTITIES INDICATED. ANY DISCREPANCIES NOTED SHALL BE BROUGHT TO THE ATTENTION OF HE OWNER PRIOR TO INSTALLATION. IN THE EVENT OF A DISCREPANCY, THE GRAPHIC REPRESENTATIONS SHOWN ON THE DRAWINGS SHALL GOVERN.

2. NO SUBSTITUTIONS AS TO SIZE, TYPE, SPACING, QUANTITY OR QUALITY OF PLANT MATERIAL SHALL BE MADE WITHOUT THE WRITTEN APPROVAL OF BOTH THE OWNER AND THE PROJECT

CALIPER, CONTAINER SIZE, ETC.) WHEN A RANGE OF SIZE IS GIVEN, 75% OF THE PLANTS SUPPLIED SHALL MEET THE MAXIMUM RANGE SIZE, AND 25% OF THE PLANTS SUPPLIED SHALI BE THE MINIMUM RANGE SIZE SPECIFIED. THE PLANTS SUPPLIED SHALL CONFORM TO ALL (HE MINIMUM DIMENSIONS INDICATED. PLANTS OF LARGER SIZE MAY BE USED IF ACCEPTABLE TO THE OWNER AT NO ADDITIONAL COST AND IF SIZES OF CONTAINER OR ROOT BALLS. HEIGHT, AND SPREAD ARE INCREASED PROPORTIONATELY IN ACCORDANCE WITH ANSI Z-60.1. ALL OTHER QUALITY REQUIREMENTS OF THE PLANT MATERIAL MUST ALSO BE ADHERED. 4. ALL PLANTS SHALL BE NURSERY GROWN, BALL AND BURLAPED (B&B) OR CONTAINER GROWN AS-SPECIFIED IN THE MATERIALS SCHEDULE. CONTAINER GROWN MATERIAL MAY BE SUBSTITUTED FOR B&B MATERIAL WITH WRITTEN APPROVAL BY THE OWNER PRIOR TO INSTALLATION. ALL PLANT MATERIALS SHALL CONFORM WITH ANSI Z-60.1, LATEST EDITION. ALL PLANTS SHALL BE HIGHEST QUALITY, FIRST CLASS REPRESENTATIVES OF THEIR SPECIES. SECONDS, CULLS, OR PARK GRADE MATERIAL WILL BE REJECTED.

6. SHRUBS MOVED DURING PERIODS OF HIGH TRANSPIRATION SHALL BE SPRAYED WITH AN ANTI-DESSICANT PRIOR TO MOVING. APPLY AND REMOVE ANTI-DESSICANTS PER THE

7. ALL PLANTS ARE SUBJECT TO REVIEW AND APPROVAL BY THE OWNER AT ANY TIME PRIOR TO FINAL ACCEPTANCE. REJECTED PLANTS SHALL BE REPLACED IMMEDIATELY AT NO ADDITIONAL

8. PRIOR TO COMMENCEMENT OF INSTALLATION, THE CONTRACTOR SHALL BE RESPONSIBLE FOR LOCATING ALL EXISTING UTILITIES AND SHALL AVOID DAMAGING UTILITIES DURING INSTALLATION. ANY UTILITIES DAMAGED DURING INSTALLATION SHALL BE REPAIRED BY THE CONTRACTOR TO THE SATISFACTION OF THE APPROPRIATE UTILITY COMPANY AND THE OWNER. ALL REPAIRS

9. PLANTING PIT SHALL BE 100% FINELY CHOPPED NATIVE SOIL.

INCHES (12"), UNLESS OTHERWISE NOTED, PRIOR TO PLANT PLACEMENT. AMENDMENTS, II REQUIRED BASED ON SITE-SPECIFIC SOIL TEST RESULTS, SHALL BE THOROUGHLY TILLED INTO THE SOIL BASED ON THE TEST RESULT RECOMMENDATIONS. 11. THE CONTRACTOR SHALL UTILIZE ON-SITE TOPSOIL AS AVAILABLE. ALL TOPSOIL SHALL BE 12. NO PLANTS SHALL BE INSTALLED IN POOR DRAINAGE CONDITIONS. CONTRACTOR IS RESPONSIBLE FOR TESTING SUSPECT PLANT PITS PRIOR TO PLANT INSTALLATION. 13. ALL PLANTS SHALL BE PLACED WITH THE BEST FACE FORWARD, TOWARDS THE ADJOINER

14. ALL PLANTS SHALL BE PRUNED AS NECESSARY PRIOR TO INSTALLATION. 15. PRE-EMERGENT HERBICIDES, TREFLAN, PREEN, OR APPROVED EQUAL, SHALL BE APPLIED TO ALL PLANTING BEDS PRIOR TO MULCHING. APPLY PER MANUFACTURER'S RECOMMENDATIONS. HERBICIDES SHALL BE INCORPORATED INTO THE SOIL AT THE RECOMMENDATION OF THE

16. APPLY ORGANIC ROOT STIMULATOR, CONTAINING MYCORRHIZAE, TO ALL PLANTS PRIOR TO BACKFILLING. APPLY PER MANUFACTURER'S RECOMMENDATIONS. CONTRACTOR TO SUBMIT SAMPLES OF ROOT STIMULATOR TO THE OWNER'S REPRESENTATIVE FOR APPROVAL PRIOR TO 17. THE CONTRACTOR IS RESPONSIBLE FOR MAINTAINING THE PLANT INSTALLATIONS UNTIL ACCEPTED BY THE OWNER. MAINTENANCE SHALL INCLUDE RE-MULCHING, WATERING,

MAINTENANCE SHALL INCLUDE ALL PLANTINGS, TREES, SHRUBS, GROUNDCOVERS, ANNUALS, 18. THE CONTRACTOR SHALL GUARANTEE THAT ALL PLANTS SHALL BE IN A HEALTHY AND THRIVING CONDITION ACCORDING TO THE NATURAL GROWTH HABITS OF THE INDIVIDUAL SPECIES AT THE 19. MULCH ALL BEDS WITH 3" DEPTH, SHREDDED HARDWOOD BARK MIXTURE. IN GROUPINGS OF

20. ONE YEAR GUARANTEE SHALL BE PROVIDED ON ALL PLANT MATERIALS FROM DATE OF FINAL 21. PROTECT ALL TREES TO REMAIN.



Stantec 475 Fifth Avenue 12th Floor New York, NY 10017-7239 www.stantec.com

Copyright Reserved

authorized by Stantec is forbidden.

ne Contractor shall verify and be responsible for all dimensions. DO NOT scale the drawing - any errors or omissions shall be reported to Stantec without delay. The Copyrights to all designs and drawings are the property of Stantec. Reproduction or use for any purpose other than that

Consultants

Legend

Notes

PROJECT BOUNDARY SITE AREA KFY MAP

N.T.S.

_ ____ ___ REVISED PER TOWN COMMENT GCF TAW 20.06.23 GCF TAW 19.11.19 REVISIONS FOR SWPPP GCF TAW 19.10.11 REVISED BASIN LAYOUT GCF TAW 19.07.11 REVISED BASIN By Appd. YY.MM.DD Revision GCF TAW 20.06.23 town submission GCF TAW 19.11.06 TOWN PLANNING BOARD SUBMISSION GCF TAW 19.10.11 ISSUED TO CLIENT town submission MJG TAW 19.09.16 GCF TAW 19.07.11 ISSUED TO CHENT GCF TAW 19.04.25 TOWN SUBMISSION _ ____ _ ___ By Appd. YY.MM.DD lssued _____ File Name: Phase 1 Drainage Improvements.dwg GCF TAW GCF 19.04.25 Dwn. Chkd. Dsgn. YY.MM.DD Permit-Seal Client/Proiect UJA FEDERATION OF NEW YORK UJA Pearl River Dav Camp Proposed Improvements Orangetown, New York


GENERAL NOTES

SW MANAGEMENT IMPROVEMENTS _____ Project No. Scale


NTS 195115085 Drawing No. Sheet Revision

C-001-SW




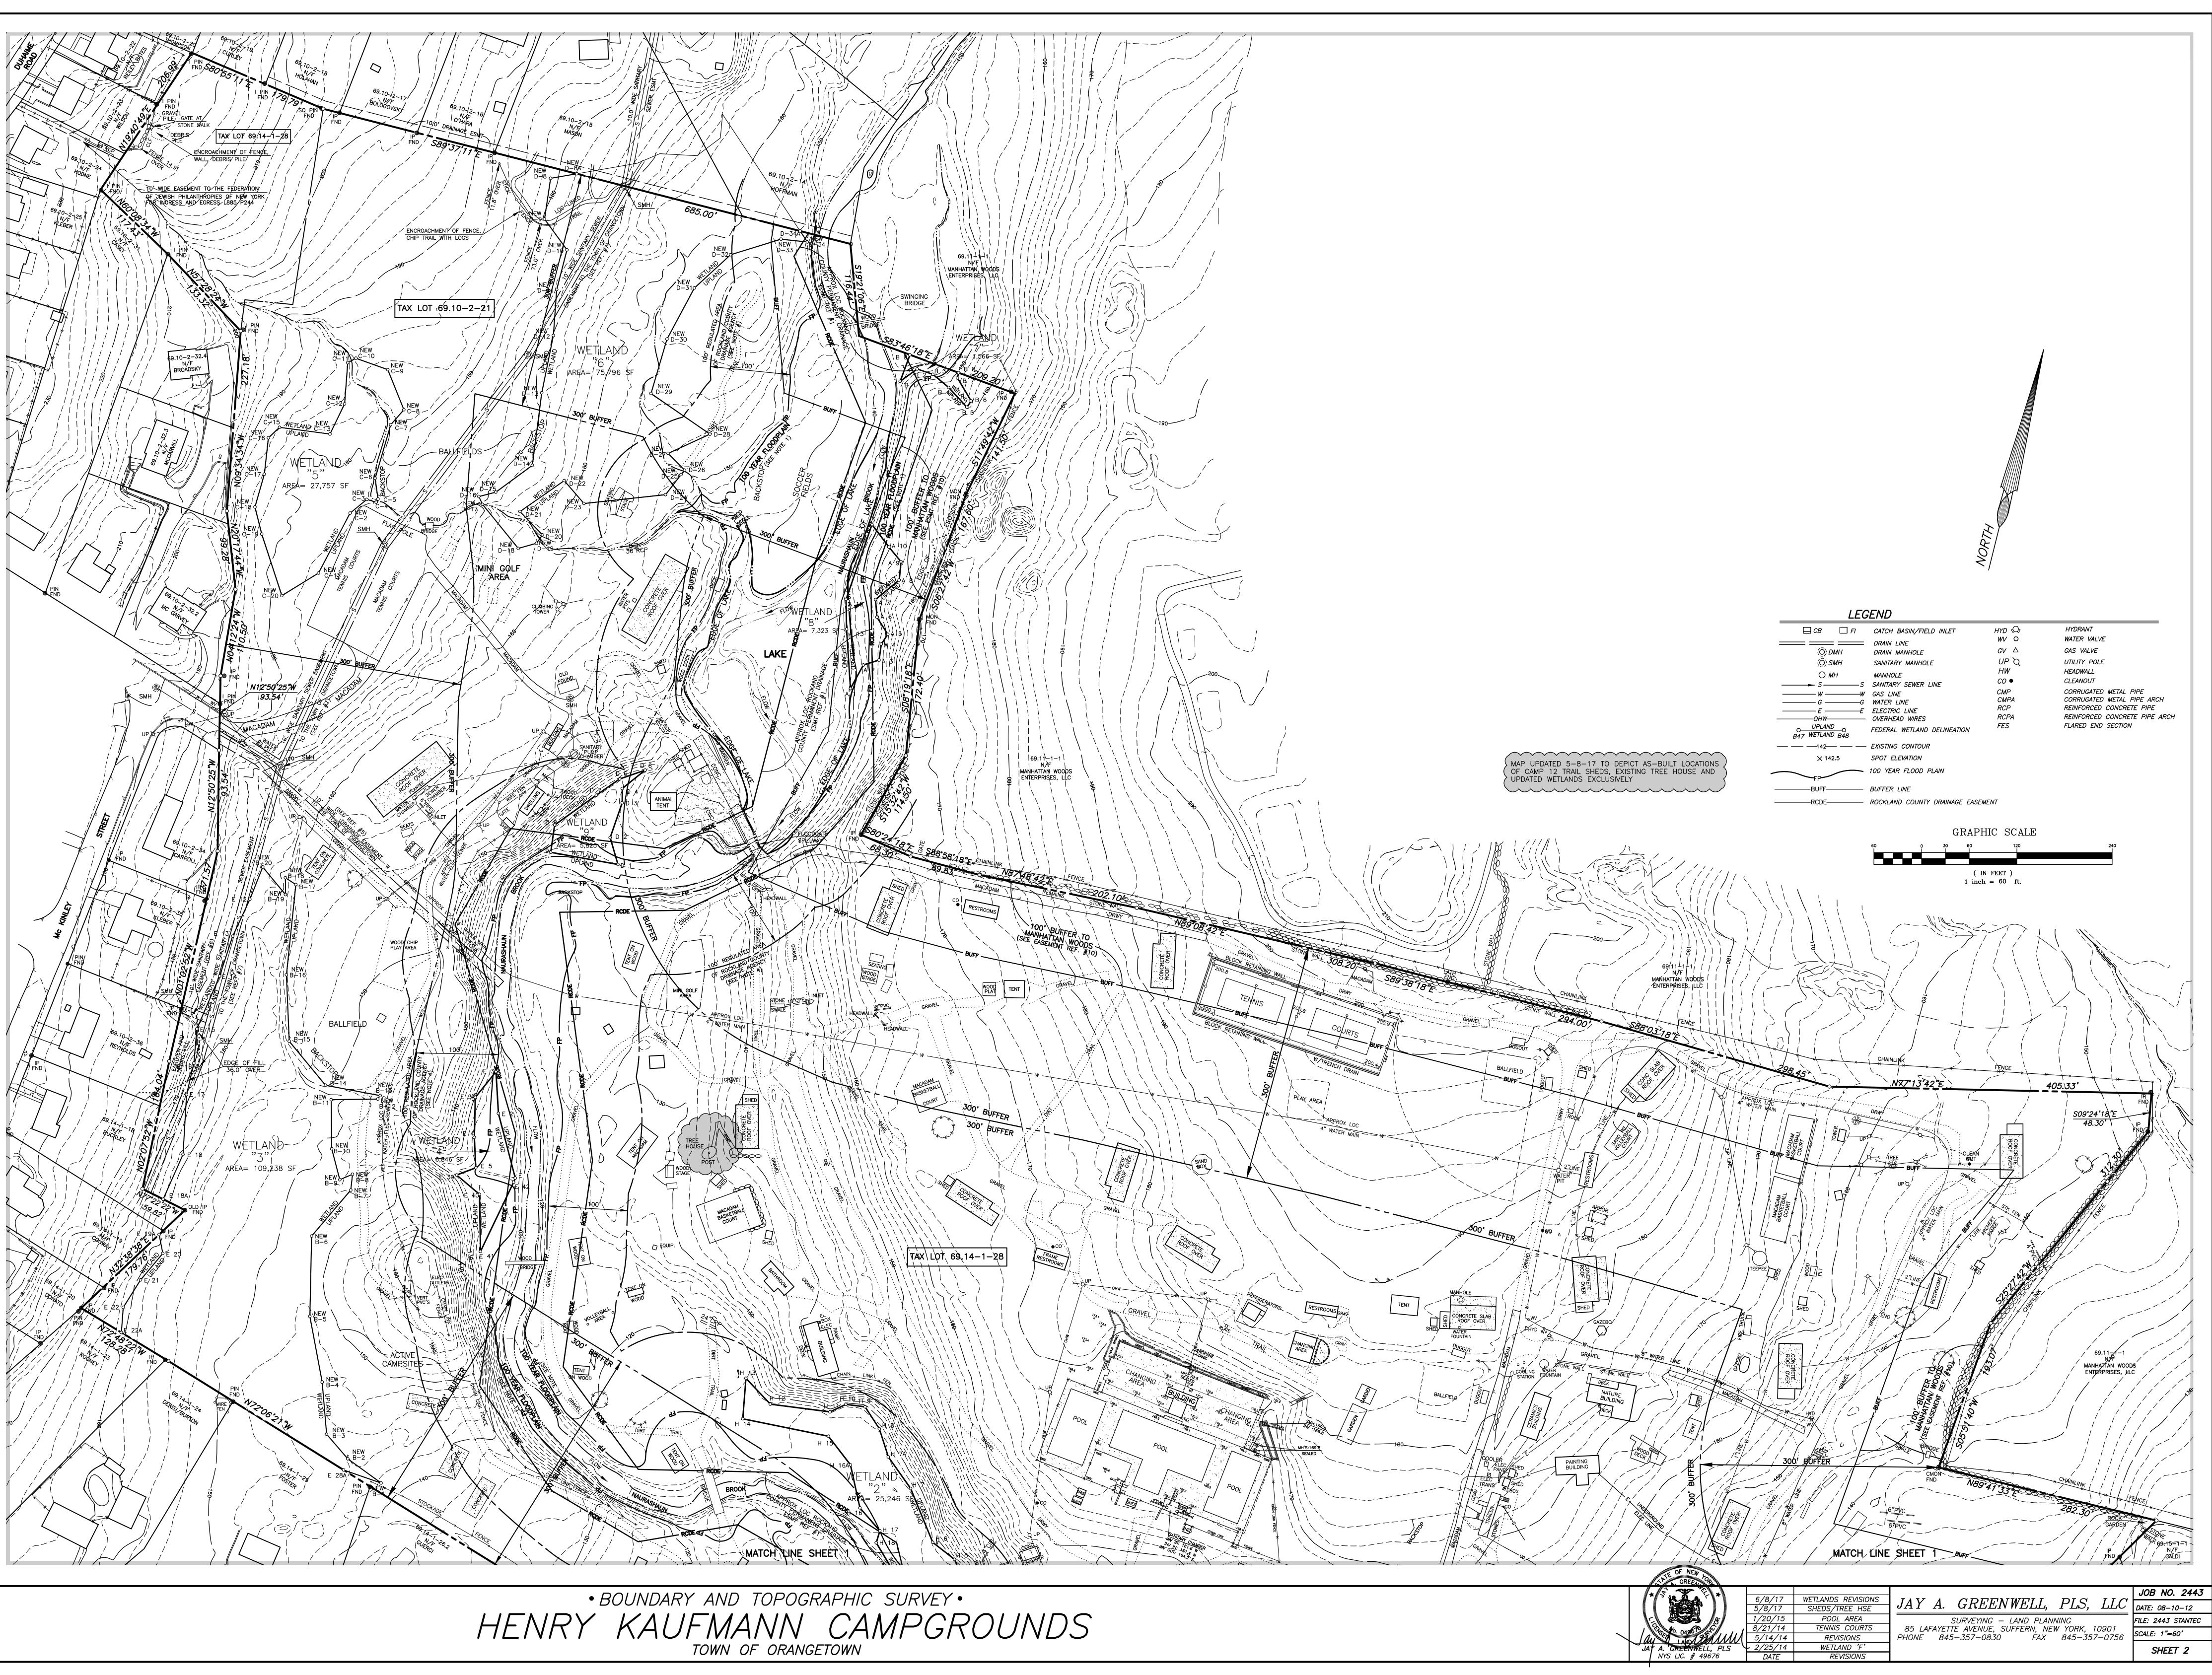



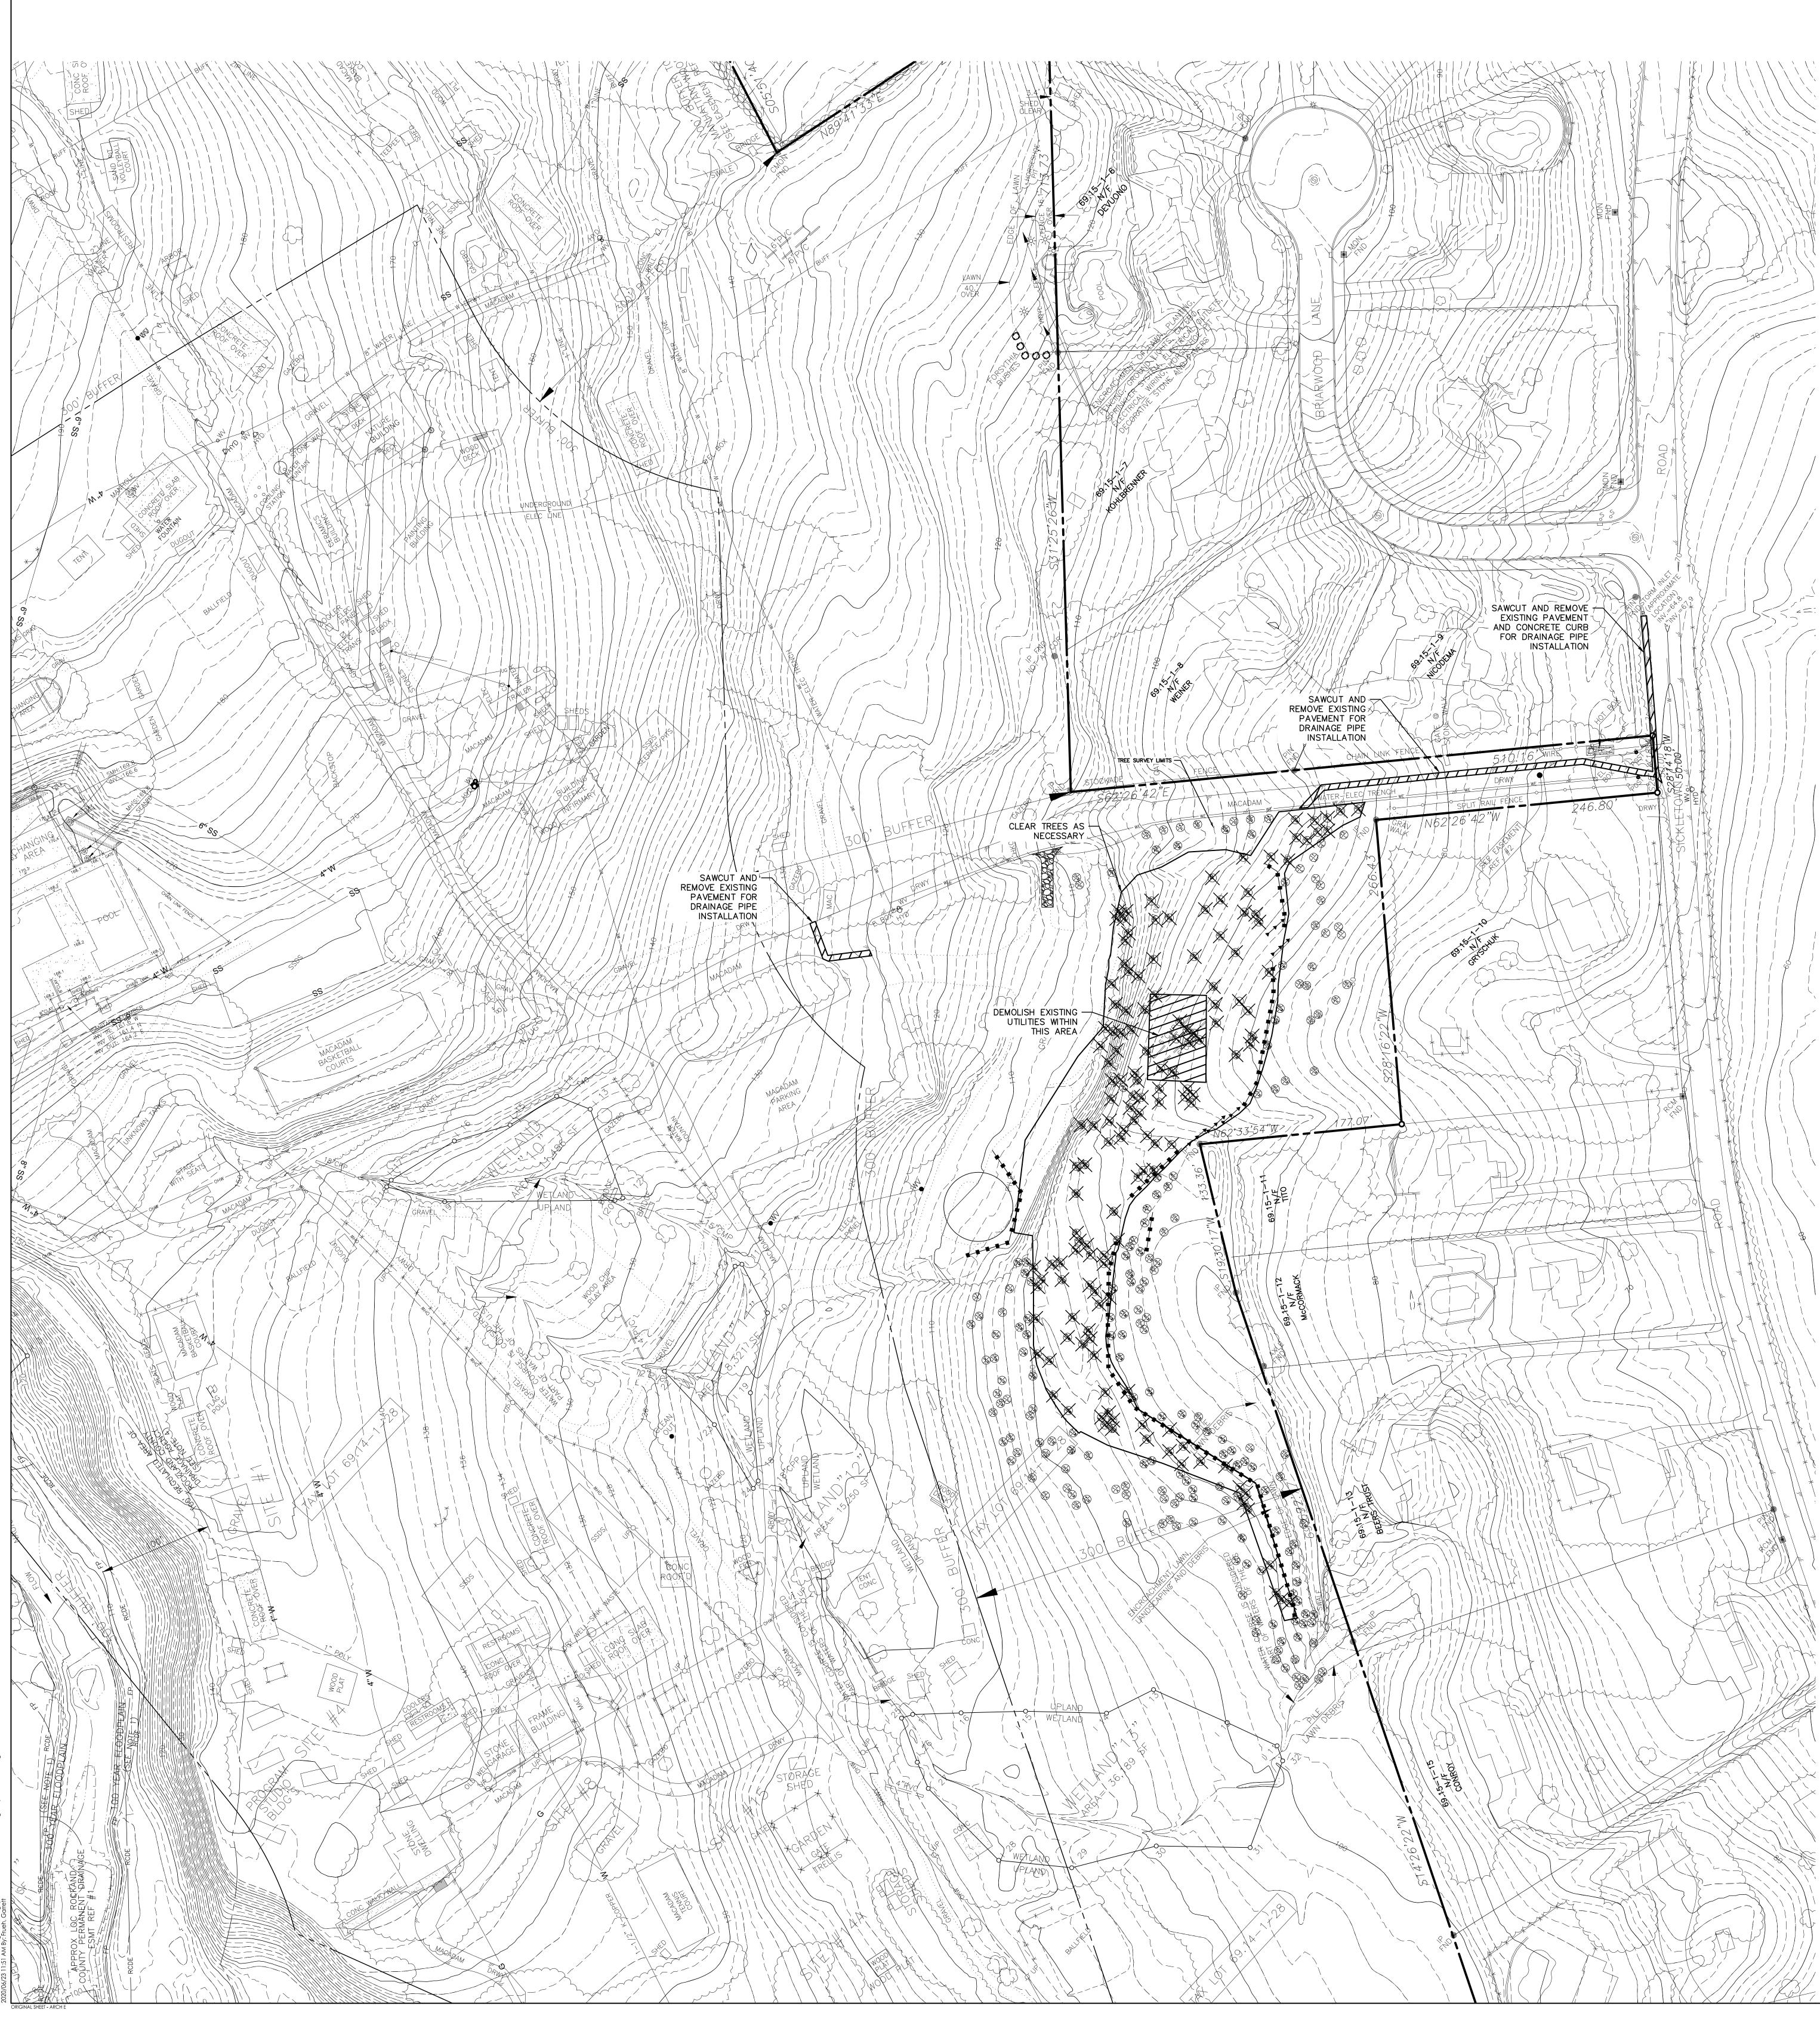

TREE LEGEN	D
1. EXISTING CONDITIONS A PLS, LLC, LAST UPDAT	ARE TAKEN FROM A SURVEY PREPARED BY STED AUGUST 2019.
K2 LETTER	INCHES (LARGEST DIA SHOWN IN TWIN/1 INDICATES TREE TYPE (SEE BELOW) NUMBER (2), (3) INDICATES TWIN/TRIPLI
	D BE REMOVED
BE = BEECH	W = WALNUT
LEGEND	
CB FI	CATCH BASIN/FIELD INLET
	DRAIN LINE
	DRAIN MANHOLE
(Õ) SMH	SANITARY MANHOLE
-	MANHOLE SANITARY SEWER LINE
И/И/ИИ	CAS LINE
G GG	
Е — ЕЕ ОНW	ELECTRIC LINE OVERHEAD WIRES
	FEDERAL WETLAND DELINEATION
142	EXISTING CONTOUR
× 142.5	SPOT ELEVATION
FP	100 YEAR FLOOD PLAIN
	BUFFER LINE
RCDE	ROCKLAND COUNTY DRAINAGE EASEMEN

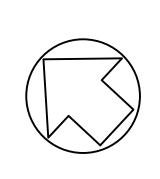



Stantec 475 Fifth Avenue 12th Floor New York, NY 10017-7239 www.stantec.com

Copyright Reserved

The Contractor shall verify and be responsible for all dimensions. DO NOT scale the drawing - any errors or omissions shall be reported to Stantec without delay. The Copyrights to all designs and drawings are the property of Stantec. Reproduction or use for any purpose other than that authorized by Stantec is forbidden.

Consultants

Legend

Notes

PROJECT BOUNDARY

KEY MAP N.T.S.

> GCF
> TAW
> 20.06.23
>
>
> GCF
> TAW
> 19.11.19
>
>
> GCF
> TAW
> 19.10.11
>
>
> GCF
> TAW
> 19.07.11
>
>
> By
> Appd.
> YY.MM.DD
> 4 REVISED PER TOWN COMMENTS **REVISIONS FOR SWPPP REVISED BASIN LAYOUT REVISED BASIN** Revision
> GCF
> TAW
> 20.06.23
>
>
> GCF
> TAW
> 19.11.06
>
>
> GCF
> TAW
> 19.10.11
>
>
> MJG
> TAW
> 19.09.16
>
>
> GCF
> TAW
> 19.07.11
>
>
> GCF
> TAW
> 19.04.25
>
>
> By
> Appd.
> YY.MM.DD
> 6 TOWN SUBMISSION town planning board submission 4 ISSUED TO CLIENT 3 TOWN SUBMISSION ISSUED TO CLIENT 1 TOWN SUBMISSION Issued
>
> File Name:
> Phase 1 Drainage Improvements.dwg GCF
> TAW
> GCF
> 19.04.25
>
>
> Dwn.
> Chkd.
> Dsgn.
> YY.MM.DD

Permit-Seal

Client/Project UJA FEDERATION OF NEW YORK

UJA Pearl River Day Camp Proposed Improvements Orangetown, New York

Title

EXISTING CONDITIONS & REMOVALS PLAN SW MANAGEMENT IMPROVEMENTS Project No. Scale 1''=50' 195115085 Drawing No. Sheet Revision

C-100-SW 4 of 10

_____ REPARED BY JAY A. GREENWELL,

OWN IN TWIN/TRIPLE) ⁻ BELOW) ES TWIN/TRIPLE

	HYD 🛇	HYDRANT
	$WV \bigcirc$	WATER VALVE
	$_{GV}$ \triangle	GAS VALVE
	UPQ	UTILITY POLE
	HW	HEADWALL
	<i>CO</i> •	CLEANOUT
	CMP	CORRUGATED METAL PIPE
	CMPA RCP	CORRUGATED METAL PIPE ARCH REINFORCED CONCRETE PIPE
	RCPA	REINFORCED CONCRETE PIPE ARCH
τιον	FES	FLARED END SECTION
		AREA OF PAVEMENT/UTILITY REMOVAL
	\bigcirc	AREA OF TREE CLEARING
	B-B-B	SILT FENCE
GE EASE	MENT	
	\longmapsto	STONE CHECK DAM
	\sim	STOCKPILED SOIL
	20/20/	GRAVEL
		0 50' 100'



ivil\design\drawing\plot\Pearl River\Phase 1 Drainage Improvement مالك المراجع ال

ORIGINAL SHEET - ARCH E



Stantec 475 Fifth Avenue 12th Floor New York, NY 10017-7239 www.stantec.com


Copyright Reserved

The Contractor shall verify and be responsible for all dimensions. DO NOT scale the drawing - any errors or omissions shall be reported to Stantec without delay. The Copyrights to all designs and drawings are the property of Stantec, Reproduction or use for any purpose other than that authorized by Stantec is forbidden.

Consultants

Legend

Notes

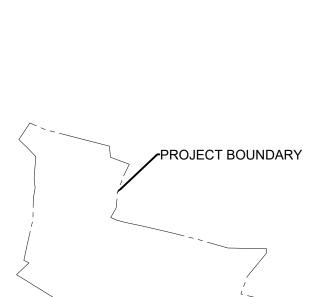

KEY MAP

				-
4	REVISED PER TOWN COMMENTS	GCF	TAW	20.06.23
3	REVISIONS FOR SWPPP	GCF	TAW	19.11.19
2	REVISED BASIN LAYOUT	GCF	TAW	19.10.11
1	REVISED BASIN	GCF	TAW	19.07.11
Re	evision	Ву	Appd.	YY.MM.DD
6	TOWN SUBMISSION	GCF	TAW	20.06.23
5	TOWN PLANNING BOARD SUBMISSION	GCF	TAW	19.11.06
4	ISSUED TO CLIENT	GCF	TAW	19.10.11
3	TOWN SUBMISSION	MJG	TAW	19.09.16
2	ISSUED TO CLIENT	GCF	TAW	19.07.11
1	TOWN SUBMISSION	GCF	TAW	19.04.25
SS	ued	Ву	Appd.	YY.MM.DD
File	Name: Phase 1 Drainage Improvements.dwg GCF	TAW	GCF	19.04.25

Dwn. Chkd. Dsgn. YY.MM.DD
Permit-Seal

ADDESSIONAL

Client/Project UJA FEDERATION OF NEW YORK

UJA Pearl River Day Camp Proposed Improvements Orangetown, New York

Title

SITE, DRAINA SW MANAG			
Project No.	Scale		
195115085]":	=30'	
Drawing No.	Sheet		Revision

C-200-SW 5 of 10

4



ivil\design\drawing\plot\Pearl River\Phase 1 Drainage Improvements.dwg



Stantec 475 Fifth Avenue 12th Floor New York, NY 10017-7239 www.stantec.com

Copyright Reserved


The Contractor shall verify and be responsible for all dimensions. DO NOT scale the drawing - any errors or omissions shall be reported to Stantec without delay. The Copyrights to all designs and drawings are the property of Stantec. Reproduction or use for any purpose other than that authorized by Stantec is forbidden.

Consultants

Legend

Notes

PROJECT BOUNDARY

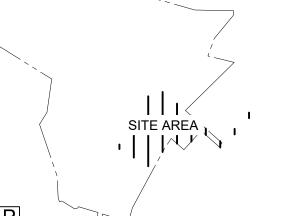

KEY MAP

4	REVISED PER TOWN COMMENTS	GCF	TAW	20.06.23
3	REVISIONS FOR SWPPP	GCF	TAW	19.11.19
2	REVISED BASIN LAYOUT	GCF	TAW	19.10.11
1	REVISED BASIN	GCF	TAW	19.07.11
Re	evision	Ву	Appd.	YY.MM.DD
6	TOWN SUBMISSION	GCF	TAW	20.06.23
5	TOWN PLANNING BOARD SUBMISSION	GCF	TAW	19.11.06
4	ISSUED TO CLIENT	GCF	TAW	19.10.11
3	TOWN SUBMISSION	MJG	TAW	19.09.16
2	ISSUED TO CLIENT	GCF	TAW	19.07.11
1	TOWN SUBMISSION	GCF	TAW	19.04.25
lss	ued	Ву	Appd.	YY.MM.DD
File	Name: Phase 1 Drainage Improvements.dwg GCF	TAW	GCF	19.04.25
	Dwp	Chkd	Dran	

Dwn. Chkd. Dsgn. YY.MM.DD Permit-Seal





Client/Project UJA FEDERATION OF NEW YORK

UJA Pearl River Day Camp Proposed Improvements Orangetown, New York

Title

	SEDIMENT CONTRO GEMENT IMPROVE	
Project No. 195115085	Scale 1''=30'	
Drawing No.	Sheet	Revision
C-300-SV	V 6 of 10	4

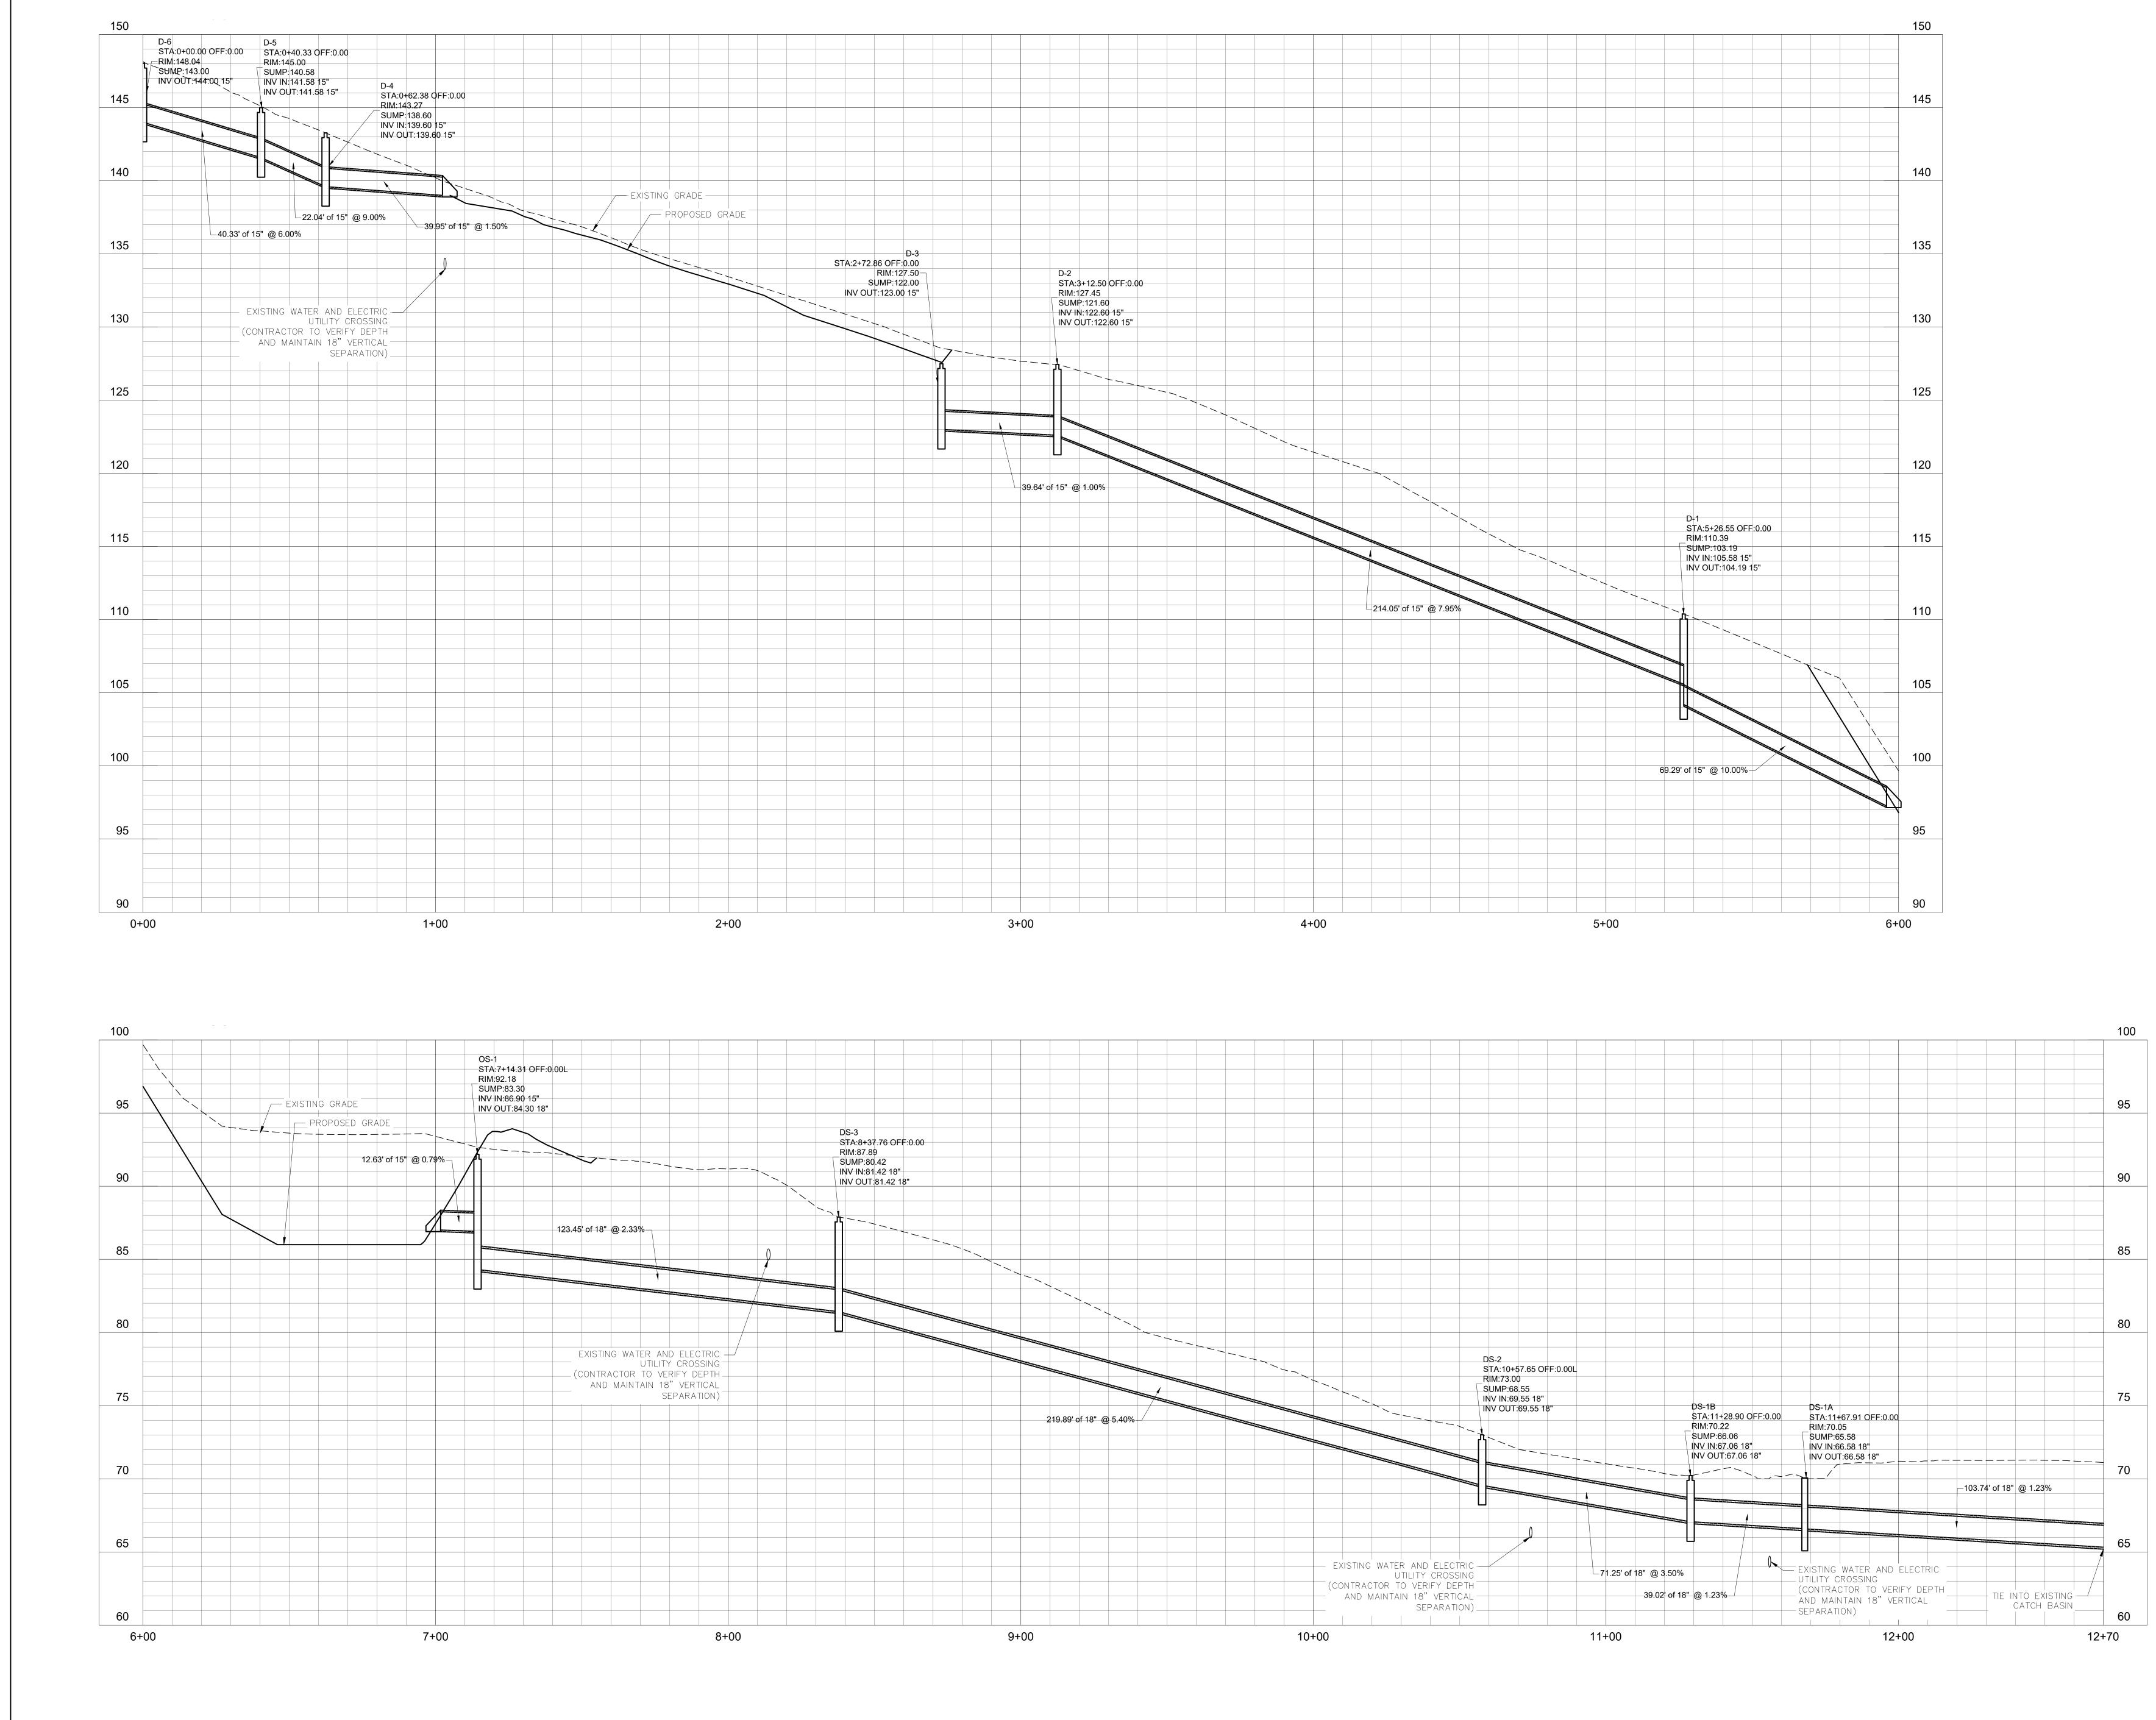

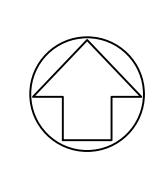



Stantec 475 Fifth Avenue 12th Floor New York, NY 10017-7239 www.stantec.com


Copyright Reserved

> The Contractor shall verify and be responsible for all dimensions. DO NOT scale the drawing - any errors or omissions shall be reported to Stantec without delay. The Copyrights to all designs and drawings are the property of Stantec. Reproduction or use for any purpose other than that authorized by Stantec is forbidden.

Consultants

Legend

Notes

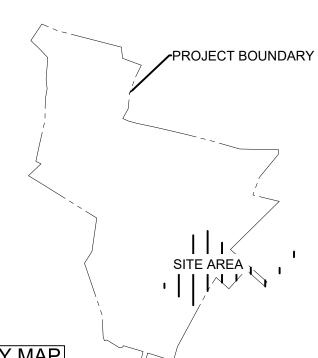

Lí

KEY MAP

4 REVISED PER TOWN COMMENTS	GCF	TAW	20.06.23
3 REVISIONS FOR SWPPP	GCF	TAW	19.11.19
2 REVISED BASIN LAYOUT	GCF	TAW	19.10.11
1 REVISED BASIN	GCF	TAW	19.07.11
Revision	Ву	Appd.	YY.MM.DD
6 TOWN SUBMISSION	GCF	TAW	20.06.23
5 TOWN PLANNING BOARD SUBMISSION	GCF	TAW	19.11.06
4 ISSUED TO CLIENT	GCF	TAW	19.10.11
3 TOWN SUBMISSION	MJG	TAW	19.09.16
2 ISSUED TO CLIENT	GCF	TAW	19.07.11
1 TOWN SUBMISSION	GCF	TAW	19.04.25
Issued	Ву	Appd.	YY.MM.DD
File Name: Phase 1 Drainage Improvements.dwg GCF	TAW	GCF	19.04.25

Client/Project UJA FEDERATION OF NEW YORK

UJA Pearl River Day Camp Proposed Improvements Orangetown, New York

Title


STORMWATER UTILITY PROFILES SW MANAGEMENT IMPROVEMENTS

Project No. Scale 1''=20' 195115085

Drawing No. Sheet C-400-SW

Revision

60

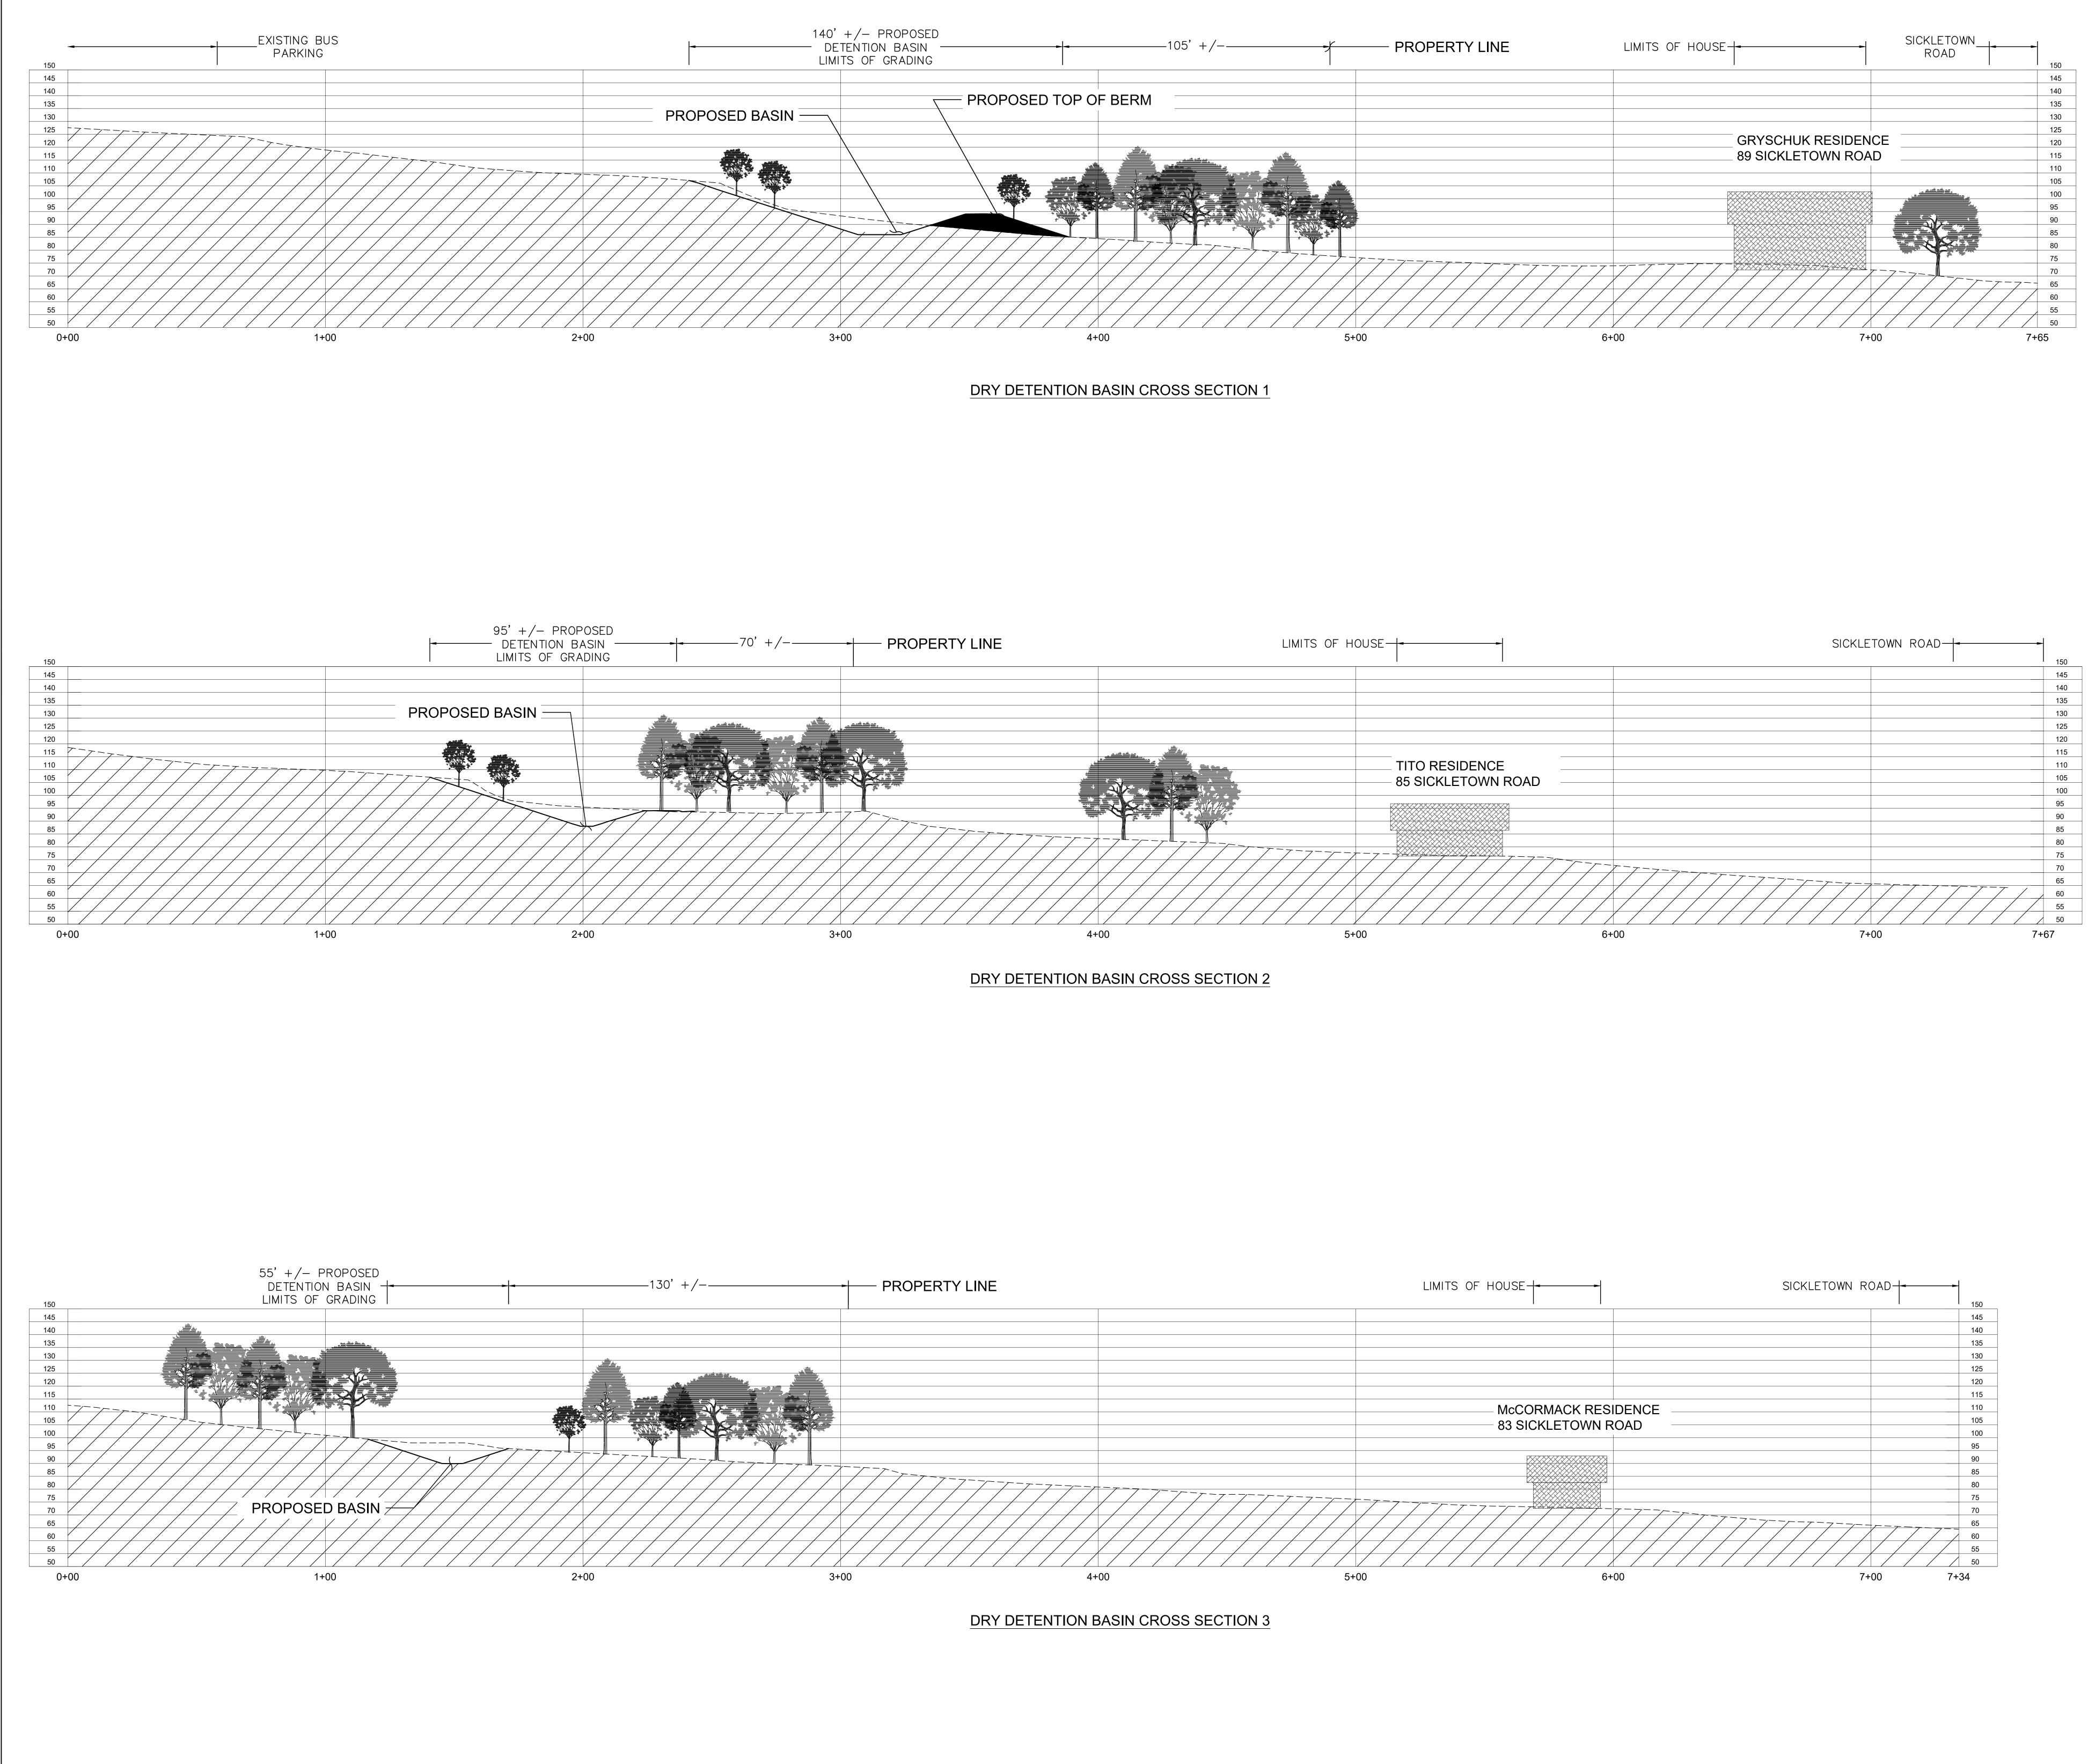

LIMITS OF HO	USE		SICKLETOWN ROAD	150
				145
				140
				135
				130 125
				120
				115
	TITO RESIDENCE			110
	—— 85 SICKLETOWN ROAD			105
				90
				85
				80
				75 70
				65
\square		////////////////////////////////////		55
5+0	/	6+00	7+00	<u> </u>



Stantec 475 Fifth Avenue 12th Floor New York, NY 10017-7239 www.stantec.com

Copyright Reserved

The Contractor shall verify and be responsible for all dimensions. DO NOT scale the drawing - any errors or omissions shall be reported to Stantec without delay. The Copyrights to all designs and drawings are the property of Stantec. Reproduction or use for any purpose other than that authorized by Stantec is forbidden.

Consultants

-

Legend


Notes

PROJECT BOUNDARY | | | | SITE AREA | | | |^\/' V KEY MAP Li'

4 REVISED PER TOWN COMMENTS	GCF	TAW	20.06.23
3 REVISIONS FOR SWPPP	GCF	TAW	19.11.19
2 REVISED BASIN LAYOUT	GCF	TAW	19.10.11
1 REVISED BASIN	GCF	TAW	19.07.11
Revision	By	Appd.	YY.MM.DD
6 TOWN SUBMISSION	GCF	TAW	20.06.23
5 TOWN PLANNING BOARD SUBMISSION	GCF	TAW	19.11.06
4 ISSUED TO CLIENT	GCF	TAW	19.10.11
3 TOWN SUBMISSION	MJG	TAW	19.09.16
2 ISSUED TO CLIENT	GCF	TAW	19.07.11
1 TOWN SUBMISSION	GCF	TAW	19.04.25
Issued	Ву	Appd.	YY.MM.DD
File Name: Phase 1 Drainage Improvements.dwg GCF		GCF	19.04.25
Dwn	. Chkd.	Dsgn.	YY.MM.DD
Client/Project			
UJA FEDERATION OF NEW	YORK		
UJA Pearl River Day Cam Proposed Improvements	р		
Orangetown, New York			
Title			
DRY DETENTION BASIN (SW MANAGEMENT IMF			
Project No. Scale 195115085 1''=20'			
Drawing No. Sheet		Revi	sion

C-401-SW	8 of 10	4

REEST	14	LIRIODE	NDRON TULIPIFERA	TULIP		1-1.5" C/	AL. B&	BA	AS SHOWN
>G >S	9		GLAUCA STROBUS		SPRUCE RN WHITE PINE	8'-10' HE 8'-10' HE	EIGHT B&		AS SHOWN AS SHOWN
QA QM	13 13		JS ALBA JS MONTANA	WHITE CHESTI	OAK NUT OAK	1-1.5" CA 1-1.5" CA			AS SHOWN AS SHOWN
TT Seed M	12 1IXES	TILIA T	OMENTOSA 'STERLING'	SILVER	LINDEN	1-1.5" C/	AL. B &	B A	AS SHOWN
STRA PURI DIRE 2. APPI 3. PRO' MININ	ATEGICALL POSES. TI CTION OF LY SEED VIDE TEMI MUM OF \$ <i>LEGE</i>	DF THE F HE CONT THE LA MIX DUR PORARY 5H; REFI	PLANT SCREENING AT THE ED NATIVE PLANTS. THE Q RACTOR SHALL FIELD LOC NDSCAPE ARCHITECT. ING THE SEASON AND AT IRRIGATION (15 GALLON M LL ONCE PER WEEK; GATC	UANTITIES AND GENER ATE PLANTS, AVOIDING A RATE RECOMMENDE IN. SLOW RELEASE WA	AL LOCATIONS OF THE PI G EXISTING UNDERSTORY " D BY THE SUPPLIER. TERING BAG WITH MULTIP	LANTINGS HA VEGETATION , LE RELEASE S UNTIL ESTA	VE BEEN SHOW and trees, wi points per b/	IN FOR BIDDIN TH THE OVERS	SITE AND
	(<u>Õ</u>) DMH	,	DRAIN LINE DRAIN MANHOLE	142		$GV \Delta$	GAS VALVE		
	(Ô) SMH ○ MH		SANITARY MANHOLE	× 142.5	SPOT ELEVATION — 100 YEAR FLOOD PLAIN	UP Q HW	UTILITY POLE HEADWALL		
	— W ——	W	SANITARY SEWER LINE WATER LINE	BUFF	BUFFER LINE	CO ● CMP CMPA	CLEANOUT CORRUGATED N CORRUGATED N	IETAL PIPE IETAL PIPE ARCI	Н
	— G —— — E —— —OHW——	——Е	GAS LINE ELECTRIC LINE OVERHEAD WIRES	RCDE	ROCKLAND COUNTY DRAINAGE EASEMENT	RCP RCPA	REINFORCED CO		
TR	EE LE					FES	FLARED END S.		
	STING COND S, LLC, LAS	EEN TREE ITIONS ARI T UPDATEL SIZE IN IA LETTER IN SECOND N		N TWIN/TRIPLE) WW)					
PLS 12- K2- K2- K2- A B B C C N E H IW	STING COND S, LLC, LAS	ORY TREE SED EEN TREE ITIONS ARI T UPDATEL SIZE IN IN SECOND N TREE TO JT RRY	E TAKEN FROM A SURVEY PREPA D AUGUST 2019. NCHES (LARGEST DIA SHOWN II DICATES TREE TYPE (SEE BELC IUMBER (2), (3) INDICATES TW	N TWIN/TRIPLE) WW)					
PLS 12- K2- K2- K2- A B B C C N E H IW	STING COND STING COND S, LLC, LAS = ASH = BIRCH = BEECH = CHERRY = CHESTNO = ELM = HACKBED = IRONWOO	ORY TREE SED EEN TREE ITIONS ARI T UPDATEL SIZE IN IN SECOND N TREE TO JT RRY	E TAKEN FROM A SURVEY PREPAR AUGUST 2019. NCHES (LARGEST DIA SHOWN II DICATES TREE TYPE (SEE BELC IUMBER (2), (3) INDICATES TW BE REMOVED P = PINE PL = POPLAR M = MAPLE K = OAK T = TULIP S = SYCAMORE W = WALNUT	N TWIN/TRIPLE) WW)					
PLS 12- K2- K2- K2- A B B C C N E H IW	STING COND STING COND S, LLC, LAS = ASH = BIRCH = BEECH = CHERRY = CHESTNO = ELM = HACKBED = IRONWOO	ORY TREE SED EEN TREE ITIONS ARI T UPDATEL SIZE IN IN SECOND N TREE TO JT RRY	E TAKEN FROM A SURVEY PREPAR AUGUST 2019. NCHES (LARGEST DIA SHOWN II DICATES TREE TYPE (SEE BELC IUMBER (2), (3) INDICATES TW BE REMOVED P = PINE PL = POPLAR M = MAPLE K = OAK T = TULIP S = SYCAMORE W = WALNUT	N TWIN/TRIPLE) WW)					
PLS 12- K2- K2- K2- K2- A B B C C N E H IW	STING COND STING COND S, LLC, LAS = ASH = BIRCH = BEECH = CHERRY = CHESTNO = ELM = HACKBED = IRONWOO	ORY TREE SED EEN TREE ITIONS ARI T UPDATEL SIZE IN IN SECOND N TREE TO JT RRY	E TAKEN FROM A SURVEY PREPAR AUGUST 2019. NCHES (LARGEST DIA SHOWN II DICATES TREE TYPE (SEE BELC IUMBER (2), (3) INDICATES TW BE REMOVED P = PINE PL = POPLAR M = MAPLE K = OAK T = TULIP S = SYCAMORE W = WALNUT	N TWIN/TRIPLE) WW)					
PLS 12- K2- K2- K2- K2- A B B C C N E H IW	STING COND STING COND S, LLC, LAS = ASH = BIRCH = BEECH = CHERRY = CHESTNO = ELM = HACKBED = IRONWOO	ORY TREE SED EEN TREE ITIONS ARI T UPDATEL SIZE IN IN SECOND N TREE TO JT RRY	E TAKEN FROM A SURVEY PREPAR AUGUST 2019. NCHES (LARGEST DIA SHOWN II DICATES TREE TYPE (SEE BELC IUMBER (2), (3) INDICATES TW BE REMOVED P = PINE PL = POPLAR M = MAPLE K = OAK T = TULIP S = SYCAMORE W = WALNUT	N TWIN/TRIPLE) WW)					
PLS 12- K2- K2- K2- K2- A B B C C N E H IW	STING COND STING COND S, LLC, LAS = ASH = BIRCH = BEECH = CHERRY = CHESTNO = ELM = HACKBED = IRONWOO	ORY TREE SED EEN TREE ITIONS ARI T UPDATEL SIZE IN IN SECOND N TREE TO JT RRY	E TAKEN FROM A SURVEY PREPAR AUGUST 2019. NCHES (LARGEST DIA SHOWN II DICATES TREE TYPE (SEE BELC IUMBER (2), (3) INDICATES TW BE REMOVED P = PINE PL = POPLAR M = MAPLE K = OAK T = TULIP S = SYCAMORE W = WALNUT	N TWIN/TRIPLE) WW)					

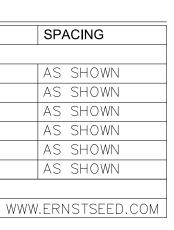

TONAL, 8 bidding 8 oversite and





Stantec 475 Fifth Avenue 12th Floor New York, NY 10017-7239 www.stantec.com

Copyright Reserved

The Contractor shall verify and be responsible for all dimensions. DO NOT scale the drawing - any errors or omissions shall be reported to Stantec without delay. The Copyrights to all designs and drawings are the property of Stantec. Reproduction or use for any purpose other than that authorized by Stantec is forbidden.

Consultants

Legend

Notes

PROJECT BOUNDARY | | | / ' SITE AREA | | | / ' ` ' '

Li'

KEY MAP

4	REVISED PER TOWN COMMENTS	GCF	TAW	20.06.23
3	REVISIONS FOR SWPPP	GCF	TAW	19.11.19
2	REVISED BASIN LAYOUT	GCF	TAW	19.10.11
1	REVISED BASIN	GCF	TAW	19.07.11
Revision		By	Appd.	YY.MM.DD
6	TOWN SUBMISSION	GCF	TAW	20.06.23
5	TOWN PLANNING BOARD SUBMISSION	GCF	TAW	19.11.06
4	ISSUED TO CLIENT	GCF	TAW	19.10.11
3	TOWN SUBMISSION	MJG	TAW	19.09.16
2	ISSUED TO CLIENT	GCF	TAW	19.07.11
1	TOWN SUBMISSION	GCF	TAW	19.04.25
Issued		Ву	Appd.	YY.MM.DD
File	Name: Phase 1 Drainage Improvements.dwg GC	CF TAW	GCF	19.04.25
TIIC			Dsgn.	YY.MM.DD
Pe	rmit-Seal	II. CIIKU.	Dsgn.	

Client/Project

UJA FEDERATION OF NEW YORK

UJA Pearl River Day Camp Proposed Improvements Orangetown, New York

Title

Drawing No. Sheet

LANDSCAPE PLAN SW MANAGEMENT IMPROVEMENTS

roject No.	Scale
195115085	1''=30'

Revision

C-500-SW 9 of 10

