Town of Orangetown Planning Board Planning Board Meeting: Tuesday, April 7, 2020

Location: Town of Orangetown, Greenbush Auditorium, 20 South Greenbush Road, Orangeburg, New York Time: 7:30 P.M.

Project Name: Instrumentation Laboratory Site Plan

Location of Parcel: The site is located at 526 Route 303, in the Route 303 Overlay Zone, Orangeburg, Town of Orangetown, Rockland County, New York, and as shown on the Orangetown Tax Map as Section 70.19, Block 1, Lot 45 in the LO zoning district.

Distribution:

Rockland County:

- Planning Department
- Highway Department
- Park Commission
- Environmental Resources
- Drainage Agency
- Health Dept.

Town of Orangetown:

- Drainage Consultant
- OBZPA
- DEME
- Highway
- DTA
- Fire Prevention
- Traffic Advisory Board

Other:

- New York State Department of Transportation: Permits
- Orange and Rockland Utilities
- Suez

Project Description: Final Site Plan Review

Please forward your completed review to this office by date of the Meeting. If your comments are not received by this date, the Board assumes your agency does not have any comments.

Town of Orangetown 20 South Greenbush Road Orangeburg, New York 10962

Planning Board Meeting of April 7, 2020

Project Name: Instrumentation Laboratory Site Plan

Location of Parcel: The site is located at 526 Route 303, in the Route 303 Overlay Zone, Orangeburg, Town of Orangetown, Rockland County, New York, and as shown on the Orangetown Tax Map as Section 70.19, Block 1, Lot 45 in the LO zoning district.

Please review the information enclosed and provide comments. These comments may be mailed, e-mailed or faxed to the Planning Board Office.

If your agency does not have any comments at this time, please respond to this office by sending back this sheet.

U.S. Postal: 20 South Greenbush Road, Orangeburg, New York 10962
Email to Planning Board at coopersmith@orangetown.com, or
Fax to the Town of Orangetown Planning Board @845 359-8526
() Comments Attached (or to be provided prior to Meeting date noted above)
() No Comments at this time. Please send future correspondence for review.
() No future correspondence for this site should be sent to this agency. Plans reviewed and this agency does not have any further comments.
() This project is out of the jurisdiction of this agency and has no further comments.

Dated:

Agency Name
By:

Please Print Name

Name of Municipality: <u>TOWN OF ORANGETOWN</u>

Date Submitted: 2 36/2020

2019 LAND USE BOARD APPLICATION

Diagonal and all	
Please check all tCommercial Planning Board Zoning Board of Appeals	Residential Historical Board
SubdivisionNumber of LotsSite PlanConditional UseSpecial PermitVariance	Consultation Pre-Preliminary/Sketch Preliminary ☑ Final Interpretation
Performance Standards Review Use Variance Other (specify):	PERMIT#: ASSIGNED INSPECTOR: Referred from Planning Board: YES / NO if yes provide date of Planning Board meeting:
Project Name:Instrumentation Laboratory	- Expansion
Street Address: 526 Route 303	
Orangeburg, NY 10962	
Tax Map Designation: Section: 70.19 Block: Block: Section: Block: Directional Location:	1 Lot(s): 45 Lot(s):
On theside ofRoute 303 Of the intersection Town of OPANICETOWN in the latter in the la	, approximately of, in the
in the namiet/village of	Blauveit
Acreage of Parcel 8.817 School District South Orangetown	Zoning District LO Postal District Orangeburg
Ambulance District South Orangetown	Fire District Orangeburg
Water District Suez	Sewer District Orangetown
Acreage of Parcel 8.817 School District South Orangetown Ambulance District South Orangetown Water District Suez	Zoning District LO Postal District Orangeburg Fire District Orangeburg Sewer District Orangetown
Project Description: (If additional space required, plea Building and parking expansion and approval of accessory st	
he undersigned agrees to an extension of the statutopy time li	mit for scheduling a public hearing.
late: 52910 Applicant's Signature: All market	W KINIA

APPLICATION REVIEW FORM

	Instrumentation L	aboratory	Pho	ne # <u>845-365-80</u>	00
Address:	526 Route 303 Street Name & Number	(Post Office)	Orangeburg City	NY State	10962 Zip Code
Property Own	er:Instrumentation	on Laboratory	Pho	ne #845-365-	8000
Address:	526 Route 303 Street Name & Number	(Post Office)	Orangeburg City	NY State	10962 Zip Code
Engineer/Arch	nitect/Surveyor: _	El Assoc	iates	Phone #	973-775-7777
Address:	8 Ridgedale Ave		Cedar Knolls	NJ	07927
	Street Name & Number	(Post Office)	City	State	Zip Code
Attorney:	Donald Brenner		Phone #	845-359-2210	
Address:	4 Independ Street Name & Number	ence Ave	Tappan City	NY	10983
	Street Name & Number	(Post Office)	City	State	Zip Code
	n: <u>Donald Brenr</u>		Phone #	845-359-2210	
Address:	4 Independ Street Name & Number	fence Ave (Post Office)	Tappan City	NY State	10983 Zip Code
IF ANY ITEM IS PLANNING State of Long F Munici	CHECKED, A REVIEW UNDER THE STATE	(Post Office) RAL MUN This propert (Check EW MUST BE E GENERAL	City IICIPAL LAW y is within 500 fer k all that apply) DONE BY THE RO MUNICIPAL LAW, State Cour	State / REVIEW: et of:	Zip Code Zip Code
IF ANY ITEM IS PLANNING State of Long F Munici	CHECKED, A REVIEW OF COUNTY ROAD Path pal Boundary	(Post Office) RAL MUN This propert (Check EW MUST BE E GENERAL	City IICIPAL LAW y is within 500 fer k all that apply) DONE BY THE RO MUNICIPAL LAW, State Cour	REVIEW: et of: CCKLAND COUNTY SECTIONS 239 L or County Park hty Stream	Zip Code COMMISSIONER OF
IF ANY ITEM IS PLANNING State of Long F Munici	CHECKED, A REVIEW UNDER THE STATE OF County Road Path pal Boundary facility checked about	(Post Office) RAL MUN This propert (Check EW MUST BE E GENERAL	City IICIPAL LAW y is within 500 fer k all that apply) DONE BY THE RO MUNICIPAL LAW, State Cour	REVIEW: et of: CCKLAND COUNTY SECTIONS 239 L or County Park hty Stream	Zip Code Zip Code



TELEPHONE (973) 775-7777 FACSIMILE (973) 775-7770 E-MAIL: info@eiassociates.com

February 25, 2020 EG 8381.00

Donald Brenner, P.E., LL.B 4 Independence Avenue Tappan, New York 10983 (845) 359-2210

Subject:

Permit # 48870

Building and Parking Addition - Final Site Plan Documents

Instrumentation Laboratory, Inc.

526 Route 303

Town of Orangetown, Rockland County, NY

Dear Mr. Brenner:

Enclosed please find the following documents for the above referenced project application:

1. Three (3) signed and sealed copies of the following drawings:

<u>Dwg. No.</u>	<u>Title</u>	Rev.	<u>Date</u>
CT01	Title Sheet	H	2-25-2020
C01	Existing Conditions & Site Demolition Plan	H	2-25-2020
C02	Site Plan	H	2-25-2020
C03	Site Improvement Details	\mathbf{H}	2-25-2020
C04	Grading and Drainage Plan	Η	2-25-2020
C04.1	Drainage Profiles	H	2-25-2020
C05	Drainage Details	H	2-25-2020
C06	Site Lighting Plan	H	2-25-2020
C07	Landscape Plan and Details	H	2-25-2020
C08	Soil Erosion Control Plan	\mathbf{H}	2-25-2020
C09	Erosion Control Details & Notes	Н	2-25-2020

2. Two (2) signed and sealed copies of the Stormwater Pollution Prevention Plan (SWPPP), dated February 25, 2020.

The enclosed documents have been revised in accordance with the July 31, 2019 Conditions of the Preliminary Site Plan Approval as outlined below.

- 1. General Note #1 has been added to Drawing No. CT01.
- 2. General Note #2 has been added to Drawing No. CT01.
- 3. General Note #3 has been added to Drawing No. CT01.
- 4. The Landscaped Berm Section, Detail #4, on Drawing No. 7 has been revised to indicate a berm height of 3'-9". The berm has been extended southward toward the main entrance from Route 303 and an additional berm is shown on the south side of the main entrance. These berm modifications are reflected by the proposed contours shown on drawing No. C04 and C07.

Donald Brenner, P.E., LL.B Permit # 48870 Building and Parking Addition – Final Site Plan Documents Instrumentation Laboratory, Inc. February 25, 2020 Page 2 of 4

- 5. Drawing No. C02 has been updated to show the existing building dimensions, existing building setback distances, easement lines, bearings and distances and survey reference notes.
- 6. The Zoning Data Table on Drawing No. CT01 has been updated to agree with the dimensions shown on Drawing C01 and C02 for the existing and proposed rear yard setback.
- 7. Zoning variance granted at November 16, 2019 public hearing and noted on Drawing CT01 under "Planning & Land Development Approval Notes".
- 8. Zoning variance granted at November 16, 2019 public hearing and noted on Drawing CT01 under "Planning & Land Development Approval Notes".
- 9. Zoning variance granted at November 16, 2019 public hearing and noted on Drawing CT01 under "Planning & Land Development Approval Notes".
- 10. Parking is not proposed within a drainage easement.
- 11. Building mounted site lighting has been added to Drawing No. C06.
- 12. Floor Plans have been previously submitted. Zoning Board Performance Standards Review has been approved.
- 13. Building Elevation Drawings have been previously submitted.
- 14. ACABOR approval was granted on February 6, 2020.
- 15. See attached SWPPP, dated 2-25-2020.
- 16. See attached SWPPP, dated 2-25-2020.
- 17. See attached SWPPP, dated 2-25-2020. The existing culvert under the main driveway must be replaced.
- 18. See Appendix F of the SWPPP for the geotechnical investigation.
- 19. A forebay has been added to the detention basin.
- 20. The area of soil disturbance is listed on Drawing No. C08 and in the SWPPP.
- 21. Additional drainage inlets have been added to the northern parking area.
- 22. Profiles of the detention basin have been added to Drawing No. C04.1.
- 23. The maintenance access path for the detention basin is shown on Drawing No. C04.
- 24. The drainage collection system within the existing paved parking lot has been modified as well as the drainage system downstream of the detention basin.
- 25. Drawing No. C08 will be revised to utilize the standard NYSDEC soil erosion control symbols.
- 26. The limit of soil disturbance occurs within the limits if the property.
- 27. Stormwater profiles are shown on Drawings No. C04.1.
- 28. A copy of the draft maintenance and easement agreement is provided in Appendix D of the SWPPP.
- 29. We have requested the reference datum and bench mark information from the survey, which will be added to the plan.
- 30. Brooker Engineering Comments:
 - 1. No net increase in runoff, therefore, no change required.
 - 2. The stormwater culvert and open channel south of the detention basin is currently undersized for the existing conditions and is proposed to be modified to convey existing and proposed peak runoff rates.
 - 3. The culvert underneath the main driveway will be replaced.

Donald Brenner, P.E., LL.B Permit # 48870 Building and Parking Addition - Final Site Plan Documents Instrumentation Laboratory, Inc. February 25, 2020 Page 3 of 4

- 4. The swale on the east side of the landscape berm will drain to a new storm inlet south of the detention basin.
- 5. The grading and drainage east of the existing and proposed loading dock has been revised to provide a minimum slope of 1% to storm drainage inlets.
- 6. The grading and drainage east of the existing and proposed loading dock has been revised to provide a minimum slope of 1% to storm drainage inlets
- 7. Refer to Appendix F of the SWPPP for the geotechnical investigation.
- 8. The Hydraflow routing calculations contained in Appendix C of the SWPPP contains a Pond Report with the stage/storage/discharge tabulation.
- 31. Rockland County Department of Planning Comments:
 - 1. Plans and SWPPP will be submitted to NYSDOT for review.
 - 2. Plans and SWPPP will be submitted to Rockland County Department of Health for review.
 - 3. Drawing No. C08 and C09 have been prepared in accordance with the NYSDEC Soil Erosion control Standards.
 - 4. There is no net increase in peak runoff rate.
 - 5. Drawing No. C06 provided a point by point site lighting analysis.
 - 6. Plans were approved by Zoning Board for the Route 303 Overlay Zone District.
 - 7. The parking layout has been revised to provide 313 spaces.
 - 8. Snow removal area have been shown on drawing No. C07.
- 32. Rockland County Highway Department Comment:
 - 1. The SWPPP will be submitted for review.
- 33. An application will be submitted to the Rockland County Health Department for review of the SWPPP.
- 34. Rockland County Sewer District 31 had no comments.
- 35. Town of Orangetown Bureau of Fire Prevention comments:
 - 1. The parking aisle on the north side of the building addition was revised to be 26-feet wide.
 - 2. The fire truck circulation is illustrated on Drawing No. C07.
 - 3. Building Plans will be submitted to the Bureau of Fire Prevention to address the proposed interior use, fire sprinkler coverage, fire alarms and emergency lighting, exit signs and egress.
- 36. Rockland County Drainage Agency (RCDA) review is not required.
- 37. Planning Board is lead agency.
- 38. Applicant will comply with conditions of Final Site Plan approval.
- 39. The Planning & Land Development Approval Notes listed on Drawing No. CT01 will be updated as agency approvals are received.
- 40. Tree Protection Notes have been added to Drawing No. C01.
- 41. See Landscape Notes on Drawing No. C07.
- 42. See Soil Erosion Control Notes on Drawing No. C08.
- 43. See General Notes on Drawing No. CT01.
- 44. See General Notes on Drawing No. CT01.
- 45. See Soil Erosion Control Notes on Drawing No. C08.
- 46. See General Notes on Drawing No. CT01.
- 47. See General Notes on Drawing No. CT01.

Donald Brenner, P.E., LL.B
Permit # 48870
Building and Parking Addition – Final Site Plan Documents
Instrumentation Laboratory, Inc.
February 25, 2020
Page 4 of 4

48. See General Notes on Drawing No. CT01.

If you have any questions or require additional information, please contact the undersigned at robert_walsh@eiassociates.com or (908) 720-4553.

Sincerely yours, EI Associates

Robert E. Walsh, PE, PP

Chief Civil & Environmental Engineer

CC: Instrumentation Laboratory, Inc Attachments

ACABOR #19-51
Instrumentation Laboratories Plans
Approved as Presented

Permit #48870

Town of Orangetown – Architecture and Community Appearance Board of Review Decision February 6, 2020 Page 1 of 2

TO:

Donald Brenner, 4 Independence Avenue, Tappan, New York

10983

FROM:

Orangetown Planning Board

RE: Instrumentation Laboratory Plans: The application of Instrumentation Laboratory, owner, for the review of Site, Structure and Landscaping Plans at a site known as "Instrumentation Laboratory Plans", in accordance with Article 16 of the Town Law of the State of New York and Chapter 2 of the Code of the Town of Orangetown. The site is located at 526 Route 303, in the Route 303 Overlay Zone, Orangeburg, Town of Orangetown, Rockland County, New York, and as shown on the Orangetown Tax Map as Section 70.19, Block 1, Lot 45 in the LO zoning district.

Heard by the Architecture and Community Appearance Board of Review of the Town of Orangetown at a meeting held Thursday, February 6, 2020 at which time the Board made the following determinations:

Donald Brenner, Richard Basta, William Glaser and Randall Vlasak appeared and testified.

The Board received the following communications:

A. A Building Permit Referral dated May 8, 2019, prepared by Rick Oliver, Deputy Building Inspector.

- B. Copies of PB #18-06, Preliminary Site Plan Approval Subject to Conditions, dated December 12, 2018 and Zoning Board of Appeals #19-94, Variances Approved, dated November 6, 2019.
- C. Material Specification Sheet.
- **D.** Plans prepared by El Associates Architects and Engineers, dated April 10, 2018, last revised August 23, 2019, unless noted:
 - T01: Title Sheet
 - C01: Existing Conditions & Site Demolition Plan
 - C02: Site Plan
 - · C03: Site Improvement Details
 - C04: Grading & Drainage Plan & Drainage Profiles
 - C05: Drainage Details
 - C06: Site Lighting Plan
 - C07: Landscape Plan & Details
 - · C08: Soil Erosion Control Plan
 - C09: Soil Erosion Control Details & Notes
 - A30: Elevations, dated September 11, 2018, last revised
 September 11, 2019

 301430 S.NNETO NMOL
 - A11: First Floor Plan, dated September 11, 2018, last revised September 11, 2019 8€: 11 ♥ 21 833 €
 - A12: Second Floor Plan, dated May 28, 2019, last revised September 11, 2019

ACABOR #19-51 Instrumentation Laboratories Plans Approved as Presented

Permit #48870

Town of Orangetown – Architecture and Community Appearance **Board of Review Decision** February 6, 2020 Page 2 of 2

FINDINGS OF FACT:

- 1. The Board found that the applicant proposed to expand the existing parking facility and construct a building addition at an existing site. The façade of the building addition would be similar to the existing structure, in an EIFS system, or equal, in white, cream and tan colors. The roof would be a three ply built up roof in Tremco, or equal, in a similar color as the existing structure. The air conditioning units would be located on the roof of the building. The windows would have white trim with insulated tinted glazing. Parking Lot lighting would be as noted on the site plan.
- 2. The Board found that in the front of the Building, a retention pond would be construction with extensive planting along Route 303, as noted on the plan.

The hearing was then opened to the Public. There being no one to be heard from the public, the Public Hearing portion of the meeting was closed.

DECISION: In view of the foregoing and the testimony before the Board, the application was Approved as Presented.

The foregoing resolution was presented and moved by Brian Aitcheson and seconded by Shirley Goebel Christie and carried as follows: Christopher Dunnigan, Chair, aye; Shirley Goebel Christie, ave: Deborah Stuhlweissenburg, aye, Brian Aitcheson, aye, Kenyatta Jones Arietta, aye; Sharon Burke, absent and Joseph Milillo, absent.

The Clerk to the Board is hereby authorized, directed and empowered to sign this Decision and file a certified copy in the Office of the Town Clerk and the Office of the Architecture and Community Appearance Board of Review.

Dated: February 6, 2020

Cheryl Coopersmith

Cheryl Coopaintith Chief Clerk Boards and Commission

> TOWN CLERK'S OFFICE 2020 FEB 12 A II; 38 TOWN OF ORANGETOWN

DECISION

SECTION 13.10 B (14) ABOVE GROUND DETENTION WITHIN BUFFER, SECTION 5.224 PARKING IN FRONT YARD; REAR YARD, SECTION 5.22 YARDS SHALL BE UNOBSTRUCTED; SECTION 5.153 ACCESSORY STRUCTURE SHOULD BE 15' FROM PRINCIPAL STRUCTURE; VARIANCES APPROVED

To: Donald Brenner (Instrumentation Labs) 526 Route 303 Orangeburg, New York 10964 ZBA #19-94 Date: November 6, 2019 Permit # 48870

FROM: ZONING BOARD OF APPEALS: Town of Orangetown

ZBA# 19-94: Application of Instrumentation Laboratory Site Plan for variances from Zoning Code (Chapter 43) of the Town of Orangetown Code, LO District, Section 13.10 B (14): (In no case shall the above ground detention basin be sited within any buffer area or within any front yard setback area or within the designated street line), Section 5.224, Tuble 3.11, LO District, Column 7 #3 (No parking is permitted in any yard: parking is proposed in front yard), Section 3.11, Column 11 (Rear Yard; 100' required, 58' proposed) for the new 1-story addition at the south-west corner; Section 5.22 (All required yards shall be unobstructed. 100' rear yard setback required with 47.1' proposed to the existing wooden lean-to structure; and from Section 5.153 (No accessory structure shall be closer to any principal building or to any other accessory building or structure than a distance equal to the height of such accessory building or structure, and in no event less than 15 feet, unless it is attached to and is a part of such principal building: variance is required for wooden lean-to structure, 15' required, 14' proposed and to the pre-fab canopy over dumpster 15' required, 7.2' proposed) for site plan approval for Instrumentation Laboratory. The premises are located at 526 Route 303, Orangeburg, New York and are identified on the Orangetown Tax Map as Section 70.19, Block 1, Lot 45 in the LO zoning district.

Heard by the Zoning Board of Appeals of the Town of Orangetown at a meeting held on Wednesday, November 6, 2019 at which time the Board made the determination hereinafter set forth

Donald Brenner, Attorney, Robert Walsh, P.E., and Randy Vlasak, appeared and testified.

The following documents were presented:

- El Associates Architects & Engineers, PC plans labeled "Instrumentation Laboratory Orangeburg, NY Facility Expansion" dated May 29, 2019 with the last revision date of September 12, 2019 A11, A12, A30; signed and sealed by Richard F. Basta, Architect.
- El Associates Architects & Engineers, PA, dated April 10, 2018 with the latest revision date of August 23, 2019 labeled "Instrumentation Laboratory Building & Parking Addition" T01 C01, C02, C03, C04, C05, C06, C07, C08, C09 signed and sealed by Robert E. Walsh, P.E..
- 3. Planning Board Decision #19-45 dated July 31, 2019.
- Memorandums dated August 28, 2019 and July 12, 2019 from Jane Slavin, Architect, Director, OBZPAE, Orangetown.
- A letter dated October 2, 2019 from the Rockland County Department of Planning signed by Douglas J. Schuetz, Acting Director of Planning.
- A letter dated October 7, 2019 from the Rockland County Health Center for Environmental Health signed by Elizabeth Mello. P.E., Senior Public Health Engineer.

TOWN OF ORANGETOWN TOWN CLERK'S OFFICE

Permit #48870

 A letter dated September 23, 2019 from the Rockland County Highway Department signed by Dyan Rajasingham, Engineer III.

 A letter dated September 19, 2019 from the Rockland County Sewer District No. 1 signed by Joseph LaFiandra, Engineer II.

Mr. Sullivan, Chairman, made a motion to open the Public Hearing which motion was seconded by Ms. Castelli and carried unanimously.

On advice of Denise Sullivan, Deputy Town Attorney, counsel to the Zoning Board of Appeals, Mr. Sullivan moved for a Board determination that since the Planning Board noticed its intent to declare itself Lead Agency and distributed that notice of intention to all Involved Agencies, including the ZBA who consented or did not object to the Planning Board acting as Lead Agency for these applications, pursuant to coordinated review under the State Environmental Quality Review Act Regulations § 617.6 (b)(3); and since the Planning conducted SEQRA reviews and, on July 31, 2019 (as set forth in PB# 19-45Instrumentation Laboratory Site Plan) rendered environmental determinations of no significant adverse environmental impacts to result from the proposed land use actions (i.e. a "Negative Declarations" of "Neg Dec."), the ZBA is bound by the Planning Board's Neg Dec and the ZBA cannot require further SEQRA review pursuant to SEQRA Regulations § 617.6 (b)(3). The motion was seconded by Ms. Castelli and carried as follows: Mr. Quinn, aye; Ms. Salomon, aye; Ms. Castelli, aye; and Mr. Sullivan, aye. Mr. Bosco was absent.

Donald Brenner testified that this project has been before the Planning Board and received a preliminary approval and a neg dec; that the Rockland County Highway Department should not have jurisdiction because the property is not located on a county road; that this business has been there long before the Route 303 Overlay was created; that the parking has always existed in the front yard; that the proposed shed is for the worker that smoke to have a prace to go to do that; that they are proposing a cover-over the dumpster, and that he would request that the Board over ride #1 of Rockland County Planning's letter dated October 2, 2019.

Randy Vlasak testified that the business has been steadily growing; that they expect to have 90 new high tech scientific employees in the next ten years; that the cover over the dumpster was a suggestion from the EPA; that the shifts overlap and the parking is needed to accommodate the employees; and that the building was used as a scientific research building since 1973 and one of the previous tenants was Fischer Diagnostics and Instrumentation took over in 1991.

Robert Walsh, P.E. testified that the building needed to be expanded to accommodate the businesses success; that the parking exists in the front of the building already; that the expansion of the building is triggering the need for the detention bas in and the basin is proposed in this location because it is located in the lower area of the lot; that the property has two front yards and the rear yard meets the railroad right of way; that there is an un-named tributary to the Sparkill Creek on the property; that it is not a regulated waterway but they are being respectful of it because it is a tributary to the Sparkill Creek; that they have done geo-technical testing and

TOWN CLERK'S OFFICE
TOWN OF ORANGETOWN

Instrumentation Labs ZBA#19-94 Page 3 of 6

Permit#48870

along Glenshaw is very shallow; that the 8-10' ground water where the system is being proposed will permit 10.5" of water per hour into the basin; that the basin will not be holding water for very long; that there is a berm proposed to shield the water and the optimal amount of stormwater will be managed because of the proposed location of the basin; that there is a 25' drainage easement on the western side of the property that ends where the northern parcel is and that will not be affected by the additional parking proposed.

Public Comment:

No public comment

The Board members made personal inspections of the premises the week before the meeting and found them to be properly posted and as generally described on the application.

A satisfactory statement in accordance with the provisions of Section 809 of the General Municipal Law of New York was received.

Mr. Sullivan made a motion to close the Public Hearing which motion was seconded by Ms. Castelli and carried unanimously.

FINDINGS OF FACT AND CONCLUSIONS:

After personal observation of the property, hearing all the testimony and reviewing all the documents submitted, the Board found and concluded that the benefits to the applicant if the variance(s) are granted outweigh the detriment (if any) to the health, safety and welfare of the neighborhood or community by such grant, for the following reasons:

- 1. The requested Section 13.10B (14) above ground detention basin within buffer, Section 5.224 Parking in front yard; rear yard, Section 5.22 yards should be unobstructed, and Section 5.153 Accessory structures shall be 15' from the principal structure variances will not produce an undesirable change in the character of the neighborhood or a detriment to nearby properties. Scientific Research companies have existed in this location since the 1970's. This applicant is proposing to expand the building and improve the site. There has always been parking in the front of the building and the addition of the basin to collect stormwater and the additional landscaping will improve the aesthetics of the lot.
- 2. The requested Section 13.10B (14) above ground detention basin within buffer, Section 5.224 Parking in front yard; rear yard, Section 5.22 yards should be unobstructed, and Section 5.153 Accessory structures shall be 15' from the principal structure variances will not have an adverse effect or impact on the physical or environmental conditions in the neighborhood or district. Scientific Research companies have existed in this location since the 1970's. This applicant is proposing to expand the building and improve the site. There has always been parking in the front of the building and the addition of the basin to collect stormwater and the additional landscaping will improve the aesthetics of the lot.

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TOWN OF ORANGETOWN

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- The benefits sought by the applicant cannot be achieved by other means feasible for the applicant to pursue other than by obtaining variances.
- 4. The requested Section 13.10B (14) above ground detention basin within buffer, Section 5.224 Parking in front yard; rear yard, Section 5.22 yards should be unobstructed, and Section 5.153 Accessory structures shall be 15' from the principal structure variances, although somewhat substantial, afford benefits to the applicant that are not outweighed by the detriment, if any, to the health, safety and welfare of the surrounding neighborhood or nearby community. Scientific Research companies have existed in this location since the 1970's. This applicant is proposing to expand the building and improve the site. There has always been parking in the front of the building and the addition of the basin to collect stormwater and the additional landscaping will improve the aesthetics of the lot.
- 5. The applicant purchased the property subject to Orangetown's Zoning Code (Chapter 43) and is proposing a new addition and/or improvements, so the alleged difficulty was self-created, which consideration was relevant to the decision of the Board of Appeals, but did not, by itself, preclude the granting of the area variances.
- 6. The Board made a motion to override #1 of the Rockland County Planning Department's letter dated October 2, 2019 because parking has existed in the front of the building since at least 1970 and site constraints limit the location of available parking; and the proposed location of the detention basin at the northerly end of the property is to mitigate stormwater runoff and where it will be able to collect 10.5" of water per hour, and is located a distance away from the tributary to the Sparkill Creek.

DECISION: In view of the foregoing and the testimony and documents presented, the Board RESOLVED to OVERRIDE Comment #1 of the Rockland County Department of Planning letter dated October 2, 2019 and to APPROVE the application for the requested Section 13.10B (14) above ground detention basin within buffer, Section 5.224 Parking in front yard; rear yard, Section 5.22 yards should be unobstructed, and Section 5.153 Accessory structures shall be 15' from the principal structure variances; and FURTHER RESOLVED, that such decision and the vote thereon shall become effective and be deemed rendered on the date of adoption by the Board of the minutes of which they are a part.

General Conditions:

- (i) The approval of any variance or Special Permit is granted by the Board in accordance with and subject to those facts shown on the plans submitted and, if applicable, as amended at or prior to this hearing, as hereinabove recited or set forth.
- (ii) Any approval of a variance or Special Permit by the Board is limited to the specific variance or Special Permit requested but only to the extent such approval is granted herein and subject to those conditions, if any, upon which such approval was conditioned which are hereinbefore set forth.

TOWN CLERK'S OFFICE

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TOWN OF ORANGETOWN

Instrumentation Labs ZBA#19-94 Page 5 of 6

Permit#48870

- (iii) The Board gives no approval of any building plans, including, without limitation, the accuracy and structural integrity thereof, of the applicant, but same have been submitted to the Board solely for informational and verification purposes relative to any variances being requested.
- (iv) A building permit as well as any other necessary permits must be obtained within a reasonable period of time following the filing of this decision and prior to undertaking any construction contemplated in this decision. To the extent any variance or Special Permit granted herein is subject to any conditions, the building department shall not be obligated to issue any necessary permits where any such condition imposed should, in the sole judgment of the building department, be first complied with as contemplated hereunder. Occupancy will not be made until, and unless, a Certificate of Occupancy is issued by the Office of Building, Zoning and Planning Administration and Enforcement which legally permits such occupancy.
- (v) Any foregoing variance or Special Permit will lapse if any contemplated construction of the project or any use for which the variance or Special Permit is granted is not substantially implemented within one year of the date of filing of this decision or that of any other board of the Town of Orangetown granting any required final approval to such project, whichever is later, but in any event within two years of the filing of this decision. Merely obtaining a Building Permit with respect to construction or a Certificate of Occupancy with respect to use does not constitute "substantial implementation" for the purposes hereof.

TOWN CLERK'S OFFICE 7019 NOV 14 P IS: 06 TOWN OF ORANGETOWN

Instrumentation Labs ZBA#19-94 Page 6 of 6

Permit #48870

The foregoing resolution to override Comment #1 of the Rockland County Department of Planning letter dated October 2, 2019 and to APPROVE the application for the requested Section 13.10B (14) above ground detention basin within buffer, Section 5.224 Parking in front yard; rear yard, Section 5.22 yards should be unobstructed, and Section 5.153 Accessory structures shall be 15' from the principal structure variances; was presented and moved by Mr. Sulfivan, seconded by Ms. Castelli and carried as follows: Mr. Quinn, aye; Mr. Sullivan, aye; Ms. Salomon, aye; and Ms. Castelli, aye. Mr. Bosco was absent.

The Administrative Aide to the Board is hereby authorized, directed and empowered to sign this decision and file a certified copy thereof in the office of the Town Clerk.

DATED: November 6, 2019

ZONING BOARD OF APPEALS TOWN OF ORANGETOWN

Deborah Arbolino

Administrative Aide

DISTRIBUTION:

APPÉICANT ZBA MEMBERS SUPERVISOR TOWN BOARD MEMBERS TOWN ATTORNEY
DEPUTY TOWN ATTORNEY
OBZPAE BUILDING INSPECTOR-M.M.

TOWN CLERK HIGHWAY DEPARTMENT ASSESSOR DEPT. OF ENVIRONMENTAL MGMT. and ENGINEERING FILEZBA, PB CHAIRMAN, ZBA, PB, ACABOR

> TOWN CLERK'S OFFICE SUB NOVIN P 12:06 TOWN OF ORANGETOWN

DECISION

CONFORMANCE TO TOWN PERFORMANCE STANDARDS ACCEPTED WITH CONDITIONS

To: Donald Brenner (Instrumentation Labs) 4 Independence Avenue Tappan, New York 10983

ZBA #19-112 Date: December 4, 2019 Permit # 48870

FROM: ZONING BOARD OF APPEALS: Town of Orangetown

ZBA#19-112: Application of Instrumentation Laboratory requesting the Zoning Board of Appeals' review, and determination, of conformance with the Town of Orangetown Zoning Code (Orangetown Code Chapter 43) Section 4.12 Performance Standards review of in-vitro diagnostics reagents and controls and expansion of the existing building. The premises are located at 526 Route 303, Orangeburg, New York and is identified on the Orangetown Tax Map as Section 70.19, Block 1, Lot 45 in the LO zoning district.

Heard by the Zoning Board of Appeals of the Town of Orangetown at a meeting held on Wednesday, December 4, 2019 at which time the Board made the determination hereinafter set forth.

Donald Benner, Attorney, Randy Vlasak, Senior Plant Engineering Manager, and Robert Walsh, P.E., appeared and testified.

The following documents were presented:

- Instrumentation laboratory building & parking site plan dated April 10, 2019 last revised August 23, 2019 signed and sealed by Robert E. Wulsh P.E. 701, C01,C02,C03C04,C05,C06,C07,C08,C09.
- Instrumentation Laboratory First Floor Plan A11 dated May 29, 2019 last revised Sept. 11, 2019; Second Floor Plan, same dates; Building Elevations, same dates; signed and sealed by Richard F. Basta, N.Y.S. Licensed Architect.
- 3. Safety Data Sheets (38 pages).
- Instrumentation Laboratory Raw Material Chemical Inventory and Classification (6 pages).
- 5. Short Environmental assessment Form Part 1 and 2.
- 6. Hazardous Materials Certificate of Registration for years 2019 -2022.
- Town of Orangetown Department of Environmental Management and Engineering Industrial Wastewater Permit NO.2019-004 signed by Michael Weber, Chief Plant Operator dated December 24, 2018.
- New York State Department of Environmental Conservation resource screening dated January 9, 2019 signed by Michael Grosso, Division of Environmental Permits Region 3.
- Standard Operating Procedures Instrumentation Laboratory Orangeburg Air Emission ID System.
- 10. Resume of Operations (15 pages).
- Memorandum dated December 3, 2019 from Eamon Reilly, P.E., Commissioner, Department of Environmental Management and Engineering, Town of Orangetown.

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12. Memorandum dated December 2, 2019 from Michael Weber, Industrial Treatment Coordinator, Department of Environmental Management and Engineering, Town of Orangetown with one page attachment.

13. Memorandum dated November 27, 2019 from Dylan Holsiss, Junior Public Heath Engineer and Zoning Enforcement Officer, Department of Environmental Management

and Engineering, Town of Orangetown.

14. A memorandum dated November 26, 2019 from Bruce Peters, Engineer III, Department of Environmental Management and Engineering, Town of Orangetown with a letter dated July 10, 2019 addressed to the Planning board attached.

15. A memorandum dated November 27, 2019 from Michael Bettmann, Chief Fire Safety

Inspector, Town of Orangetown.

16. A letter dated November 15, 2019 from the Rockland County Department of Planning signed by Douglas J. Schuetz, Acting Commissioner of Planning.

17. A letter dated November 20, 2019 from the Rockland County Sewer District No.1 signed by Joseph LaFiandra, Engineer II.

18. A letter dated December 2, 2019 from Rockland County Department of Health singed by Elizabeth Mello, P.E., Senior Public Health Engineer.

19. Thirteen pages of the Premier Brands of America Inc. introduction to the company packet.

Mr. Sullivan, Chairman, made a motion to open the Public Hearing which motion was seconded by Mr. Bosco and carried unanimously.

On advice of Denise Sullivan, Deputy Town Attorney, counsel to the Zoning Board of Appeals, Mr. Sullivan moved for a Board determination, based upon the testimony heard by this Board and the facts as presented in the application submissions and in the record, that since the application seeks a Performance Standards Review for a proposed expansion to the technology center Hemostasis and blood gas reagents business in a zoned LO lot, the application is a Type II action exempt from the State Environmental Quality Review Act (SEQRA), pursuant to SEQRA Regulations §617.6 (e) (25) and /or (34); which does not require SEQRA environmental review. The motion was seconded by Ms. Castelli and carried as follows: Mr. Bosco, aye; Mr. Quinn, aye; Mr. Sullivan, aye; Ms. Salomon, aye; and Ms. Castelli, aye.

Donald Brenner, Attorney, testified that the application received a preliminary approval and a neg dec a few weeks ago; that they were before this Board for variances for the building a short time ago; that he spoke Mr. Eamon Reilly and he said that there would be no problem with the approval with conditions of answering their questions prior to issuance of permit and that the County read the plans wrong the building is two story.

Randy Vlasak, Senior Plant Engineering Manager handed out papers labeled "Expansion Project Overview" and explained that the company has been opened and operating since 1959 and in Orangeburg since 1989 and with Werfren since 1991; that they run 1.1 million patient samples using their products every day; that they are expanding because of their continued growth but will continue with the same operation that has been reviewed by the Board three years ago; that they are not adding cooling towers, that there will be new plumbing and air for the addition and they are removing one of the existing three generators (30kw) and replacing it with a 60kw

> JOMN CLERK'S OFFICE 2013 DEC 10 V 11: 18 TOWN OF ORANGETOWN

generator Instrumentation Labs Performance Standards ZBA#19-112 Page 3 of 6

Permit #48870

The Board reviewed the Performance Standards and Fire Supplement forms.

The Board members made personal inspections of the premises the week before the meeting and found them to be properly posted and as generally described on the application.

A satisfactory statement in accordance with the provisions of Section 809 of the General Municipal Law of New York was received.

Mr. Sullivan made a motion to close the Public Hearing which motion was seconded by Ms. Castelli and carried unanimously.

FINDINGS OF FACT AND CONCLUSIONS:

After personal observation of the property, hearing all the testimony and reviewing all of the documents submitted, the Board found and concluded that:

Based upon the information contained in the applicant's Resume of Operations and Equipment, and the Fire Prevention Supplement; the reports dated December 2, 2019 from Michael Weber, Chief Operator and Bruce Peters, Engineer III, memo dated November 26, 2019 & July 10, 2019, Town of Orangetown Department of Environmental Management and Engineering (D.E.M.E.); memo dated November 27, 2019, from Dylan Hofsiss, Junior Public Health Engineer and Zoning Enforcement Officer, Town of Orangetown Department of Environmental Management and Engineering (D.E.M.E.); the Memorandum dated December 3, 2019 from Eamon Reilly, PE, Commissioner, Town of Orangetown Department of Environmental Management and Engineering (D.E.M.E.); the report dated November 27, 2019 from Michael B. Bettmann, Chief Fire Inspector, Town of Orangetown Bureau of Fire Prevention (B.F.P.); Rockland County Department of Planning dated November 15, 2019 signed by Douglas J. Schuetz, Acting Commissioner of Planning; the other documents submitted to the Board, and the testimony of Applicant's representatives, the Board finds and concludes that the application conforms with the Performance Standards set forth in Zoning. Code Section 4.1, subject to compliance with the orders, rules and regulations of the Orangetown Office of Building, Zoning & Planning Administration & Enforcement, D.E.M.E., B.F.P., and all other departments having jurisdiction of the premises.

TOWN CLERK'S OFFICE TOWN OF ORANGETOWN

DECISION: In view of the foregoing and the testimony and documents submitted, the Board: RESOLVED that the Application for Performance Standards Conformance, pursuant to Zoning Code § 4.1, is APPROVED with the following SPECIFIC CONDITIONS that the Applicant: (1) Submit a revised Resume of Operations that complies with the comments contained in: (2) memo dated December 2, 2019 from Michael Weber, Chief Operator and Bruce Peters, Engineer III, memo dated November 26, 2019, Town of Orangetown Department of Environmental Management and Engineering (D.E.M.E.); (3) memo dated November 27, 2019, from Dylan Hofsiss, Junior Public Health Engineer and Zoning Enforcement Officer, Town of Orangetown Department of Environmental Management and Engineering (D.E.M.E.); (4) the Memorandum dated December 3, 2019, from Eamon Reilly, PE, Commissioner, Town of Orangetown Department of Environmental Management and Engineering (D.E.M.E.); (5) the report dated November 27, 2019 from Michael B. Bettmann, Chief Fire Inspector, Town of Orangetown Bureau of Fire Prevention (B.F.P); Rockland County Planning letter dated November 15, 2019 signed by Douglas J. Schuetz, Acting Commissioner of Planning; AND FURTHER RESOLVED, that such decision and the vote thereon shall become effective and be deemed rendered on the date of adoption by the Board of the minutes of which they are a part,

General Conditions:

- (i) The approval of any variance, Performance Standards Conformance, or Special Permit is granted by the Board in accordance with and subject to those facts shown on the plans submitted and, if applicable, as amended at or prior to this hearing, as hereinabove recited or set forth.
- (ii) Any approval of a variance, Performance Standards Conformance, or Special Permit by the Board is limited to the specific variance, Performance Standards Conformance, or Special Permit requested but only to the extent such approval is granted herein and subject to those conditions, if any, upon which such approval was conditioned which are hereinbefore set forth.
- (iii) The Board gives no approval of any building plans, including, without limitation, the accuracy and structural integrity thereof, of the applicant, but same have been submitted to the Board solely for informational and verification purposes relative to any Performance Standards Conformance, variances, or Special Permit being requested.

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Instrumentation Labs Performance Standards ZBA#19-112
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Permit #48870

- (iv) A building permit as well as any other necessary permits must be obtained within a reasonable period of time following the filing of this decision and prior to undertaking any construction contemplated in this decision. To the extent any variance, Performance Standards Conformance, or Special Permit granted herein is subject to any conditions, the building department shall not be obligated to issue any necessary permits where any such condition imposed should, in the sole judgment of the building department, be first complied with as contemplated hereunder. Occupancy will not be made until, and unless, a Certificate of Occupancy is issued by the Office of Building, Zoning and Planning Administration and Enforcement which legally permits such occupancy.
- (v) Any approved variance, Performance Standards Conformance, or Special Permit will lapse if any contemplated construction of the project or any use for which the variance, Performance Standards Conformance or Special Permit is granted is not substantially implemented within one year of the date of filing of this decision, or that of any other board of the Town of Orangetown granting any required final approval to such project, whichever is later, but in any event within two years of the filing of this decision. Merely obtaining a Bailding Permit with respect to construction or a Certificate of Occupancy with respect to use does not constitute "substantial implementation" for the purposes hereof.

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The foregoing Resolution, to approve the application for the requested conformance to Performance Standards with the following conditions that the applicant: (1) memo dated December 2, 2019 from Michael Weber, Chief Operator and Bruce Peters, Engineer III, memo dated November 26, 2019, Town of Orangetown Department of Environmental Management and Engineering (D.E.M.E.); (3) memo dated November 27, 2019, from Dylan Hofsiss, Junior Public Health Engineer and Zoning Enforcement Officer, Town of Orangetown Department of Environmental Management and Engineering (D.E.M.E.); (4) the Memorandum dated December 3, 2019, from Eamon Reilly, PE, Commissioner, Town of Orangetown Department of Environmental Management and Engineering (D.E.M.E.); (5) the report dated November 27, 2019 from Michael B. Bettmann, Chief Fire Inspector, Town of Orangetown Bureau of Fire Prevention (B.F.P); Rockland County Planning letter dated November 15, 2019 signed by Douglas J. Schuetz, Acting Commissioner of Planning; was presented and moved by Mr. Sullivan, seconded by Mr. Quinn and carried as follows: Mr. Bosco, aye; Mr. Quinn, aye; Mr. Sullivan, aye, Ms. Salomon, aye, and Ms. Castelli, aye.

The Administrative Aide to the Board is hereby authorized, directed and empowered to sign this decision and file a certified copy thereof in the office of the Town Clerk.

DATED: December 4, 2019

ZONING BOARD OF APPEALS TOWN OF ORANGETOWN

Deborah Arbofino Administrative Aide

DISTRIBUTION:

APPLICANT
ZBA MEMBERS
SUPERVISOR
TOWN BOARD MEMBERS
TOWN ATTORNEY
DEPCTY TOWN ATTORNEY
DEPCTY TOWN ATTORNEY
BUILDING INSPECTOR M.M.

TOWN CLERK HIGHWAY DEPARTMENT ASSESSOR DEPT GENVIRONMENTAL MOMT undENGINEERING FILEZBA, PB CHARMAN, ZBA, PB, ACABOR

TOWN OF ORANGETOWN TOWN CLERK'S OFFICE

Town of Orangetown Planning Board Decision July 31, 2019 Page 1 of 13

TO:

Donald Brenner, 4 Independence Avenue, Tappan, New York

10983

FROM:

Orangetown Planning Board

RE: Instrumentation Laboratory Site Plan: The application of Instrumentation Laboratory, owner, for Prepreliminary/ Preliminary/ Final Site Plan Review for the review of existing accessory structures, existing parking expansion and building expansions at a site known as "Instrumentation Laboratory Site Plan", in accordance with Article 16 of the Town Law of the State of New York, the Land Development Regulations of the Town of Orangetown, Chapter 21A of the Code of the Town of Orangetown and to determine the environmental significance of the application pursuant to the requirements of the New York State Environmental Quality Review Act. The site is located at 526 Route 303, in the Route 303 Overlay Zone, Orangeburg, Town of Orangetown, Rockland County, New York, and as shown on the Orangetown Tax Map as Section 70.19, Block 1, Lot 45 in the LO zoning district.

Heard by the Planning Board of the Town of Orangetown at meetings held **Wednesday, July 17 & 31, 2019,** the Board made the following determinations:

July 17, 2019

Donald Brenner, Rob Walsh and Randall Vlasak appeared and testified. The Board received the following communications:

1. A Project Review Committee Review dated July 10, 2019.

- 2. An Interdepartmental memorandum from the Office of Building, Zoning, Planning Administration and Enforcement, Town of Orangetown, signed by Jane Slavin, R. A., A.I.A., Director, dated July 12, 2019.
- 3. An Interdepartmental memorandum from the Department of Environmental Management and Engineering (DEME), Town of Orangetown, signed by Bruce Peters, P.E., dated July 10, 2019.
- 4. Letters from Brooker Engineering signed by Kenneth DeGennaro, P.E., dated July 1 & 17, 2019.
- A letter from the Rockland County Department of Planning, signed by Douglas Schuetz, Acting Commissioner of Planning, dated July 2, 2019.
 Letters from the Rockland County Department of Highways, signed by Dyan Rajasingham, Engineer II, dated June 25, 2019 and Joseph Arena, dated July 5, 2019.
- Letters from the Rockland County Department of Health, signed by Elizabeth Mello, P.E., Senior Public Health Engineer, dated July 5, 2019.
 An Email from the Rockland County Drainage Agency, Shajan Thottakara, dated December 20, 2017.
- 9. A letter from the Rockland County Sewer District No.1, signed by Joseph LaFindra, Engineer I, dated July 28, 2019.

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Town of Orangetown Planning Board Decision July 31, 2019
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- 10. An Interdepartmental memorandum from the Bureau of Fire Prevention, Town of Orangetown, signed by Douglas Sampath, Fire Inspector, dated July 5, 2019.
- 11. A Short Environmental Assessment Form, signed by Randall Vlasak, dated June 10, 2019.
- 12. A Project Narrative prepared by Donald Brenner, dated June 7, 2019.
 13. A cover letter prepared by Donald Brenner, dated January 10, 2019 with an attachment of a letter from the New York State Department of Environmental Conservation, dated January 9, 2019, signed by Michael Grosso, Division of Environmental Permits, Region 3.
- 14. A Building Permit Referral dated May 8, 2019, prepared by Rick Oliver, Deputy Building Inspector.
- 15. A copy of PB #18-06, Preliminary Site Plan Approval Subject to Conditions, dated December 12, 2018.
- 16. Plans prepared by El Associates Architects and Engineers, dated April 10, 2018, last revised April 10, 2019, unless noted:
 - T01: Title Sheet
 - C01: Existing Conditions & Site Demolition Plan
 - C02: Site Plan
 - C03: Site Improvement Details
 - C04: Grading & Drainage Plan & Drainage Profiles
 - C05: Drainage Details
 - C06: Site Lighting Plan
 - C07: Landscape Plan & Details
 - C08: Soil Erosion Control Plan
 - C09: Soil Erosion Control Details & Notes
 - A30: Elevations, dated September 11, 2018, last revised February 14, 2019

The Board reviewed the plans. The hearing was then opened to the Public.

The applicant requested a Continuation.

July 31, 2019

Donald Brenner, Rob Walsh and Randall Vlasak appeared and testified. The Board received the following communications:

1. A Project Review Committee Review dated July 17, 2019.

2. Plan prepared by El Associates Architects and Engineers, dated July19, 2019, last revised July 24, 2019.

The Board reviewed the plans. The hearing was then opened to the Public.

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Town of Orangetown Planning Board Decision July 31, 2019 Page 3 of 13

There being no one from the Public, a motion was made to close the Public Hearing portion of the meeting by Stephen Sweeney seconded by Michael Mandel and carried as follows: Thomas Warren, Chairman, aye; William Young, Vice Chairman, absent; Michael McCrory, aye; Michael Mandel, aye; Robert Dell, aye; Bruce Bond, absent and Stephen Sweeney, aye.

The proposed action is classified as an "unlisted action" as defined by Section 617.2 (al) of the New York State Environmental Quality Review Regulations (SEQRR). No agency, other than the Orangetown Planning Board will have any significant involvement in the review process, pursuant to Section 617.6 of SEQRA. On motion by Stephen Sweeney and seconded by Michael Mandel and carried as follows: Thomas Warren, Chairman, aye; William Young, Vice Chairman, absent; Michael McCrory, aye; Michael Mandel, aye; Robert Dell, aye; Bruce Bond, absent and Stephen Sweeney, aye the Board declared itself Lead Agency.

Pursuant to New York Code, Rules & Regulations (NYCRR) Section 617.7, the Town of Orangetown Planning Board, as lead agency, for the reasons articulated in this Board's analysis of all of the submissions by the applicant, interested agencies, departments and the public, with respect to this project including the Environmental Assessment Form, which reasons are summarized in the motion, hereby determines that the proposed action will not have a significant impact on the environment and a Draft Environmental Impact Statement (DEIS) will not be prepared.

After having identified the relevant areas of environmental concern, namely drainage, surface water runoff, land clearing, vegetation, fauna, traffic and noise levels, and after having taken a hard look at said environmental issues, and after having deliberated regarding such concerns, and having heard from the applicant, the applicant's professional representatives, namely El Associates, and having heard from the following offices, officials and/or Departments: (Town of Orangetown): The Office of Building, Zoning, Planning Administration and Enforcement and Department of Environmental Management and Engineering; and having heard from the following involved and interested agencies: Town of Orangetown Zoning Board of Appeals, Rockland County Sewer District No.1, Rockland County Drainage Agency No.1, Rockland County Department of Health, and having reviewed proposed Site Plan by prepared by El Associates, a summary of the reasons supporting this determination are, and the Planning Board finds, that the proposed action:

- Will not significantly affect existing air quality or noise levels;
- •Will not significantly affect existing surface water quality or quantity or drainage;
- ●Will not significantly affect existing ground water quality已前中国的
- •Will not significantly affect existing traffic levels;

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Town of Orangetown Planning Board Decision July 31, 2019 Page 4 of 13

Will not create a substantial increase in solid waste production;

Will not create a potential for erosion, flooding, leaching or drainage problems;

- •Will not have a significant adverse impact on the environmental characteristics of our critical environmental area or environmentally sensitive sites or features;
- •Will not have an impairment of the character or quality of important historical, archeological or architectural resources;
- •Will not have an impairment of the character or quality of important aesthetic resources;
- •Will not have an impairment of existing community or neighborhood character;
- Will not remove or destroy large quantities of vegetation or fauna;
- •Will not remove or destroy large quantities of wildlife species or migratory fish;
- •Will not have a significant adverse impact to natural resources;
- •Is consistent with the Town of Orangetown's Comprehensive/Master Plan;
- •Will not have adverse economic or social impacts upon the Town;
- Will not create a hazard to human health; and
- •Will not create a substantial change in the use of land, open space or recreational resources.

On motion by Stephen Sweeney and seconded by Michael Mandel and carried as follows: Thomas Warren, Chairman, aye; William Young, Vice Chairman, absent; Michael McCrory, aye; Michael Mandel, aye; Robert Dell, aye; Bruce Bond, absent and Stephen Sweeney, aye, the Board made a Negative Declaration pursuant to SEQRA.

DECISION: In view of the foregoing and the testimony before the Board, the application was granted **Preliminary Site Plan Approval Subject to the Following Conditions:**

- 1. The following note shall be placed on the Site Plan: "At least one week prior to the commencement of any work, including the installation of erosion control devices or the removal of trees and vegetation, a Pre-construction meeting must be held with the Town of Orangetown Department of Environmental Management and Engineering, Superintendent of Highways and the Office of Building, Zoning and Planning Administration and Enforcement. It is the responsibility and obligation of the property owner to arrange such a Meeting".
- 2. Stormwater Management Phase II Regulations: Additional certification, by an appropriate licensed or certified design professional shall be required for all matters before the Planning Board indicating that the drawings and project are in compliance with the Stormwater Management Phase II Regulations.

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Town of Orangetown Planning Board Decision July 31, 2019 Page 5 of 13

- **3.** All outdoor construction activities, including site clearing operations if applicable, shall take place between the hours of 7:00 a.m. and 7:00 p.m., Monday through Saturday. No such activities shall take place on Sunday or a legal holiday. The same criteria shall apply to indoor construction activities, except that such activities may take place between the hours of 7:00 a.m. and 10:00 p.m.
- **4.** Increase the berm along Route 303 by 6 inches for a total height of 3 feet 9 inches. Bring the berm in a southerly direction before it turns for a distance of 60 to 70 feet. Consider for visual unity, a small mound or berm on the southerly side (not to interfere with sight distance) closer to the driveway; make a nice fish tale on the berm.
- 5. All required setback dimensions shall be shown on the Site Plan.
- **6.** The rear yard setback indicated on the Bulk Table is 25.4' however, the plan shows 25'. The applicant shall review and revise accordingly.
- 7. The applicant is proposing a detention basin in the front yard along Route 303. Chapter 43, Article XIII, Route 303 Overlay District applies, Per 13.10.10 B (14), In no case shall the above ground detention basin be sited within any buffer area or within any front yard setback area or within the designated street line. A zoning variance shall be sought from the Town of Orangetown Zoning Board of Appeals.
- **8.** Per Chapter 43, Article V, Section 5.224, Table 3.11, LO district, Column 7, Number 3, *No parking is permitted in any yard.* A zoning variance shall be sought from the Town of Orangetown Zoning Board of Appeals.
- 9. Per Chapter 43, Article V, Section 5.22; all required yards shall be unobstructed. Variances are required for the existing wooden lean-to structure as it is located within the 100' setback. Dimensions to the structure and the pre-fab canopy over the dumpster shall be shown.
- 10. No parking is permitted in the 25' drainage easement.
- 11. Note if there is any building mounted lighting proposed and indicate on the site lighting plan and elevations.
- 12. Floor plans must be submitted showing the proposed use, layout and equipment. The applicant is required to make application to the Town of Orangetown Zoning Board of Appeals for Performance Standards Review.
- 13. The height of the existing and proposed building shall be indicated on the elevations.
- 14. The site, landscaping and architectural plans shall be leveled by the fown of Orangetown Architecture and Community Appearance Board of Reviews

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Town of Orangetown Planning Board Decision July 31, 2019 Page 6 of 13

- 15. A full SWPPP including drainage calculations shall be prepared for this site plan, and submitted to DEME for review and approval. The applicant's engineer is reminded that the SWPPP/ drainage calculations must address water quality and water quantity. Also, the SWPPP shall clearly describe how the proposed stormwater design meets the requirements for green infrastructure/ new construction and redevelopment and be designed in accordance with the January 2015, including any and all updates, version of the New York State Stormwater Management Design Manual (NYSDEC SMDM.) The applicant's engineer is also reminded that in accordance with the NYSDEC SMDM no more than 5 acres of disturbance can be undertaken at one time without special permission from the MS4 (Town of Orangetown.) Disturbances over 5 acres require additional design and inspection measures that need to be spelled out in the required SWPPP.
- **16.** The SWPPP shall describe in detail the maintenance requirements and procedures for the proposed stormwater system. These written procedures shall be made part of the post construction stormwater maintenance agreement in tandem with the inspection checklists.
- 17. The SWPPP/ drainage calculations shall include an analysis of the receiving headwall & piping to which the stormwater basin will outlet to. By calculation, it shall be determined if the existing piping is adequate to receive stormwater flow, for up to the 100yr, storm discharge, from the basin. This analysis may indicate that the receiving headwall & piping needs to be upsized.
- 18. Soil borings, perc tests and determination of ground water elevations shall be performed at the subsurface detention system location. These tests shall be performed PRIOR to this proposal receiving Final Approval to ensure the adequacy of the proposed design. This information shall be added to the drainage calculations. The tests shall be performed in the spring when the ground water table is typically at its highest.
- 19. The proposed stormwater basin, as shown on the drawings does not contain a forebay, how will stormwater quality be achieved?
- 20. The area of disturbance shall be listed on the drawings and listed in the SWPPP narrative.
- 21. Additional drainage structures (catch basins and piping) shall be added to the northern parking area. It appears that the current design will be inadequate to handle a large scale storm and the overland runoff created by the new/ expanded parking area. Also, there are no structures (catch basins and piping) along the eastern side of the proposed parking lot. However, the proposed grading will direct runoff there.

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- 22. Cross-sections through the proposed stormwater pond shall be added to the drawings. This cross section shall include water quality/ channel protection/ overbank protection/ extreme flood control elevations, low flow channel and corresponding storage volumes, as well as outlet control structure outlets with corresponding elevations, emergency spillway with elevation, maintenance access path with elevation, etc.
- 23. The stormwater pond maintenance path and emergency spillway shall be labeled on the basin, on the plans. Also, the maintenance path shall be 12 feet wide, in accordance with the NYSDEC-SMDM. Also, the drawings shall clearly indicate how/ where the maintenance path shall be accessed.
- 24. The unnamed catch basin, along the eastern side of the existing parking lot in front of the current building (which is connected by piping to inlet #12), shows an exhaust pipe that will exhaust it flow into the side of the proposed FES #11 and it piping. This is unacceptable. This confluence of exhausted stormwater runoff area shall be redesigned.
- 25. The soil erosion and sediment control plan shall utilize standard NYSDEC symbols.
- **26.** It appears on drawing C08 that the proposed limit of disturbance runs outside of the actual property, along NYS Route 303, in order to construct the stormwater pond as presently shown. This is unacceptable. All of the proposed work shall be fully contained on the site.
- 27. Profiles for all proposed drainage piping shall be added to the drawings.
- 28. A post construction stormwater maintenance agreement, in accordance with NYSDEC Phase II Regulations, for the proposed stormwater systems, shall be submitted to DEME and the Town Attorney's office for review and approval. Said agreement shall include a maintenance and management schedule, inspection check list, contact person with telephone number, yearly report to be submitted to DEME, etc.
- 29. The datum for the contours shall be given. Also, a note shall be added to the Site Plan indicating the source benchmark for the referenced datum, including the BM elevation.

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Town of Orangetown Planning Board Decision July 31, 2019 Page 8 of 13

30. Drainage Review Recommendation - Brooker Engineering
Drainage calculations have been provided for this submission that demonstrates that potential significant adverse impacts with respect to stormwater runoff can be mitigated and therefore recommends that the 526 Route 303 Site Plan be approved for drainage subject to the following conditions.

Project Description

Brooker Engineering previously reviewed this site for drainage for the approval of additional parking spaces and site modifications made since the approved 1986 Site Plan. No new exterior work was proposed at the time of that application and the Drainage Consultant approved for drainage subject to no conditions in the July 7, 2018 report.

This is the second drainage review report for this new project consisting of a building addition and parking lot expansion; the last review was dated July 1, 2019. A 68 feet by 321 feet building addition is proposed on the north side of the building and an approximately 260 feet by 116 feet parking lot expansion is proposed at the northeast corner of the property. An additional parking lot expansion is proposed along the eastern parking lot. A stormwater management basin is proposed in the existing grass lawn area along the east side of the property fronting Route 303.

Additional Information Reviewed

Since the last drainage review report, the applicant has submitted a Stormwater Pollution Prevention Plan that contains calculations to support the sizing of the stormwater management basin. Drainage calculations have been provided that demonstrate that the stormwater management basin is adequately sized to produce no net increases in peak stormwater runoff rates. The project increases impervious surfaces by 1.54 acres; this occurs over an existing grassy area. The basin provides storage for 6.6 inches of stormwater runoff over the proposed new impervious areas and reduces peak flows by about 50%.

Project Comments

- 1. Drainage calculations shall be provided that demonstrate that the stormwater management basin is adequately sized to produce no net increases in peak stormwater runoff rates.
- 2. The Sparkill Creek is located on the east side of Route 303 in the vicinity of the site. There is no mapped FEMA floodplain on the property, but there is a tributary to the Sparkill along the southern property line. There is a drainage ditch located from the local storm system to the tributary. A hydrologic and hydraulic analysis of the tributary shall be performed to demonstrate the proposed stormwater management system will not be surcharged by the tributary and provide the presumed stormwater runoff volume intended for the local runoff.

TOWN OF ORANGETOWN
TOWN OF ORANGETOWN

Town of Orangetown Planning Board Decision July 31, 2019 Page 9 of 13

Continuation of Condition #30...

- 3. Provide additional information for the existing storm drainage pipe that crosses under the existing driveway from the proposed stormwater management basin to the drainage ditch. It appears the ditch is back pitched with sedimentation occurring along the channel, thereby reducing the capacity of the ditch. The ditch shall be evaluated and improvements may be required.
- 4. A swale is proposed along Route 303 that concentrates stormwater runoff to about the location of the existing driveway entrance to Route 303. Provide more detail for the path of stormwater at this location.
- 5. It appears the limit of disturbance along the northeastern side of the existing parking lot, near proposed catch basin inlet #12, may create a low point along the limit of disturbance that will result in ponding. Provide more detail in this location to demonstrate the drainage pattern.
- 6. Provide more detail along the east side of the existing east parking lot (near the high point with elevation 99.06) to demonstrate the drainage pattern at this location.
- 7. Provide soil testing data to support the use of an infiltration basin to provide water quality mitigation.
- 8. Provide the supporting calculations for the stage versus storage and stage versus discharge curves in the SWPPP.
- **31.** Rockland County Department of Planning had the following comments which are incorporated herein as conditions of approval:
 - A review shall be completed by the New York State Department of Transportation, and any comments or concerns addressed.
 - A review must be done for the stormwater management system by the Rockland County Department of Health to ensure compliance with Article XIX (Mosquito Control) of the Rockland County Sanitary Code.
 - Prior to the start of construction or grading, all soil and erosion control measures must be in place for the site. These measures must meet the latest edition (November 2016) of the New York State Standards for Urban Erosion and Sediment Control.
 - There shall be no net increase in the peak rate of discharge from the site at all design points.

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Town of Orangetown Planning Board Decision July 31, 2019 Page 10 of 13

Continuation of Condition #31...

 The lighting plan shall be amended to demonstrate that the intensity of the candle lumens is less than 0.1 at the property line.

The proposed plans shall comply with Article XIII, Section 13.10B for the

Route 303 Overlay Zoning District to the extent applicable.

The site plan indicates 301 parking spaces are required for this property; however 320 are to be provided. Justification for why 19 extra spaces are necessary shall be included.

- Area designated for snow removal must be clearly delineated on the site
 plan so that the plow drivers will know where to place the snow piles. This
 will help to protect the proposed landscaping from damage due to the
 weight of the snow and salt intrusion. In addition, providing specific
 locations on the site for the snow piles will reduce the loss of available
 parking spaces meant to be used by employees.
- 32. Based upon the plans and information received, Rockland County Highway Department requested the following; a drainage report for the proposed improvement shall be submitted to the Highway Department for review.
- 33. The Rockland County Health Department reviewed the submitted information and found that application is to be made to the Health Department for review of the stormwater system for compliance with the County Mosquito Code.
- **34.** The Rockland County Sewer District #1 does not object to the plan as shown. This project does not affect any sanitary sewers within the District and request no future correspondence for this site.
- **35.** The Town of Orangetown Bureau of Fire Prevention had the following comments which are incorporated herein as conditions of approval:
 - A fire lane must be provided on the north side of 2 story addition at a minimum width of 26 feet.
 - Provide a site plan showing a fire apparatus with the following dimensions navigating the north, east and south sides of the building; the overall length 48 feet, length from center of front axle to center of rear axle 285 inches.
 - Clarify the proposed use of the 2 and 1 story additions.
 - NFPA 13 compliant fire sprinkler coverage must be provided.
 - NFPA 72 compliant fire alarm coverage must be provided.
 - Emergency lighting, exit signage and an egress plan must be provided per chapter 10 of the New York State Fire Code.

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Town of Orangetown Planning Board Decision July 31, 2019 Page 11 of 13

- **36.** Based upon Rockland County Drainage Agency (RCDA) evaluation of available mapping and information submitted, it has been determined that the proposed activity is outside the jurisdiction of the RCDA. Therefore, a permit from the RCDA pursuant to the Rockland County Stream Control Act, Chapter 846, is not required based upon its review of the information provided.
- 37. The following agencies do not object to the Town of Orangetown Planning Board assuming responsibilities of lead agency for SEQRA purposes:

- Town of Orangetown Zoning Board of Appeals

- Rockland County Sewer District No. 1
- Rockland County Department of Health
- Rockland County Highway Department
- 38. The applicant shall comply with all pertinent items in the Guide to the Preparation of Site Plans and Board Decisions prior to signing the final plans.
- **39.** All reviews and approvals from various governmental agencies must be obtained prior to stamping of the Site Plan.
- **40.** TREE PROTECTION: The following note shall be placed on the Site Plan: The Tree Protection and Preservation Guidelines adopted pursuant to Section 21-24 of the Land Development Regulations of the Town of Orangetown will be implemented in order to protect and preserve both individual specimen trees and buffer area with many trees. Steps that will be taken to reserve and protect existing trees to remain are as follows:

a. No construction equipment shall be parked under the tree canopy.

- b. There will be no excavation or stockpiling of earth underneath the trees.
- c. Trees designated to be preserved shall be marked conspicuously on all sides at a 5 to 10 foot height.
- d. The Tree Protection Zone for trees designated to be preserved will be established by one of the following methods:

- One (1) foot radius from trunk per inch DBH

- Drip line of the Tree Canopy. The method chosen should be based on providing the maximum protection zone possible. A barrier of snow fence or equal is to be placed and maintained one yard beyond the established tree protection zone. If it is agreed that the tree protection zone of a selected tree must be violated, one of the following methods must be employed to mitigate the impact:

 Light to Heavy Impacts – Minimum of eight inches of wood chips installed in the area to be protected. Chips shall be removed upon completion of work.

- Light Impacts Only - Installation of ¾ inch of plywood or boards, or equal over the area to be protected.

The builder or its agent may not change grade within the tree protection zone of a preserved tree unless such grade change has received final approval from the Planning Board. If the grade level is 16 60 APATATION TO THE MOST THE WELL AND THE WELL AND

Town of Orangetown Planning Board Decision July 31, 2019
Page 12 of 13

- **41.** All landscaping shown on the site plans shall be maintained in a vigorous growing condition throughout the duration of the use of this site. Any plants not so maintained shall be replaced with new plants at the beginning of the next immediately following growing season.
- **42.** Prior to the commencement of any site work, including the removal of trees, the applicant shall install the soil erosion and sedimentation control as required by the Planning Board. Prior to the authorization to proceed with any phase of the site work, the Town of Orangetown Department of Environmental Management and Engineering (DEME) shall inspect the installation of all required soil erosion and sedimentation control measures. The applicant shall contact DEME at least 48 hours in advance for an inspection.
- **43**. The contractor's trailer, if any is proposed, shall be located as approved by the Planning Board.
- 44. If the applicant, during the course of construction of any required public improvements or private sanitary or storm sewer improvements, encounters such conditions as flood areas, underground water, soft or silty areas, improper drainage, or any other unusual circumstances or conditions that were not foreseen in the original planning, such conditions shall be reported immediately to DEME. The applicant (or the applicant's engineer) shall submit their recommendations as to the special treatment or design modification to be given such areas to secure adequate, permanent and satisfactory construction. DEME shall investigate the condition(s), and shall either approve the applicant's (applicants' engineer's) recommendations to correct the condition(s), or order a modification thereof. In the event of the applicant's (applicants engineer's) disagreement with the decision of DEME, or in the event of a significant change resulting to the subdivision plan or site plan or any change that involves a wetland regulated area, the matter shall be decided by the agency with jurisdiction in that area (i.e. Federal Wetlands U.S. Army Corps of Engineers).
- **45**. Permanent vegetation cover of disturbed areas shall be established on the site within thirty (30) days of the completion of construction.
- **46.** Prior (at least 14 days) to the placing of any road sub-base, the applicant shall provide the Town of Orangetown Superintendent of Highways and DEME with a plan and profile of the graded road to be paved in order that these departments may review the drawings conformance to the approved construction plans and the Town Street Specifications
- **47.** The Planning Board shall retain jurisdiction over lighting, landscaping, signs and refuse control.

TOWN OF ORANGETOWN
TOWN CLERK'S OFFICE
TOWN CLERK'S OFFICE

Town of Orangetown Planning Board Decision July 31, 2019 Page 13 of 13

48. All of the conditions of this decision, shall be binding upon the owner of the subject property, its successors and/or assigns, including the requirement to maintain the property in accordance with the conditions of this decision and the requirement, if any, to install improvements pursuant to Town Code §21A-9. Failure to abide by the conditions of this decision as set forth herein shall be considered a violation of Site Plan Approval pursuant to Town Code §21A-4.

The foregoing Resolution was made and moved by Stephen Sweeney and seconded by Michael Mandel and carried as follows: Thomas Warren, Chairman, aye; William Young, Vice Chairman, absent; Bruce Bond, absent; Michael Mandel, aye; Robert Dell, aye; Michael McCrory, aye and Stephen Sweeney, aye.

The Clerk to the Board is hereby authorized, directed and empowered to sign this **DECISION** and file a certified copy in the Office of the Town Clerk and the Office of the Planning Board.

Dated: July 31, 2019 My Coopersmith, Chief Clerk Boards and Commissions

Town of Orangetown Planning Board

attachment

TOWN CLERK'S OFFICE 7019 SEP - 4 P 2: 21

NEGATIVE DECLARATION Notice of Determination of Non-Significance

PB#19-45: Instrumentation Laboratory Site Plan Permit #48870 (526 Route 303 Site Plan) Supersedes Permit #46508 Preliminary Site Plan Approval Subject to Conditions/ Neg. Dec.

Town of Orangetown Planning Board Decision July 31, 2019

This notice is issued pursuant to Part 617 of the implementing regulations pertaining to Article 8 (State Environmental Quality Review Regulation) of the Environmental Conservation Law.

The PLANNING BOARD, TOWN OF ORANGETOWN, as Lead Agency, has determined that the proposed action described below will not have a significant impact on the environment and a Draft Environmental Impact Statement will not be prepared.

NAME OF ACTION: Instrumentation Laboratory Site Plan: Preliminary Site Plan Approval Subject to Conditions/ Neg. Dec.

SEQR STATUS: Type I _____ Unlisted XXXXXX

CONDITIONED NEGATIVE DECLARATION: Yes _____ No XXXXXX

DESCRIPTION OF ACTION: Site Plan Review

LOCATION: The site is located at 526 Route 303, in the Route 303 Overlay Zone, Orangeburg, Town of Orangetown, Rockland County, New York, and as shown on the Orangetown Tax Map as Section 70.19, Block 1, Lot 45 in the LO zoning district.

REASONS SUPPORTING THIS DETERMINATION:

The Orangetown Planning Board, as Lead Agency, determined that the proposed action will not have a significant impact on the environment and a Draft Environmental Impact Statement (DEIS) will not be prepared. The reasons supporting this determination are as follows:

The project will not have a significant impact upon the environment and a DEIS need not be prepared because the proposed action does not significantly affect air quality, surface or ground water quality, noise levels or existing external traffic patterns. In addition, it will have no impact upon the aesthetic, agricultural or cultural resources of the neighborhood. No vegetation, fauna or wildlife species will be affected as a result of this proposed action. The proposed action is consistent with the Town of Orangetown's Master Plan and will not have any adverse economic or social impacts upon the Town or its businesses or residences.

If Conditioned Negative Declaration, the specific mitigation is provided on an attachment.

For Further Information contact:

Office of Building, Zoning and Planning Administration and Enforcement Town of Orangetown 20 Greenbush Road Orangeburg, NY 10962


Telephone Number: 845-359-5100

For Type I Actions and Conditioned Negative Declarations accept of this notice


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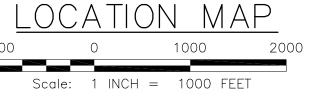
TOWN OF ORANGETOWN

INSTRUMENTATION LABORATORY BUILDING & PARKING ADDITION SITE PLAN 526 ROUTE 303, ORANGETOWN, ROCKLAND COUNTY, NEW YORK

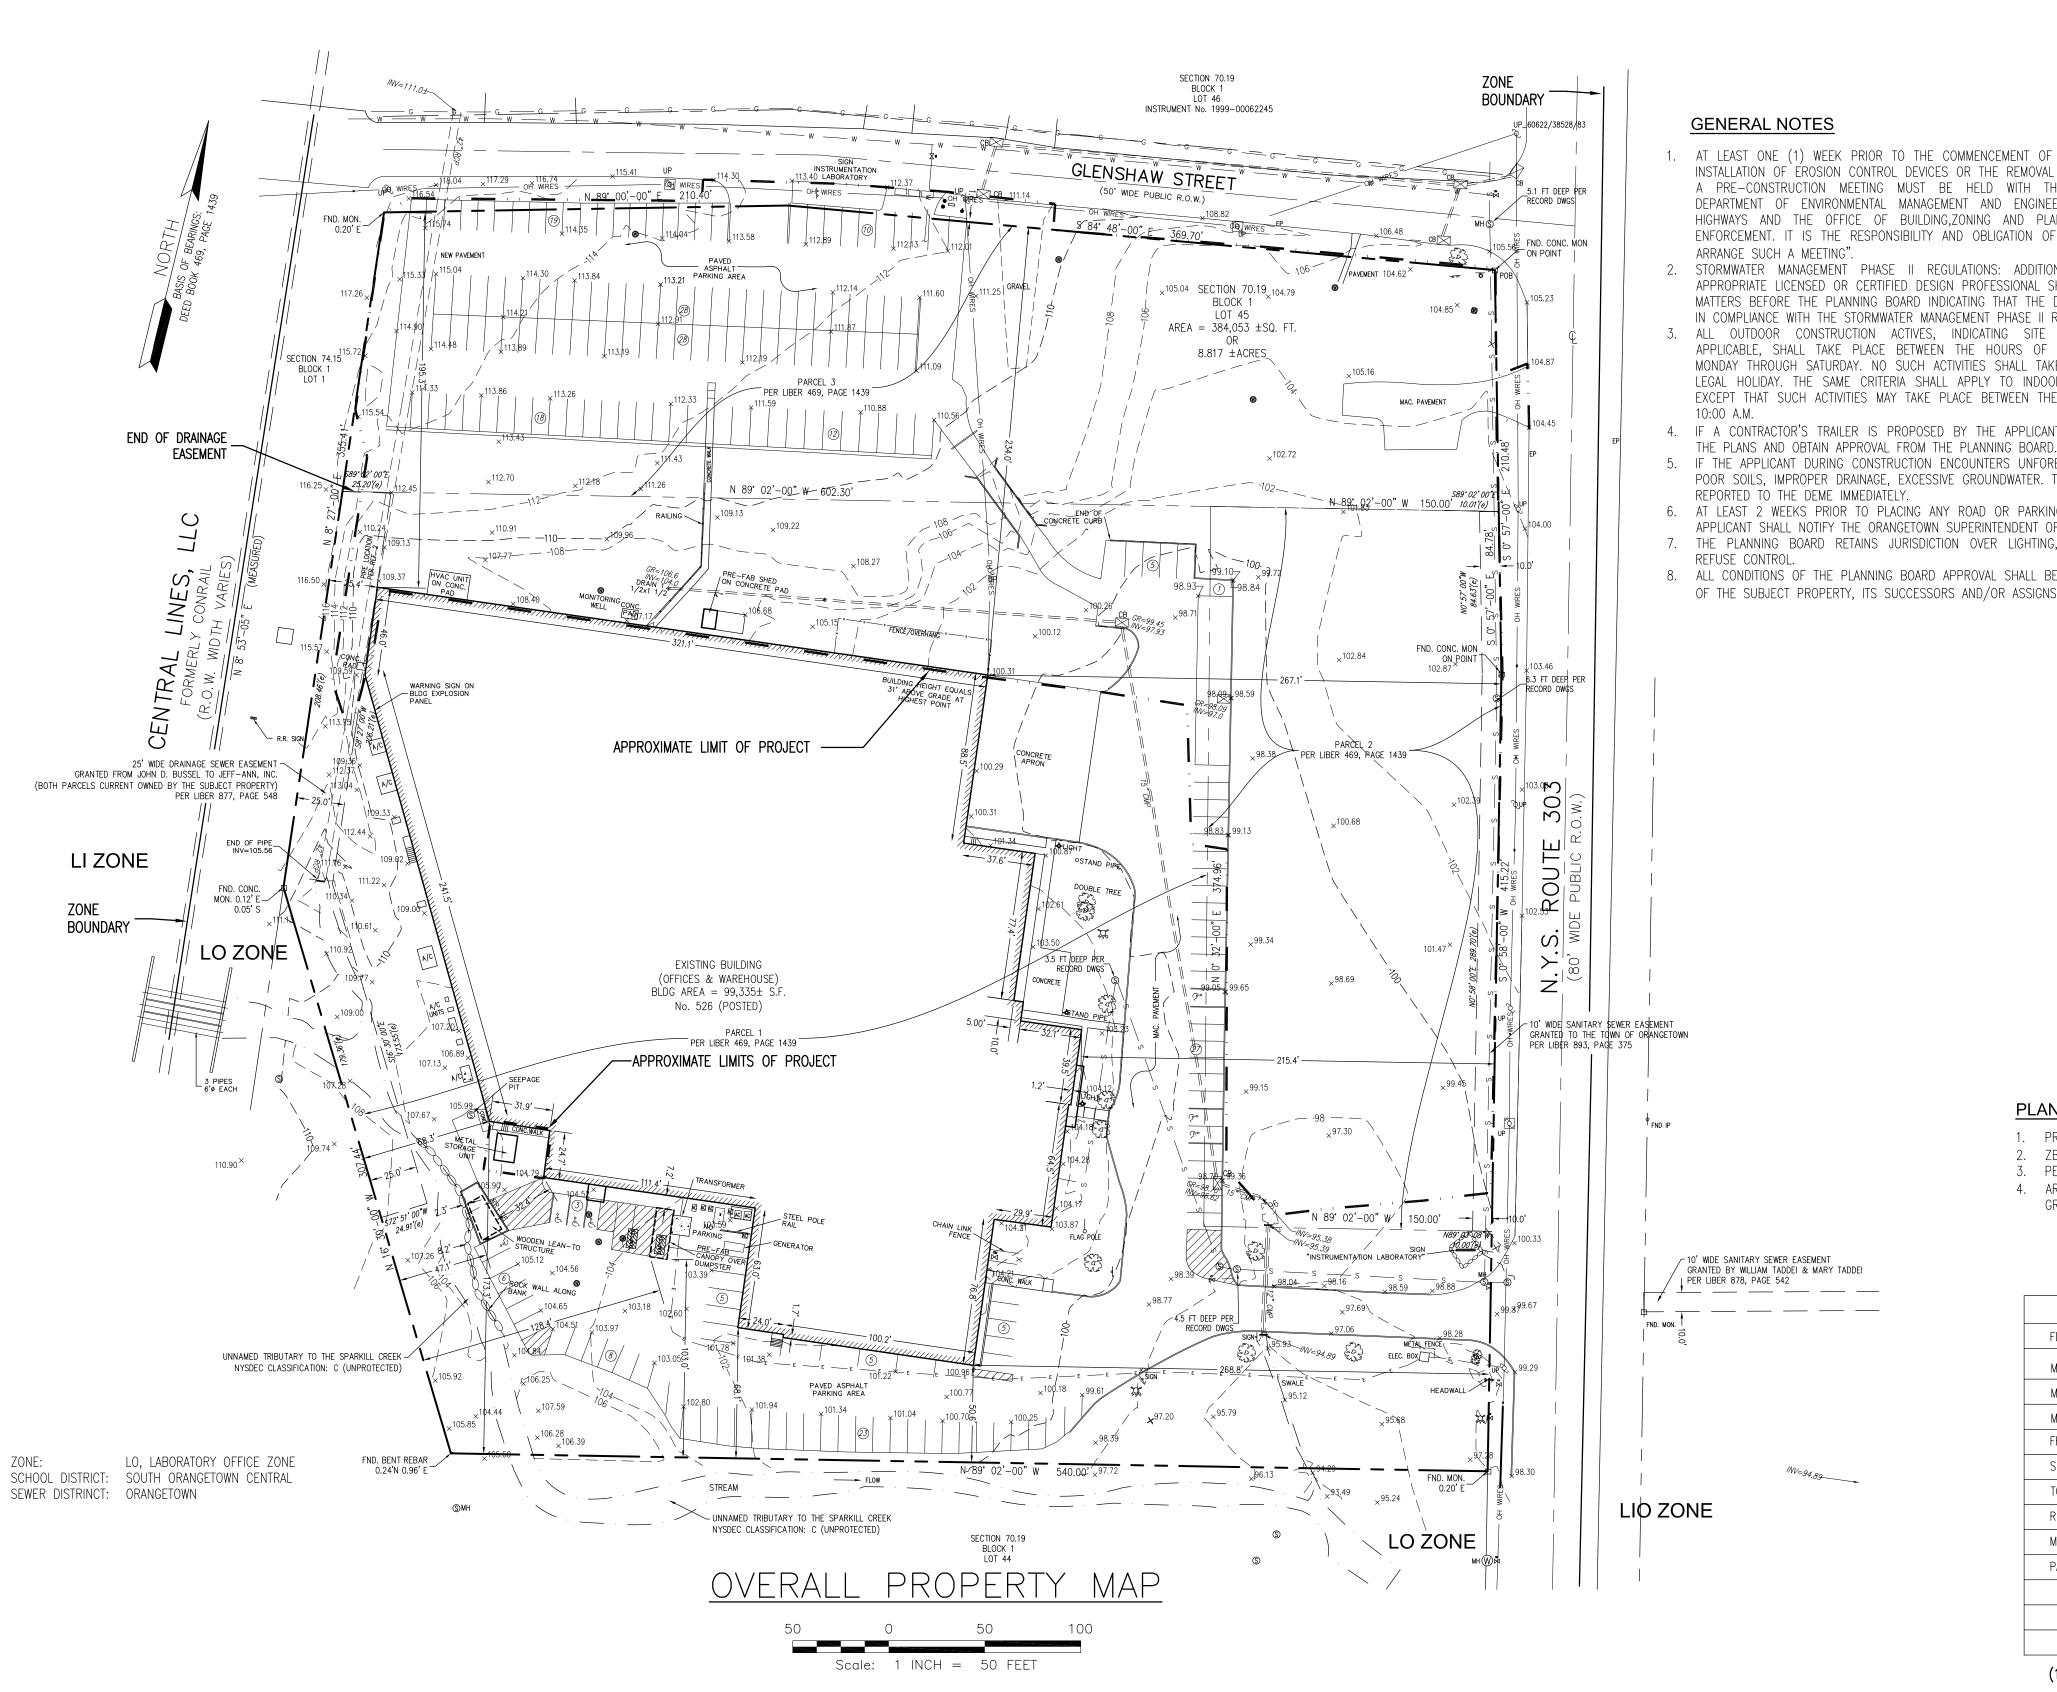

- APPLICANT SHALL NOTIFY THE ORANGETOWN SUPERINTENDENT OF HIGHWAYS AND DEME.
- 8. ALL CONDITIONS OF THE PLANNING BOARD APPROVAL SHALL BE BINDING UPON THE OWNER



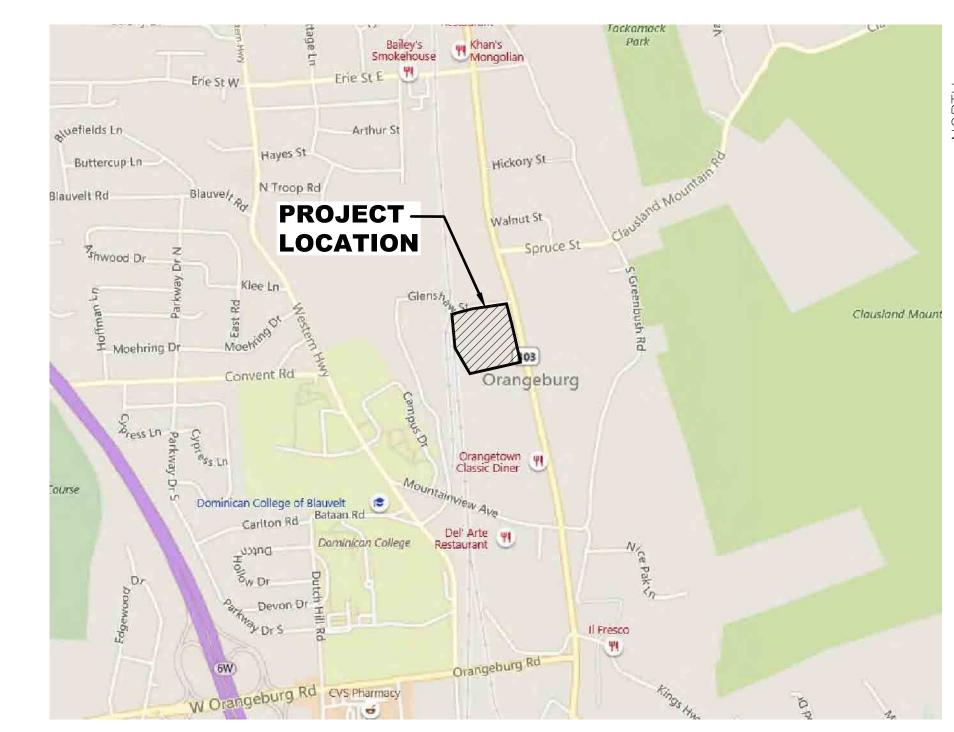

DRAWING INDEX

EXISTING CONDITIONS & SITE DEMOLITION PLAN

C02 SITE PLAN CO3 SITE IMPROVEMENT DETAILS C04 GRADING & DRAINAGE PLAN

EVISE PER PRELIMINARY SP APPROVAL, ISSUE FOR FINAL SP APPROVAL

REVISION DESCRIPTION

EI Associates

8 RIDGEDALE AVENUE • CEDAR KNOLLS NJ 07927 • 973.775.7777

PROFESSIONAL ENGINEER

TITLE SHEET

NY STATE LICENSE No. 080247-

ADD EXISTING DIMENSIONS, M&B DIMS AND EASEMENTS TO CO2

ADD LANDSCAPE BERM AT NORTHEAST CORNER OF SITE

ISSUED FOR BID AND CONSTRUCTION

ADD BUILDING SETBACK DIMENSIONS

ISSUE FOR ZONING BOARD APPROVAL

ADD CONTOURS TO LANDSCAPE PLAN

PREPARE PHASING PLAN C10

PLANNING

ROJECT

IANAGER:

ROBERT E. WALSH

SSUE PLANNING BOARD APPROVAL

C04.1 DRAINAGE PROFILES C05 DRAINAGE DETAILS C06 SITE LIGHTING PLAN

LANDSCAPE PLAN & DETAILS SOIL EROSION CONTROL PLAN SOIL EROSION CONTROL DETAILS & NOTES

PLANNING & LAND DEVELOPMENT APPROVAL NOTES:

- 1. PRELIMINARY SITE PLAN APPROVED GRANTED 7/31/2019.
- 2. ZBA#19-94 VARIANCES APPROVED 11/16/2019. . PERFORMANCE APPROVAL GRANTED DECEMBER 2019.
- 4. ARCHITECTURE AND COMMUNITY APPEARANCE BOARD OF REVIEW (ACABOR) APPROVAL GRANTED 2-6-2020.

ZONING DATA:	LO – LABORATORY-OFFICE ZONE DISTRICT

ITEM	REQUIRED	EXISTING	PROPOSED
FLOOR AREA RATIO (FAR)	0.40	0.26	0.36
MIN. LOT AREA	2 ACRES	384,053 S.F. 8.817 ACRES	384,053 S.F. 8.817 ACRES
MIN. LOT WIDTH	300 FT.	535.79 FT.	535.79 FT.
MIN. STREET FRONTAGE	150 FT.	626 FT.	626 FT.
FRONT YARD	100 FT	195.3 FT	195.3 FT
SIDE YARD	100 FT	50.6 FT	50.6 FT
TOTAL SIDE YARD	200 FT	50.6 FT	50.6 FT
REAR YARD	100 FT	25.4 FT (1)	25.4 FT (1)
MAX. BUILDING HEIGHT	31.35 FT	31-FT	31-FT
PARKING SPACES	301	203	313

(1) COMPLIES WITH NOTE # 10 OF BULK REQUIREMENTS

OWNER'S SIGNATURE

AS NOTED INSTRUMENTATION LABORATORY BUILDING & PARKING ADDITION 526 ROUTE 303 SECTION 70.19, BLOCK 1, LOT 45 TOWN OF ORANGETOWN HECKED ROCKLAND COUNTY PPROVED

EIA DRAWING NO.

25 FEB 20

30 JAN 20

23 AUG 19

21 AUG 19

9 AUG 19

24 JUL 19

19 JUL 19


10 JUN 19

10 APR 19

FILE NO. 18-816 EIA PROJECT NO. EG 8381.00

APPLICANT/OWNER INSTRUMENTATION LABORATORY 526 ROUTE 303

ORANGETOWN, NEW YORK 10962

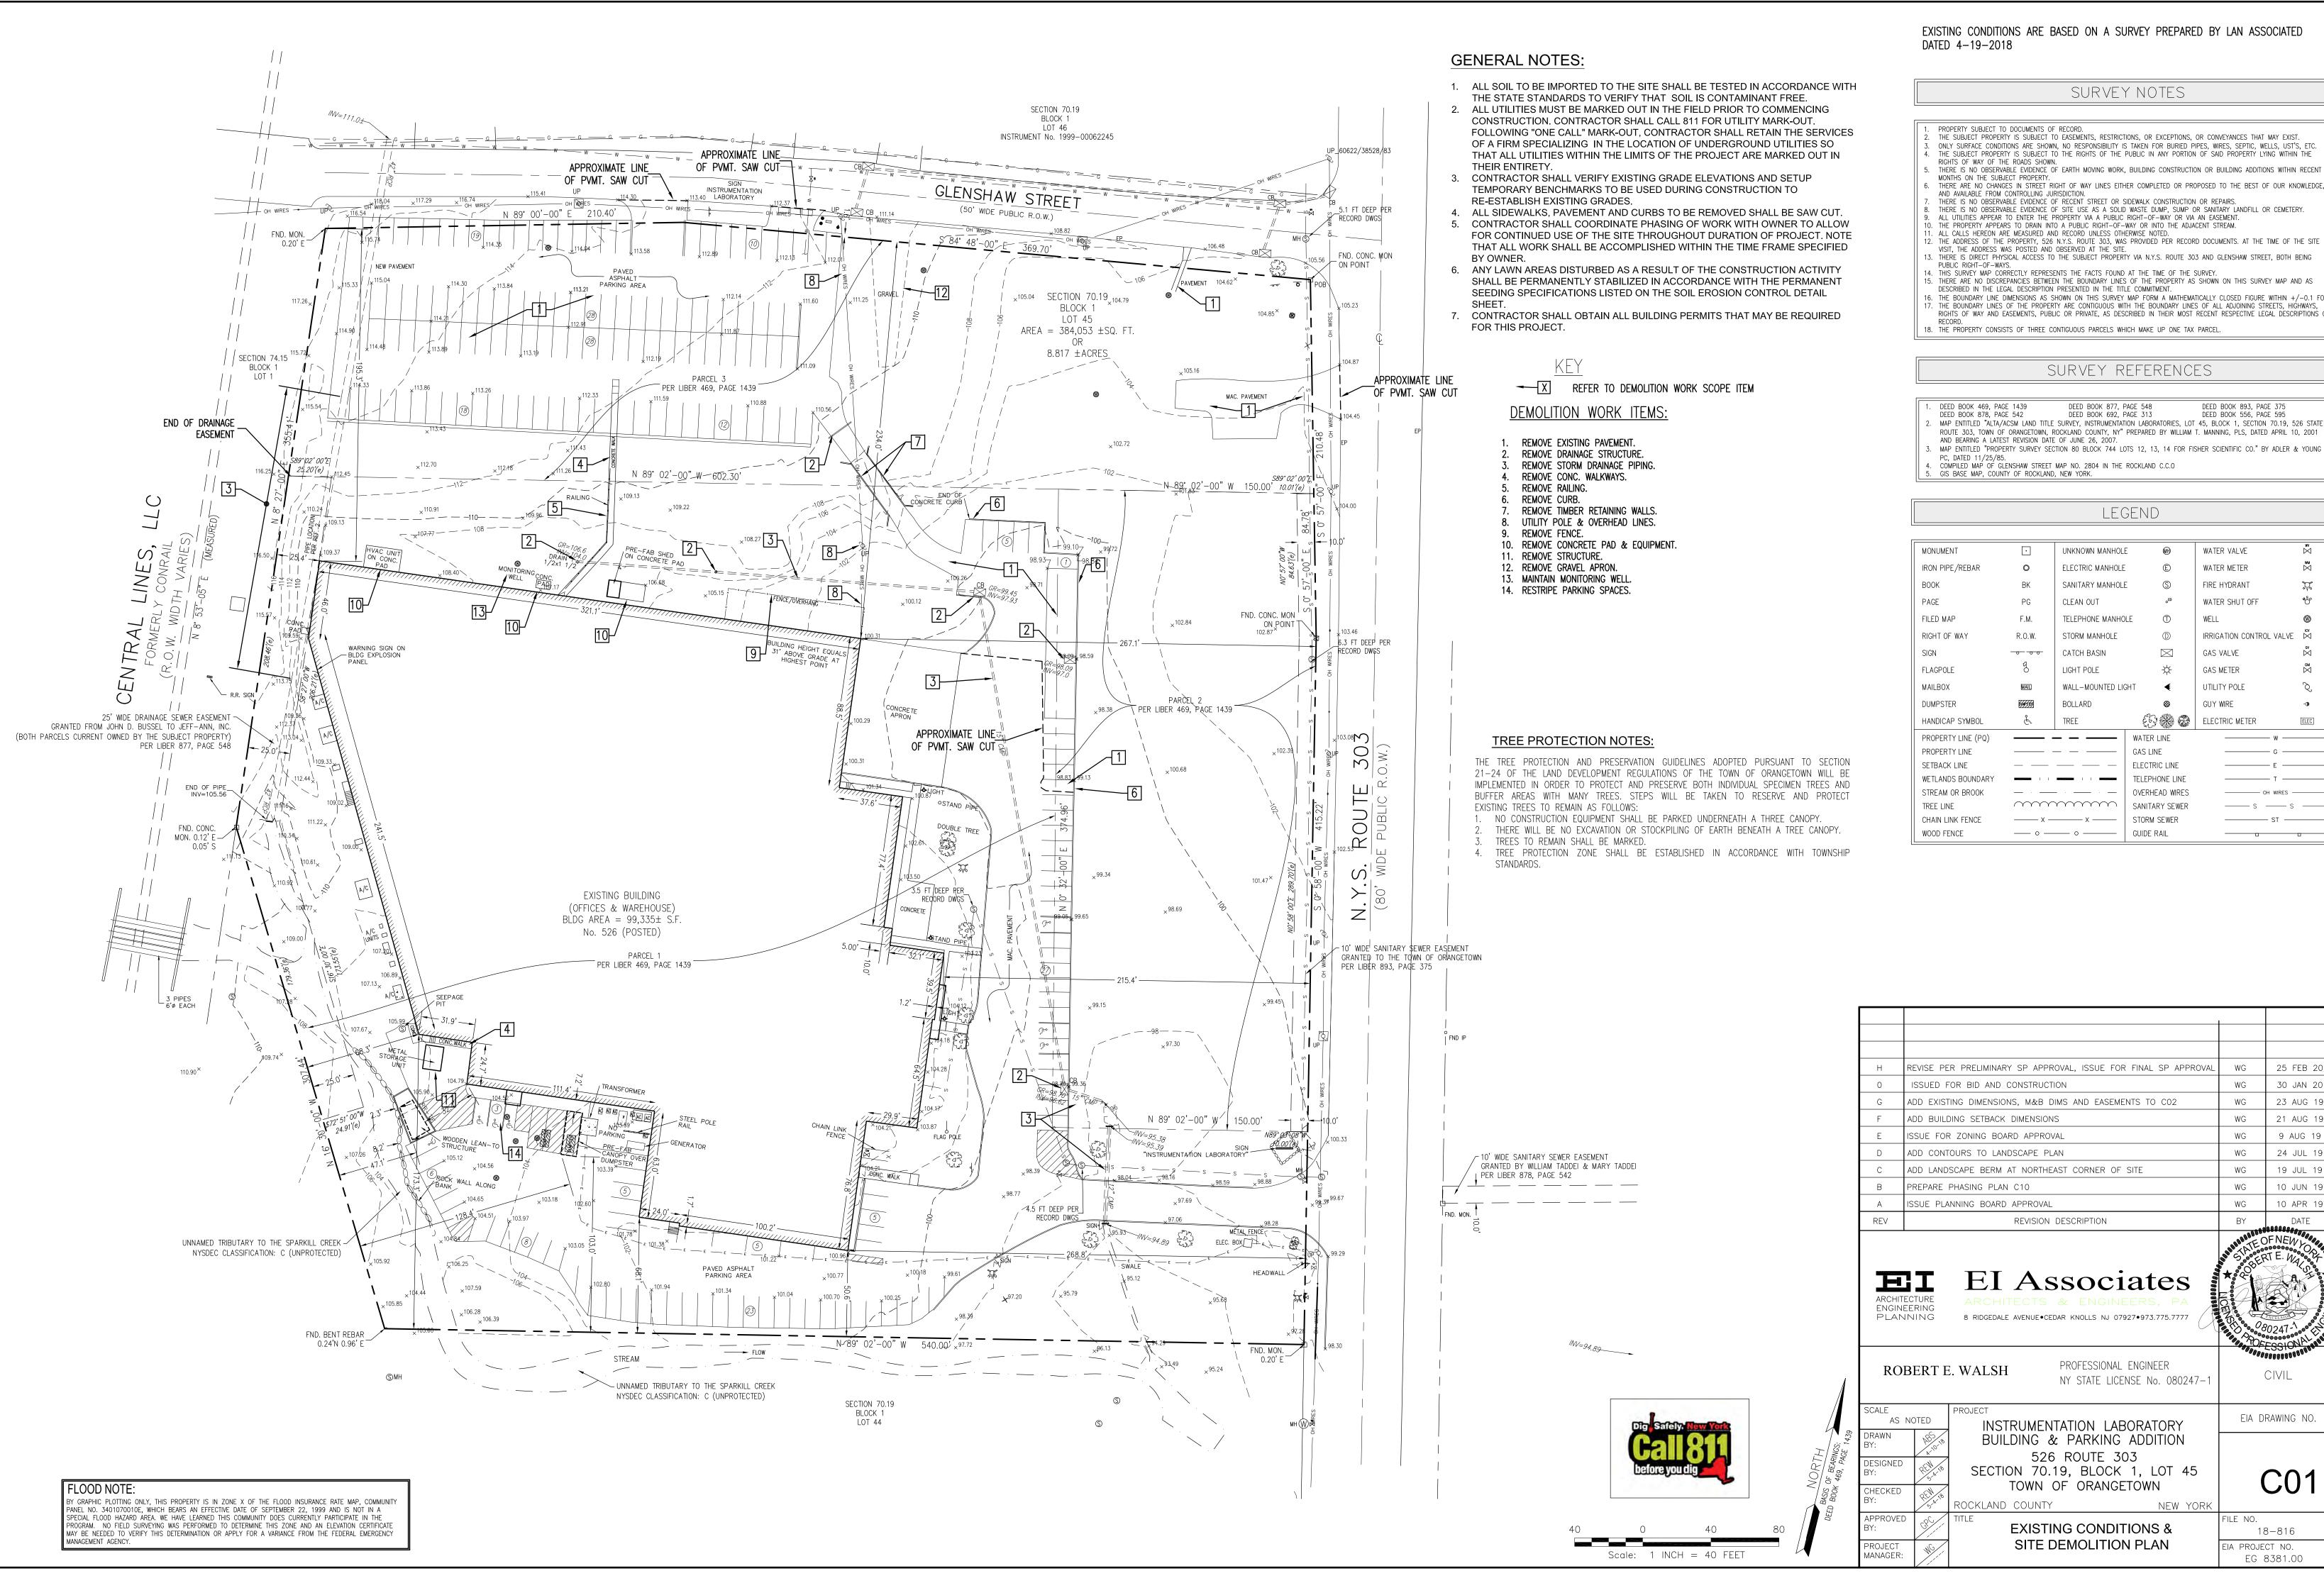

EXISTING CONDITIONS ARE BASED ON A SURVEY PREPARED BY LAN ASSOCIATED

- PROPERTY SUBJECT TO DOCUMENTS OF RECORD.
 THE SUBJECT PROPERTY IS SUBJECT TO EASEMENTS, RESTRICTIONS, OR EXCEPTIONS, OR CONVEYANCES THAT MAY EXIST. ONLY SURFACE CONDITIONS ARE SHOWN, NO RESPONSIBILITY IS TAKEN FOR BURIED PIPES, WIRES, SEPTIC, WELLS, UST'S, ETC. THE SUBJECT PROPERTY IS SUBJECT TO THE RIGHTS OF THE PUBLIC IN ANY PORTION OF SAID PROPERTY LYING WITHIN THE
- THERE IS NO OBSERVABLE EVIDENCE OF EARTH MOVING WORK, BUILDING CONSTRUCTION OR BUILDING ADDITIONS WITHIN RECENT
- . THERE ARE NO CHANGES IN STREET RIGHT OF WAY LINES EITHER COMPLETED OR PROPOSED TO THE BEST OF OUR KNOWLEDGE, AND AVAILABLE FROM CONTROLLING JURISDICTION. THERE IS NO OBSERVABLE EVIDENCE OF RECENT STREET OR SIDEWALK CONSTRUCTION OR REPAIRS.
- THERE IS NO OBSERVABLE EVIDENCE OF SITE USE AS A SOLID WASTE DUMP, SUMP OR SANITARY LANDFILL OR CEMETERY. ALL UTILITIES APPEAR TO ENTER THE PROPERTY VIA A PUBLIC RIGHT-OF-WAY OR VIA AN EASEMENT.
- 2. THE ADDRESS OF THE PROPERTY, 526 N.Y.S. ROUTE 303, WAS PROVIDED PER RECORD DOCUMENTS. AT THE TIME OF THE SITE
- 3. THERE IS DIRECT PHYSICAL ACCESS TO THE SUBJECT PROPERTY VIA N.Y.S. ROUTE 303 AND GLENSHAW STREET, BOTH BEING
- . THERE ARE NO DISCREPANCIES BETWEEN THE BOUNDARY LINES OF THE PROPERTY AS SHOWN ON THIS SURVEY MAP AND AS
- 6. THE BOUNDARY LINE DIMENSIONS AS SHOWN ON THIS SURVEY MAP FORM A MATHEMATICALLY CLOSED FIGURE WITHIN ± 1.00 FOOT
- THE BOUNDARY LINES OF THE PROPERTY ARE CONTIGUOUS WITH THE BOUNDARY LINES OF ALL ADJOINING STREETS, HIGHWAYS, RIGHTS OF WAY AND EASEMENTS, PUBLIC OR PRIVATE, AS DESCRIBED IN THEIR MOST RECENT RESPECTIVE LEGAL DESCRIPTIONS OF

- DEED BOOK 893, PAGE 375 DEED BOOK 556, PAGE 595 MAP ENTITLED "ALTA/ACSM LAND TITLE SURVEY, INSTRUMENTATION LABORATORIES, LOT 45, BLOCK 1, SECTION 70.19, 526 STATE
- ROUTE 303, TOWN OF ORANGETOWN, ROCKLAND COUNTY, NY" PREPARED BY WILLIAM T. MANNING, PLS, DATED APRIL 10, 2001

-						
	MONUMENT	•	UNKNOWN MANHOLE	W H	WATER VALVE	₩V ⊠
	IRON PIPE/REBAR	0	ELECTRIC MANHOLE	Ē	WATER METER	₩M ⊠
	BOOK	BK	SANITARY MANHOLE	S	FIRE HYDRANT	Ç
	PAGE	PG	CLEAN OUT	oco	WATER SHUT OFF	* S
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	DUMPSTER		BOLLARD	⊗	GUY WIRE	-0
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OVERHEAD WIRES ----- OH WIRES -----SANITARY SEWER

REVISE PER PRELIMINARY SP APPROVAL, ISSUE FOR FINAL SP APPROVAL 25 FEB 20 30 JAN 20 23 AUG 19 21 AUG 19 9 AUG 19 24 JUL 19 19 JUL 19 10 JUN 19 10 APR 19 DATE


NY STATE LICENSE No. 080247-

EIA DRAWING NO.

C01 NEW YORK FILE NO.

18-816 EIA PROJECT NO. EG 8381.00

CIVIL

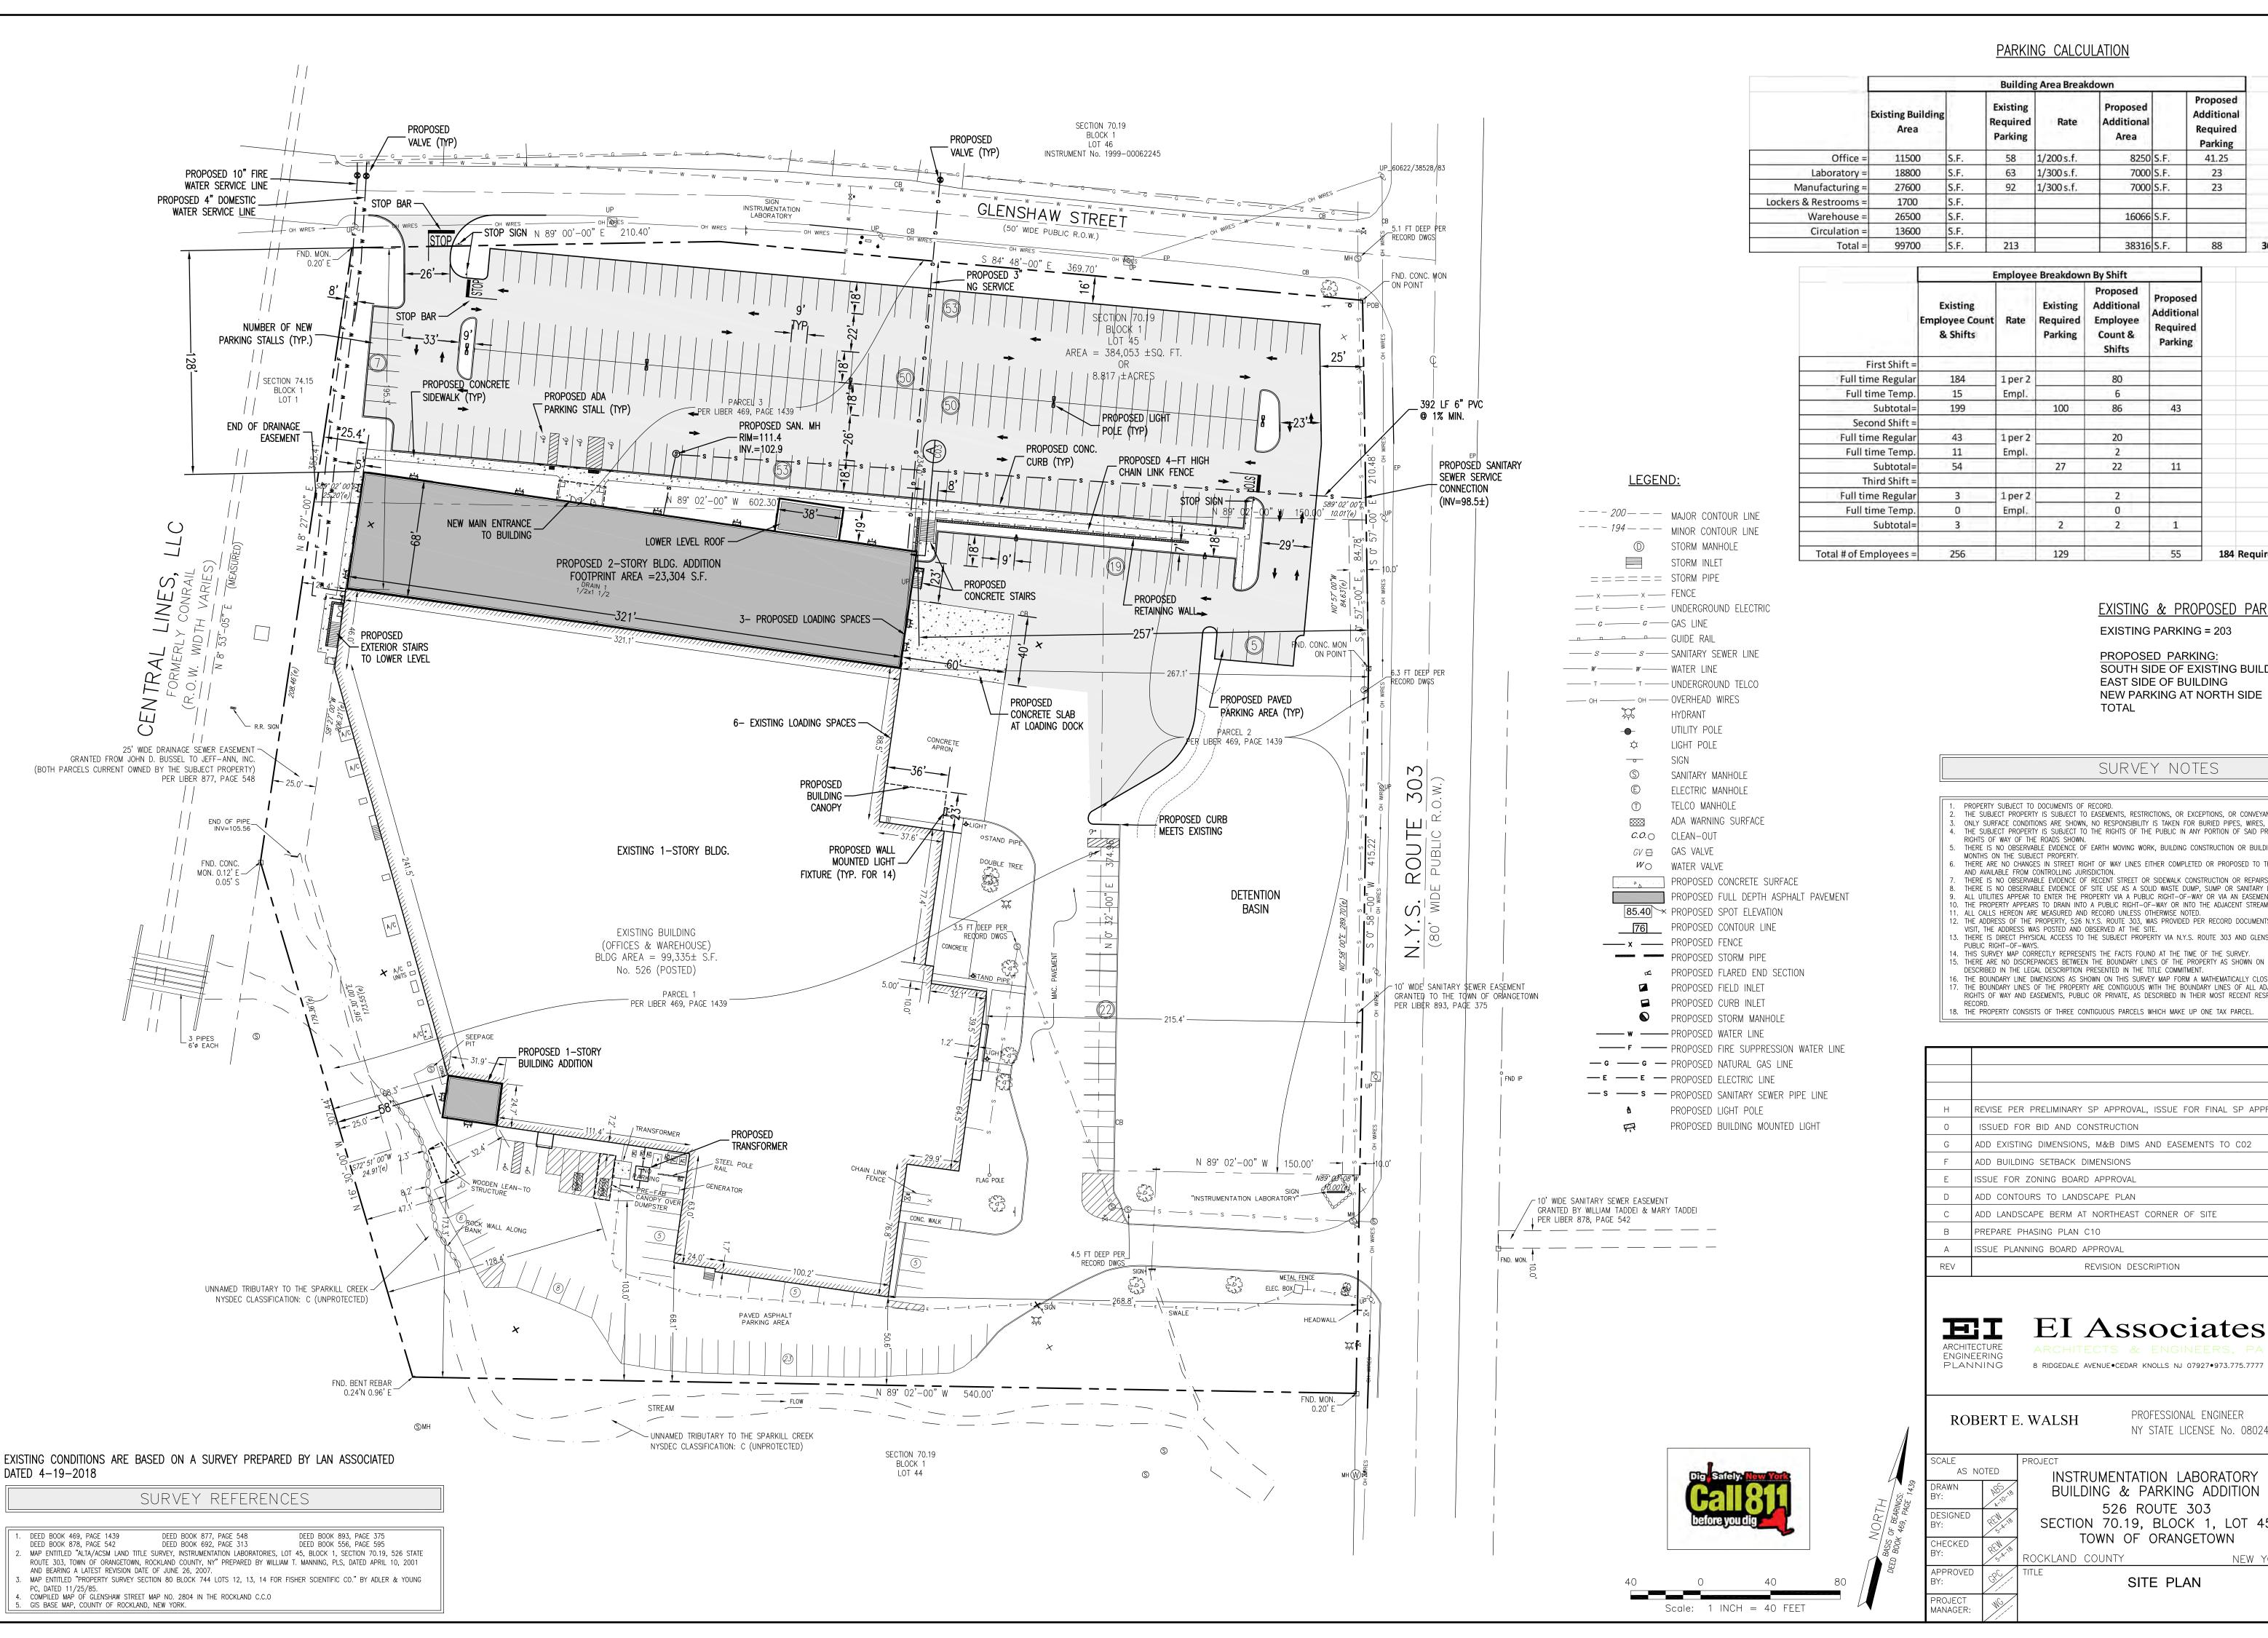

PARKING CALCULATION

	Building Area Breakdown								
	Existing Building Area		Existing Required Parking	Rate	Proposed Additional Area		Proposed Additional Required Parking		
Office =	11500	S.F.	58	1/200 s.f.	8250	S.F.	41.25		
Laboratory =	18800	S.F.	63	1/300 s.f.	7000	S.F.	23		
Manufacturing =	27600	S,F.	92	1/300 s.f.	7000	S.F.	23		
Lockers & Restrooms =	1700	S.F.							
Warehouse =	26500	S.F.			16066	S.F.			
Circulation =	13600	S.F.							
Total =	99700	S.F.	213		38316	S.F.	88	301	Required Spaces

	E	Employee Breakdown By Shift						
	Existing Employee Count & Shifts	Rate	Existing Required Parking	Proposed Additional Employee Count & Shifts	Proposed Additional Required Parking			
First Shift =								
Full time Regular	184	1per 2		80				
Full time Temp.	15	Empl.		6				
Subtotal=	199		100	86	43			
Second Shift =								
Full time Regular	43	1per 2		20				
Full time Temp.	11	Empl.		2				
Subtotal=	54		27	22	11			
Third Shift =								
Full time Regular	3	1 per 2		2	h			
Full time Temp.	0	Empl.		0				
Subtotal=	3	7 3-1	2	2	1			
Total # of Employees =	256		129		55	184	Required Space	25

EXISTING & PROPOSED PARKING EXISTING PARKING = 203

PROPOSED PARKING: SOUTH SIDE OF EXISTING BUILDING EAST SIDE OF BUILDING

= 54 SPACES NEW PARKING AT NORTH SIDE TOTAL

= 22 SPACES = 237 SPACES = 313 SPACES

SURVEY NOTES

- PROPERTY SUBJECT TO DOCUMENTS OF RECORD. THE SUBJECT PROPERTY IS SUBJECT TO EASEMENTS, RESTRICTIONS, OR EXCEPTIONS, OR CONVEYANCES THAT MAY EXIST
- ONLY SURFACE CONDITIONS ARE SHOWN, NO RESPONSIBILITY IS TAKEN FOR BURIED PIPES, WIRES, SEPTIC, WELLS, UST'S, ETC. THE SUBJECT PROPERTY IS SUBJECT TO THE RIGHTS OF THE PUBLIC IN ANY PORTION OF SAID PROPERTY LYING WITHIN THE
- THERE IS NO OBSERVABLE EVIDENCE OF EARTH MOVING WORK, BUILDING CONSTRUCTION OR BUILDING ADDITIONS WITHIN RECENT
- THERE ARE NO CHANGES IN STREET RIGHT OF WAY LINES EITHER COMPLETED OR PROPOSED TO THE BEST OF OUR KNOWLEDGE, AND AVAILABLE FROM CONTROLLING JURISDICTION. THERE IS NO OBSERVABLE EVIDENCE OF RECENT STREET OR SIDEWALK CONSTRUCTION OR REPAIRS.
- THERE IS NO OBSERVABLE EVIDENCE OF SITE USE AS A SOLID WASTE DUMP, SUMP OR SANITARY LANDFILL OR CEMETERY.
 ALL UTILITIES APPEAR TO ENTER THE PROPERTY VIA A PUBLIC RIGHT-OF-WAY OR VIA AN EASEMENT.
 THE PROPERTY APPEARS TO DRAIN INTO A PUBLIC RIGHT-OF-WAY OR INTO THE ADJACENT STREAM.
- ALL CALLS HEREON ARE MEASURED AND RECORD UNLESS OTHERWISE NOTED.
- THE ADDRESS OF THE PROPERTY, 526 N.Y.S. ROUTE 303, WAS PROVIDED PER RECORD DOCUMENTS. AT THE TIME OF THE SITE VISIT, THE ADDRESS WAS POSTED AND OBSERVED AT THE SITE.
- 3. THERE IS DIRECT PHYSICAL ACCESS TO THE SUBJECT PROPERTY VIA N.Y.S. ROUTE 303 AND GLENSHAW STREET, BOTH BEING
- 4. THIS SURVEY MAP CORRECTLY REPRESENTS THE FACTS FOUND AT THE TIME OF THE SURVEY. . THERE ARE NO DISCREPANCIES BETWEEN THE BOUNDARY LINES OF THE PROPERTY AS SHOWN ON THIS SURVEY MAP AND AS
- DESCRIBED IN THE LEGAL DESCRIPTION PRESENTED IN THE TITLE COMMITMENT. THE BOUNDARY LINE DIMENSIONS AS SHOWN ON THIS SURVEY MAP FORM A MATHEMATICALLY CLOSED FIGURE WITHIN +/-0.1 FOOT.
- . THE BOUNDARY LINES OF THE PROPERTY ARE CONTIGUOUS WITH THE BOUNDARY LINES OF ALL ADJOINING STREETS, HIGHWAYS, RIGHTS OF WAY AND EASEMENTS, PUBLIC OR PRIVATE, AS DESCRIBED IN THEIR MOST RECENT RESPECTIVE LEGAL DESCRIPTIONS OF
- 18. THE PROPERTY CONSISTS OF THREE CONTIGUOUS PARCELS WHICH MAKE UP ONE TAX PARCEL.

		1	
Н	REVISE PER PRELIMINARY SP APPROVAL, ISSUE FOR FINAL SP APPROVAL	WG	25 FEB 20
0	ISSUED FOR BID AND CONSTRUCTION	WG	30 JAN 20
G	ADD EXISTING DIMENSIONS, M&B DIMS AND EASEMENTS TO CO2	WG	23 AUG 19
F	ADD BUILDING SETBACK DIMENSIONS	WG	21 AUG 19
Е	ISSUE FOR ZONING BOARD APPROVAL	WG	9 AUG 19
D	ADD CONTOURS TO LANDSCAPE PLAN	WG	24 JUL 19
С	ADD LANDSCAPE BERM AT NORTHEAST CORNER OF SITE	WG	19 JUL 19
В	PREPARE PHASING PLAN C10	WG	10 JUN 19
А	ISSUE PLANNING BOARD APPROVAL	WG	10 APR 19
REV	REVISION DESCRIPTION	BY	DATE

EI Associates

PROFESSIONAL ENGINEER NY STATE LICENSE No. 080247-

EIA DRAWING NO.


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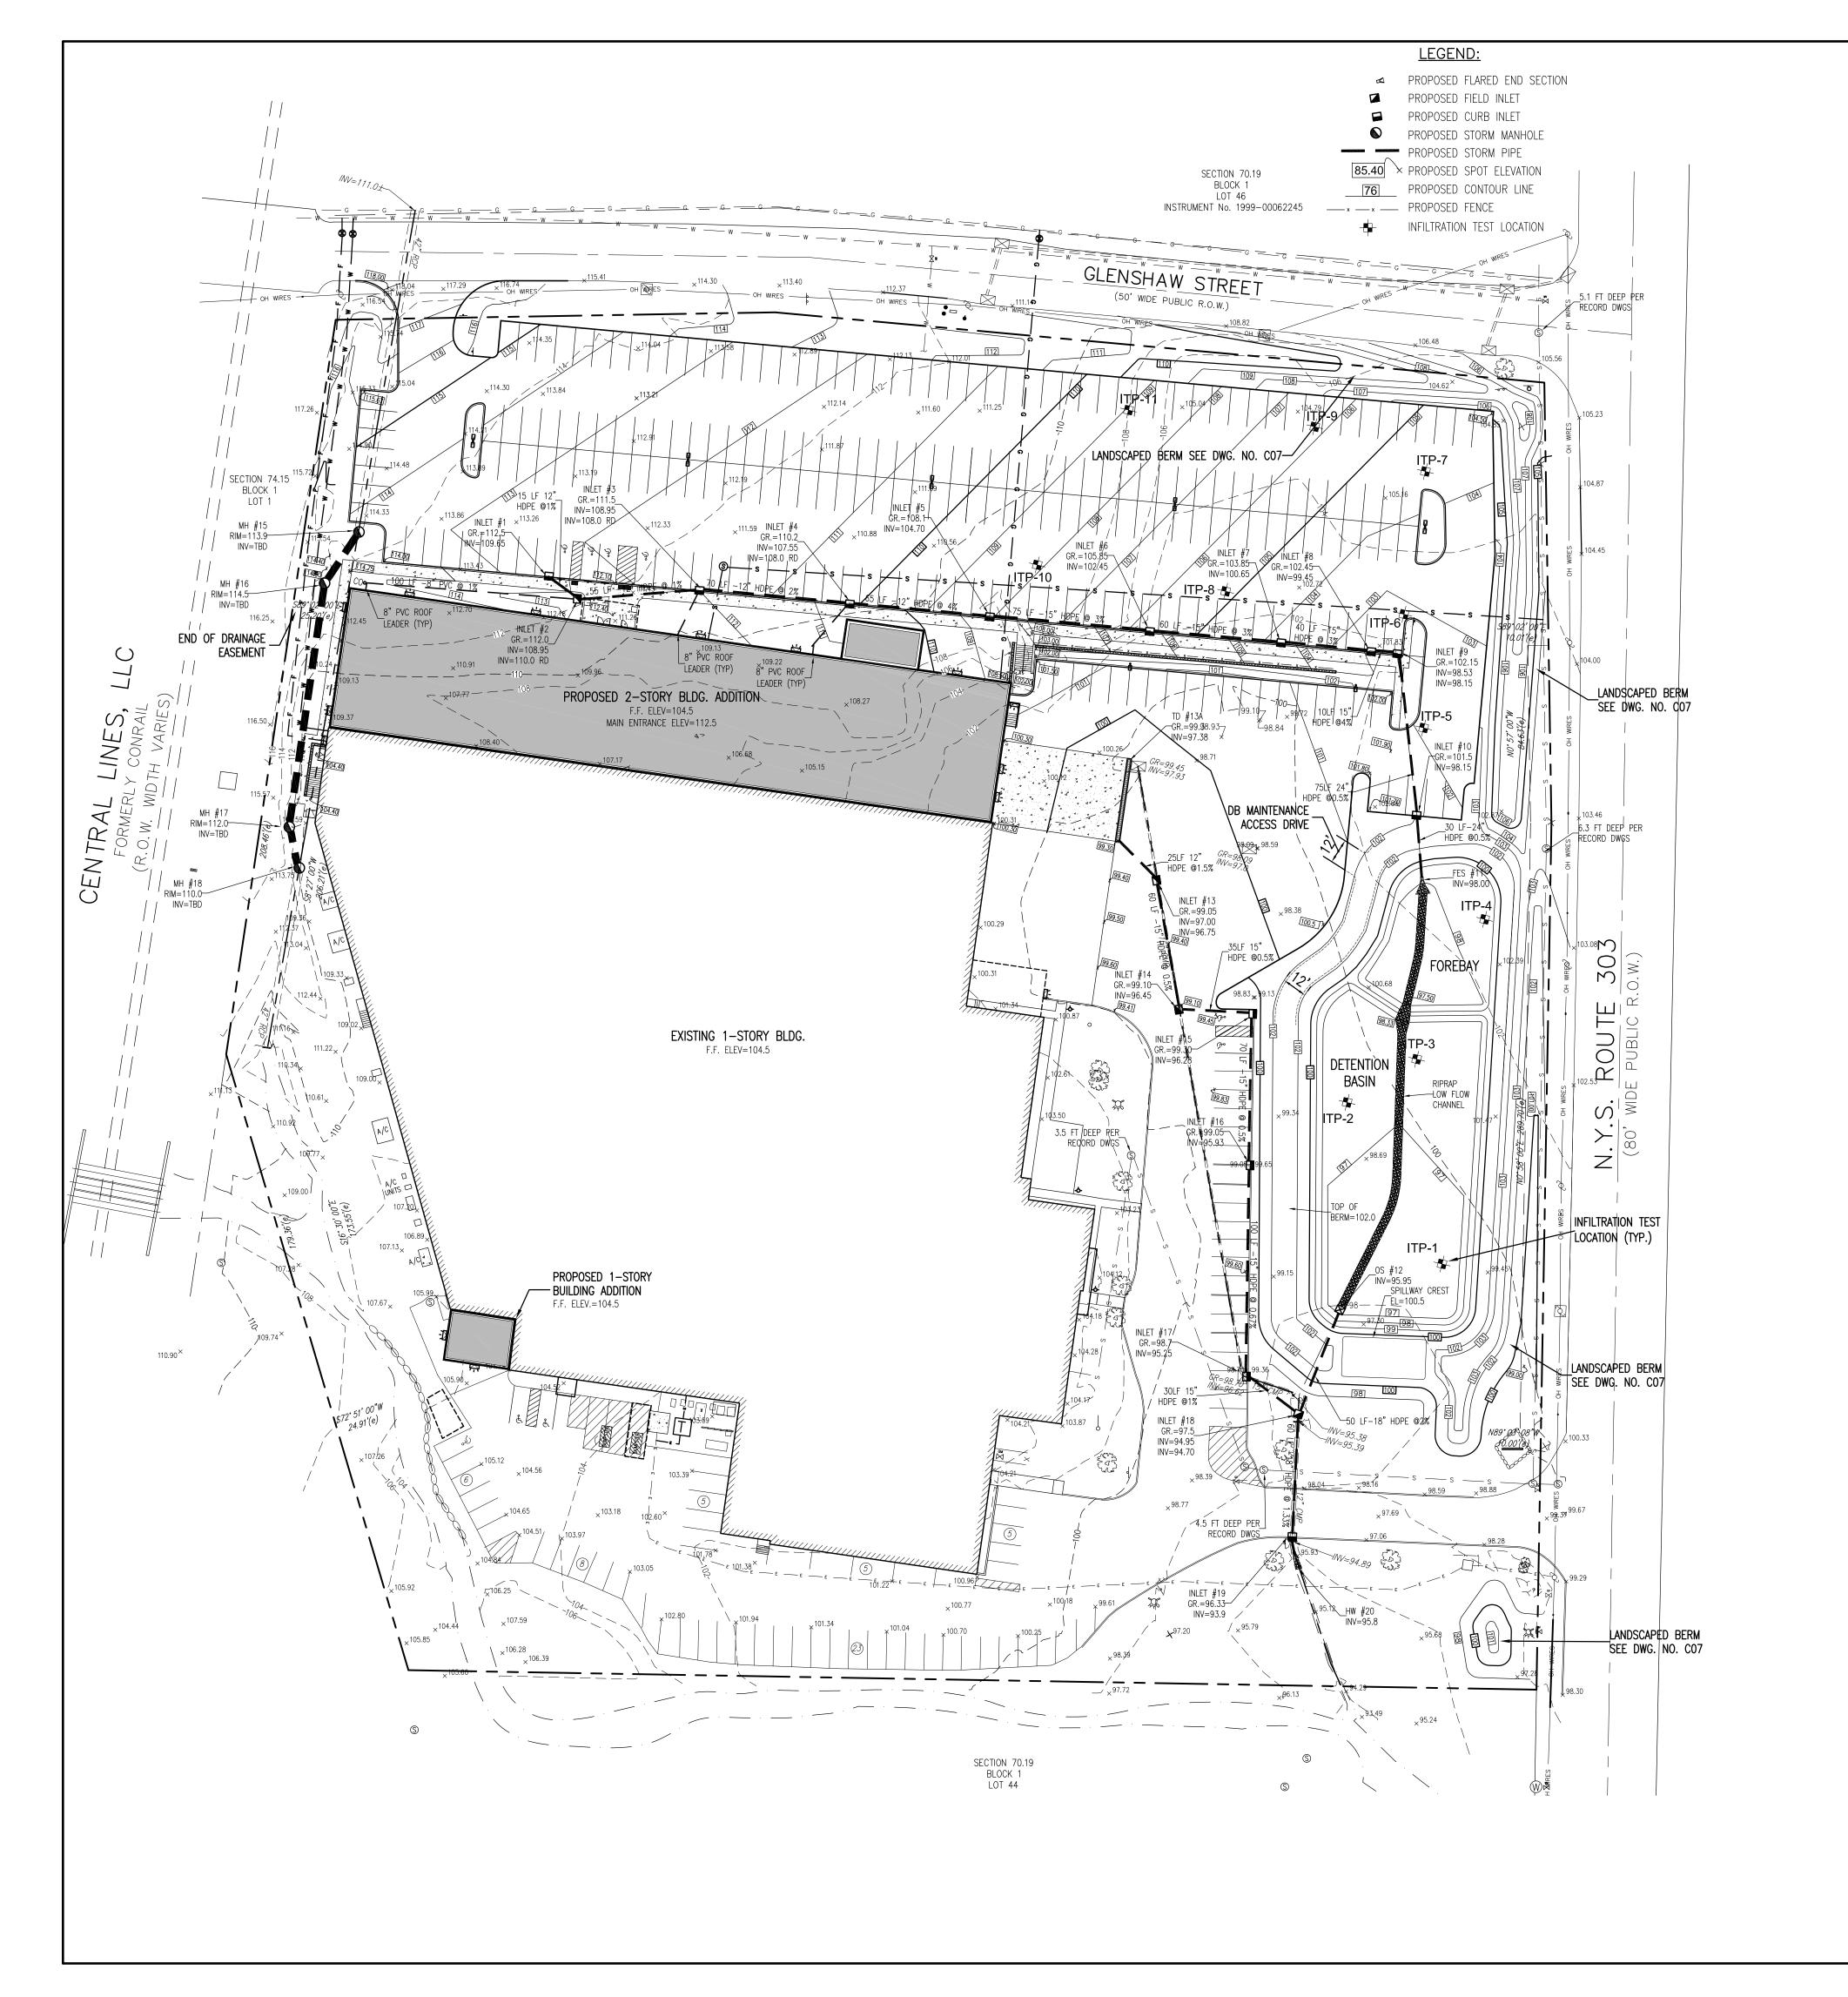
C02

INSTRUMENTATION LABORATORY BUILDING & PARKING ADDITION 526 ROUTE 303 SECTION 70.19, BLOCK 1, LOT 45 TOWN OF ORANGETOWN ROCKLAND COUNTY

NEW YORK SITE PLAN

FILE NO. 18-816 EIA PROJECT NO. EG 8381.00



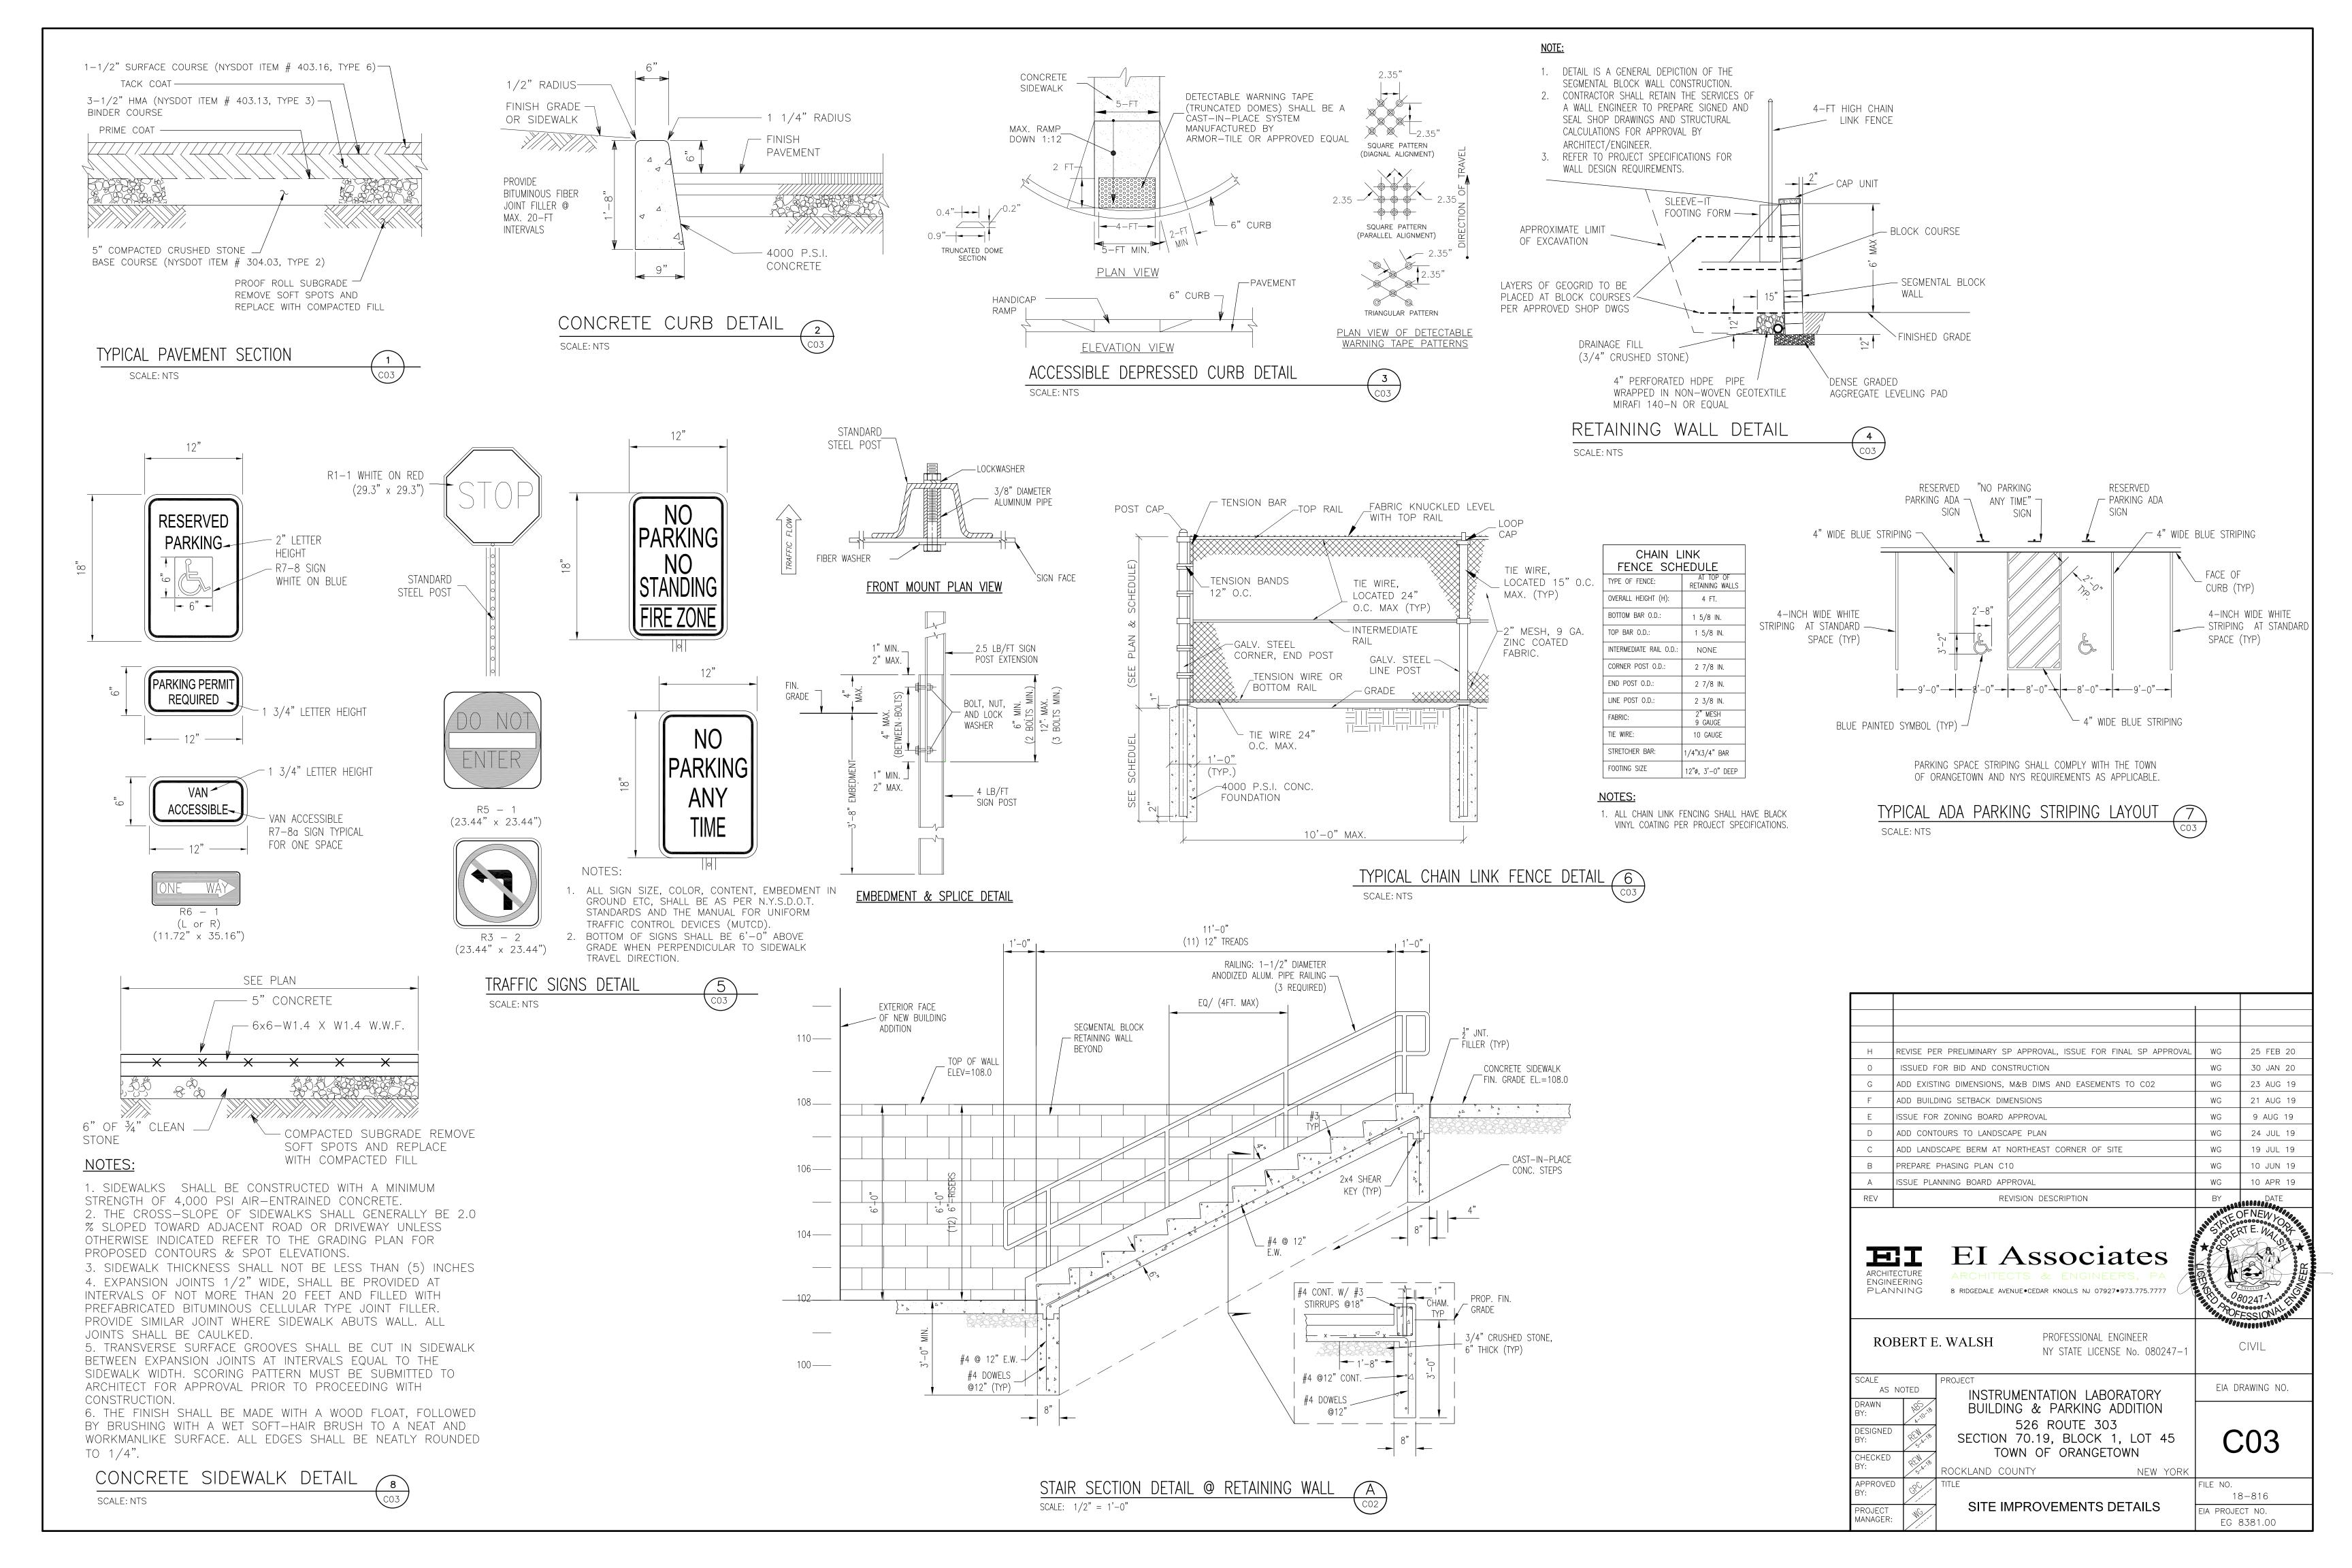

INFILTRATION TEST TABLE

ITP NO.	EXISTING GRADE	PROPOSED GRADE	BOTT. OF TEST PIT	DEPTH TO GW.	GWE	PERMEABILITY
1	99.0	96.9	89.0	NE	<89.0	13"/hr @ 4 ft
2	98.0	97.5	93.0	NE	<93.0	16"/hr @ 5 ft
3	100.0	97.5	90.0	9'-6"	90.5	10"/hr @ 6 ft
4	102.0	99.0	93.0	8'-0"	94.0	3"/hr @ 5 ft
5	103.0	102.5	95.0	NE	<95.0	5"/hr @ 5 ft
6	103.0	103.0	93.0	8'-0"	95.0	20"/hr @ 6 ft
7	105.0	104.5	95.0	8'-0"	97.0	24"/hr @ 6 ft
8	103.0	106.0	93.0	NE	<93.0	16"/hr @ 5 ft
9	105.0	106.5	95.0	8'-0"	97.0	2"/hr @ 4 ft
10	109.0	109.0	99.0	9'-0"	100.0	18"/hr @ 6 ft
11	109.0	110.0	99.0	5'-0"	104.0	6"/hr @ 6 ft

STORMWATER MANAGMENT NOTES:

1. STORMWATER MANAGEMENT PHASE II REGULATIONS: ADDITIONAL CERTIFICATION, BY AN APPROPRIATE LICENSED OR CERTIFIED DESIGN PROFESSIONAL SHALL BE REQUIRED FOR ALL MATTERS BEFORE THE PLANNING BOARD INDICATING THAT THE DRAWINGS AND PROJECT ARE IN COMPLIANCE WITH THE STORMWATER MANAGEMENT PHASE II REGULATIONS.

		1	
Н	REVISE PER PRELIMINARY SP APPROVAL, ISSUE FOR FINAL SP APPROVAL	WG	25 FEB 20
0	ISSUED FOR BID AND CONSTRUCTION	WG	30 JAN 20
G	ADD EXISTING DIMENSIONS, M&B DIMS AND EASEMENTS TO CO2	WG	23 AUG 19
F	ADD BUILDING SETBACK DIMENSIONS	WG	21 AUG 19
Е	ISSUE FOR ZONING BOARD APPROVAL	WG	9 AUG 19
D	ADD CONTOURS TO LANDSCAPE PLAN	WG	24 JUL 19
С	ADD LANDSCAPE BERM AT NORTHEAST CORNER OF SITE	WG	19 JUL 19
В	PREPARE PHASING PLAN C10	WG	10 JUN 19
А	ISSUE PLANNING BOARD APPROVAL	WG	10 APR 19
REV	REVISION DESCRIPTION	BY	DATE

ARCHITECTURE EI Associates ENGINEERING PLANNING

PROJECT MANAGER:

8 RIDGEDALE AVENUE • CEDAR KNOLLS NJ 07927 • 973.775.7777

PROFESSIONAL ENGINEER ROBERT E. WALSH NY STATE LICENSE No. 080247-1

EIA DRAWING NO.


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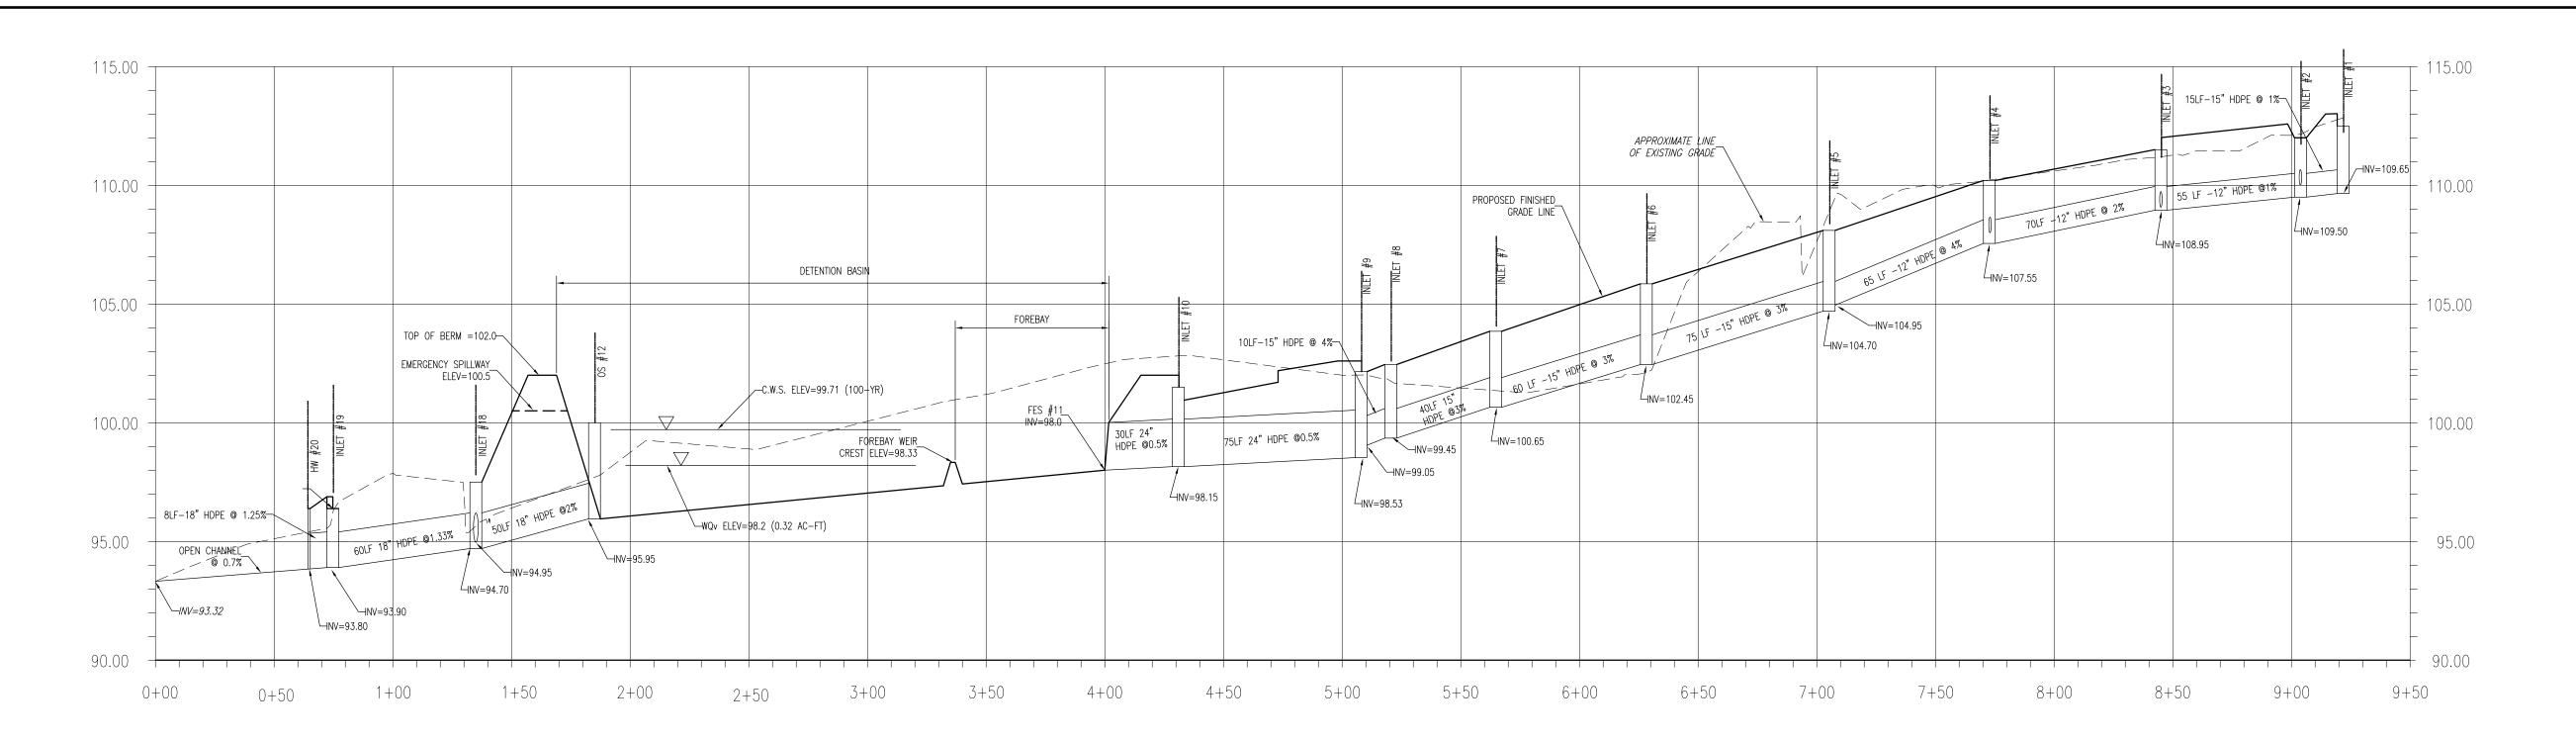
C04

AS NOTED INSTRUMENTATION LABORATORY BUILDING & PARKING ADDITION 526 ROUTE 303 SECTION 70.19, BLOCK 1, LOT 45 TOWN OF ORANGETOWN ROCKLAND COUNTY APPROVED


GRADING & DRAINAGE PLAN


FILE NO. 18-816 EIA PROJECT NO. EG 8381.00



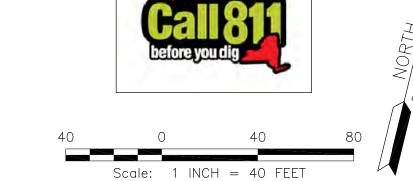


STORM DRAINAGE PROFILE (INLET #1 TO HW #20)

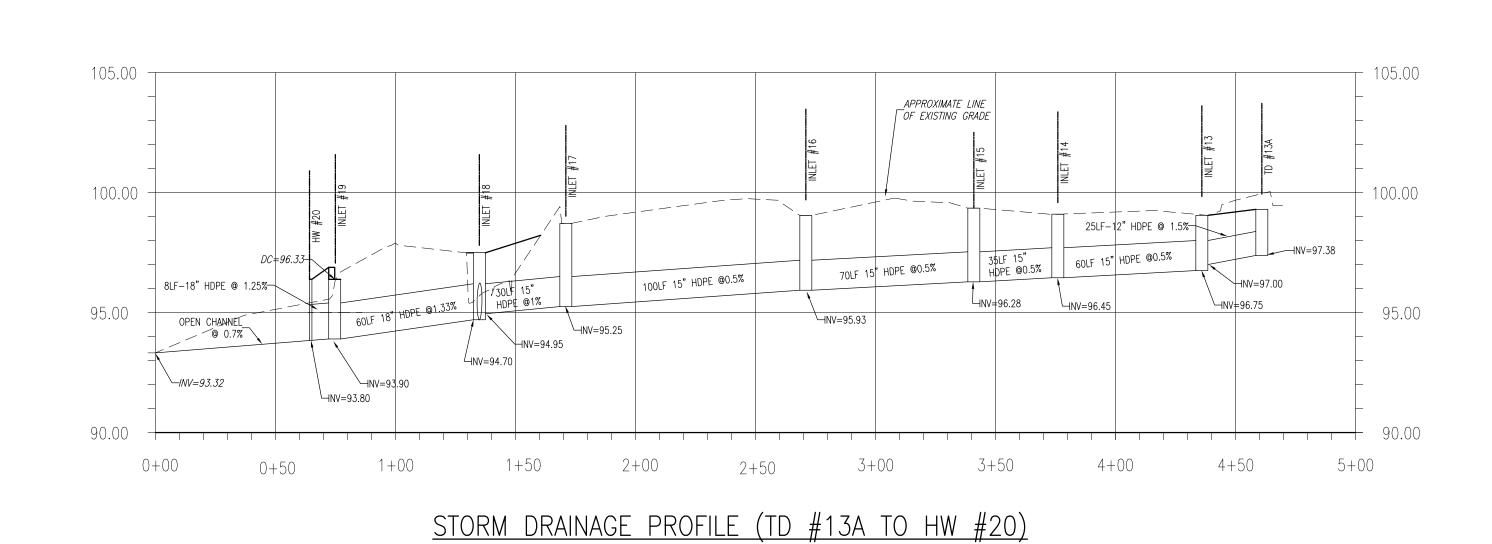

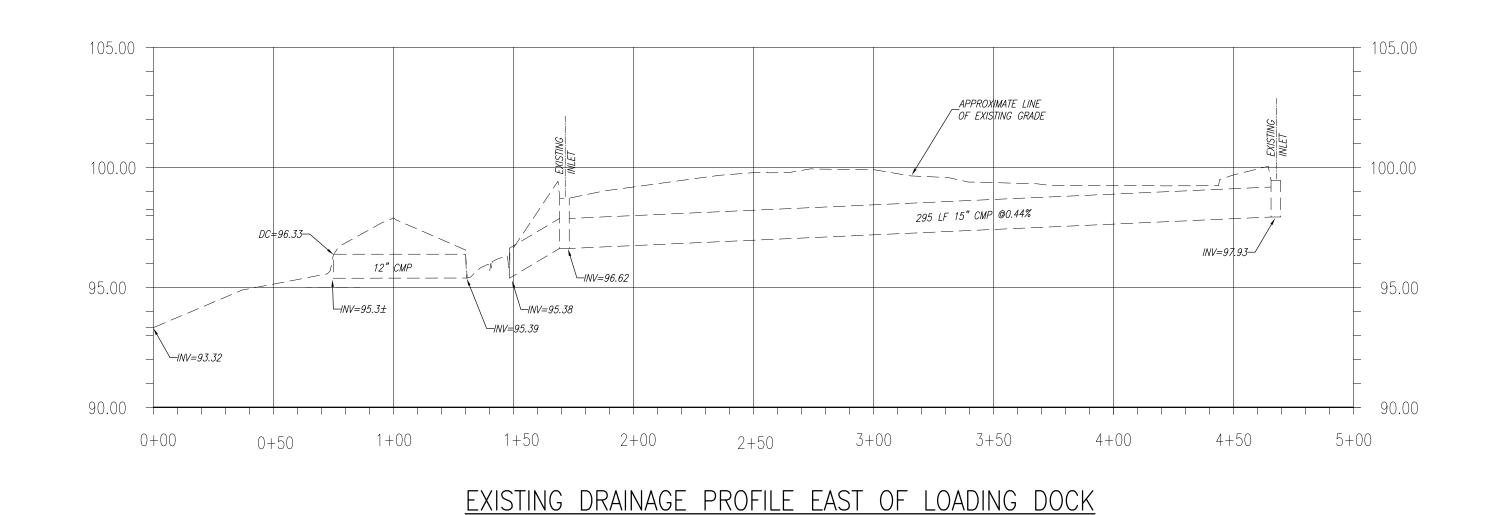

VERTICAL SCALE: 1 INCH = 4 FEET HORIZONTAL SCALE: 1 INCH = 40 FEET

1.1	DEVISE DED DDELIMINADY OD ADDDOVAL ISSUE FOR FINAL OD ADDDOVAL	W.C	25 550 20
Н О	REVISE PER PRELIMINARY SP APPROVAL, ISSUE FOR FINAL SP APPROVAL ISSUED FOR BID AND CONSTRUCTION	WG WG	25 FEB 20 30 JAN 20
G	ADD EXISTING DIMENSIONS, M&B DIMS AND EASEMENTS TO CO2	WG	23 AUG 19
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Α	ISSUE PLANNING BOARD APPROVAL	WG	10 APR 19
REV	REVISION DESCRIPTION	BY	DATE DATE
		999995E)FNEW YOU

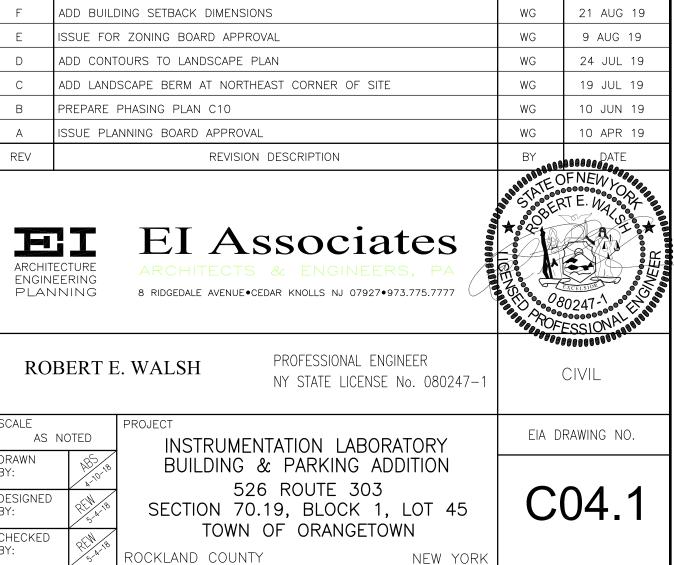

DRAINAGE PROFILES


APPROVED


PROJECT MANAGER:


FILE NO.


18-816

EIA PROJECT NO. EG 8381.00

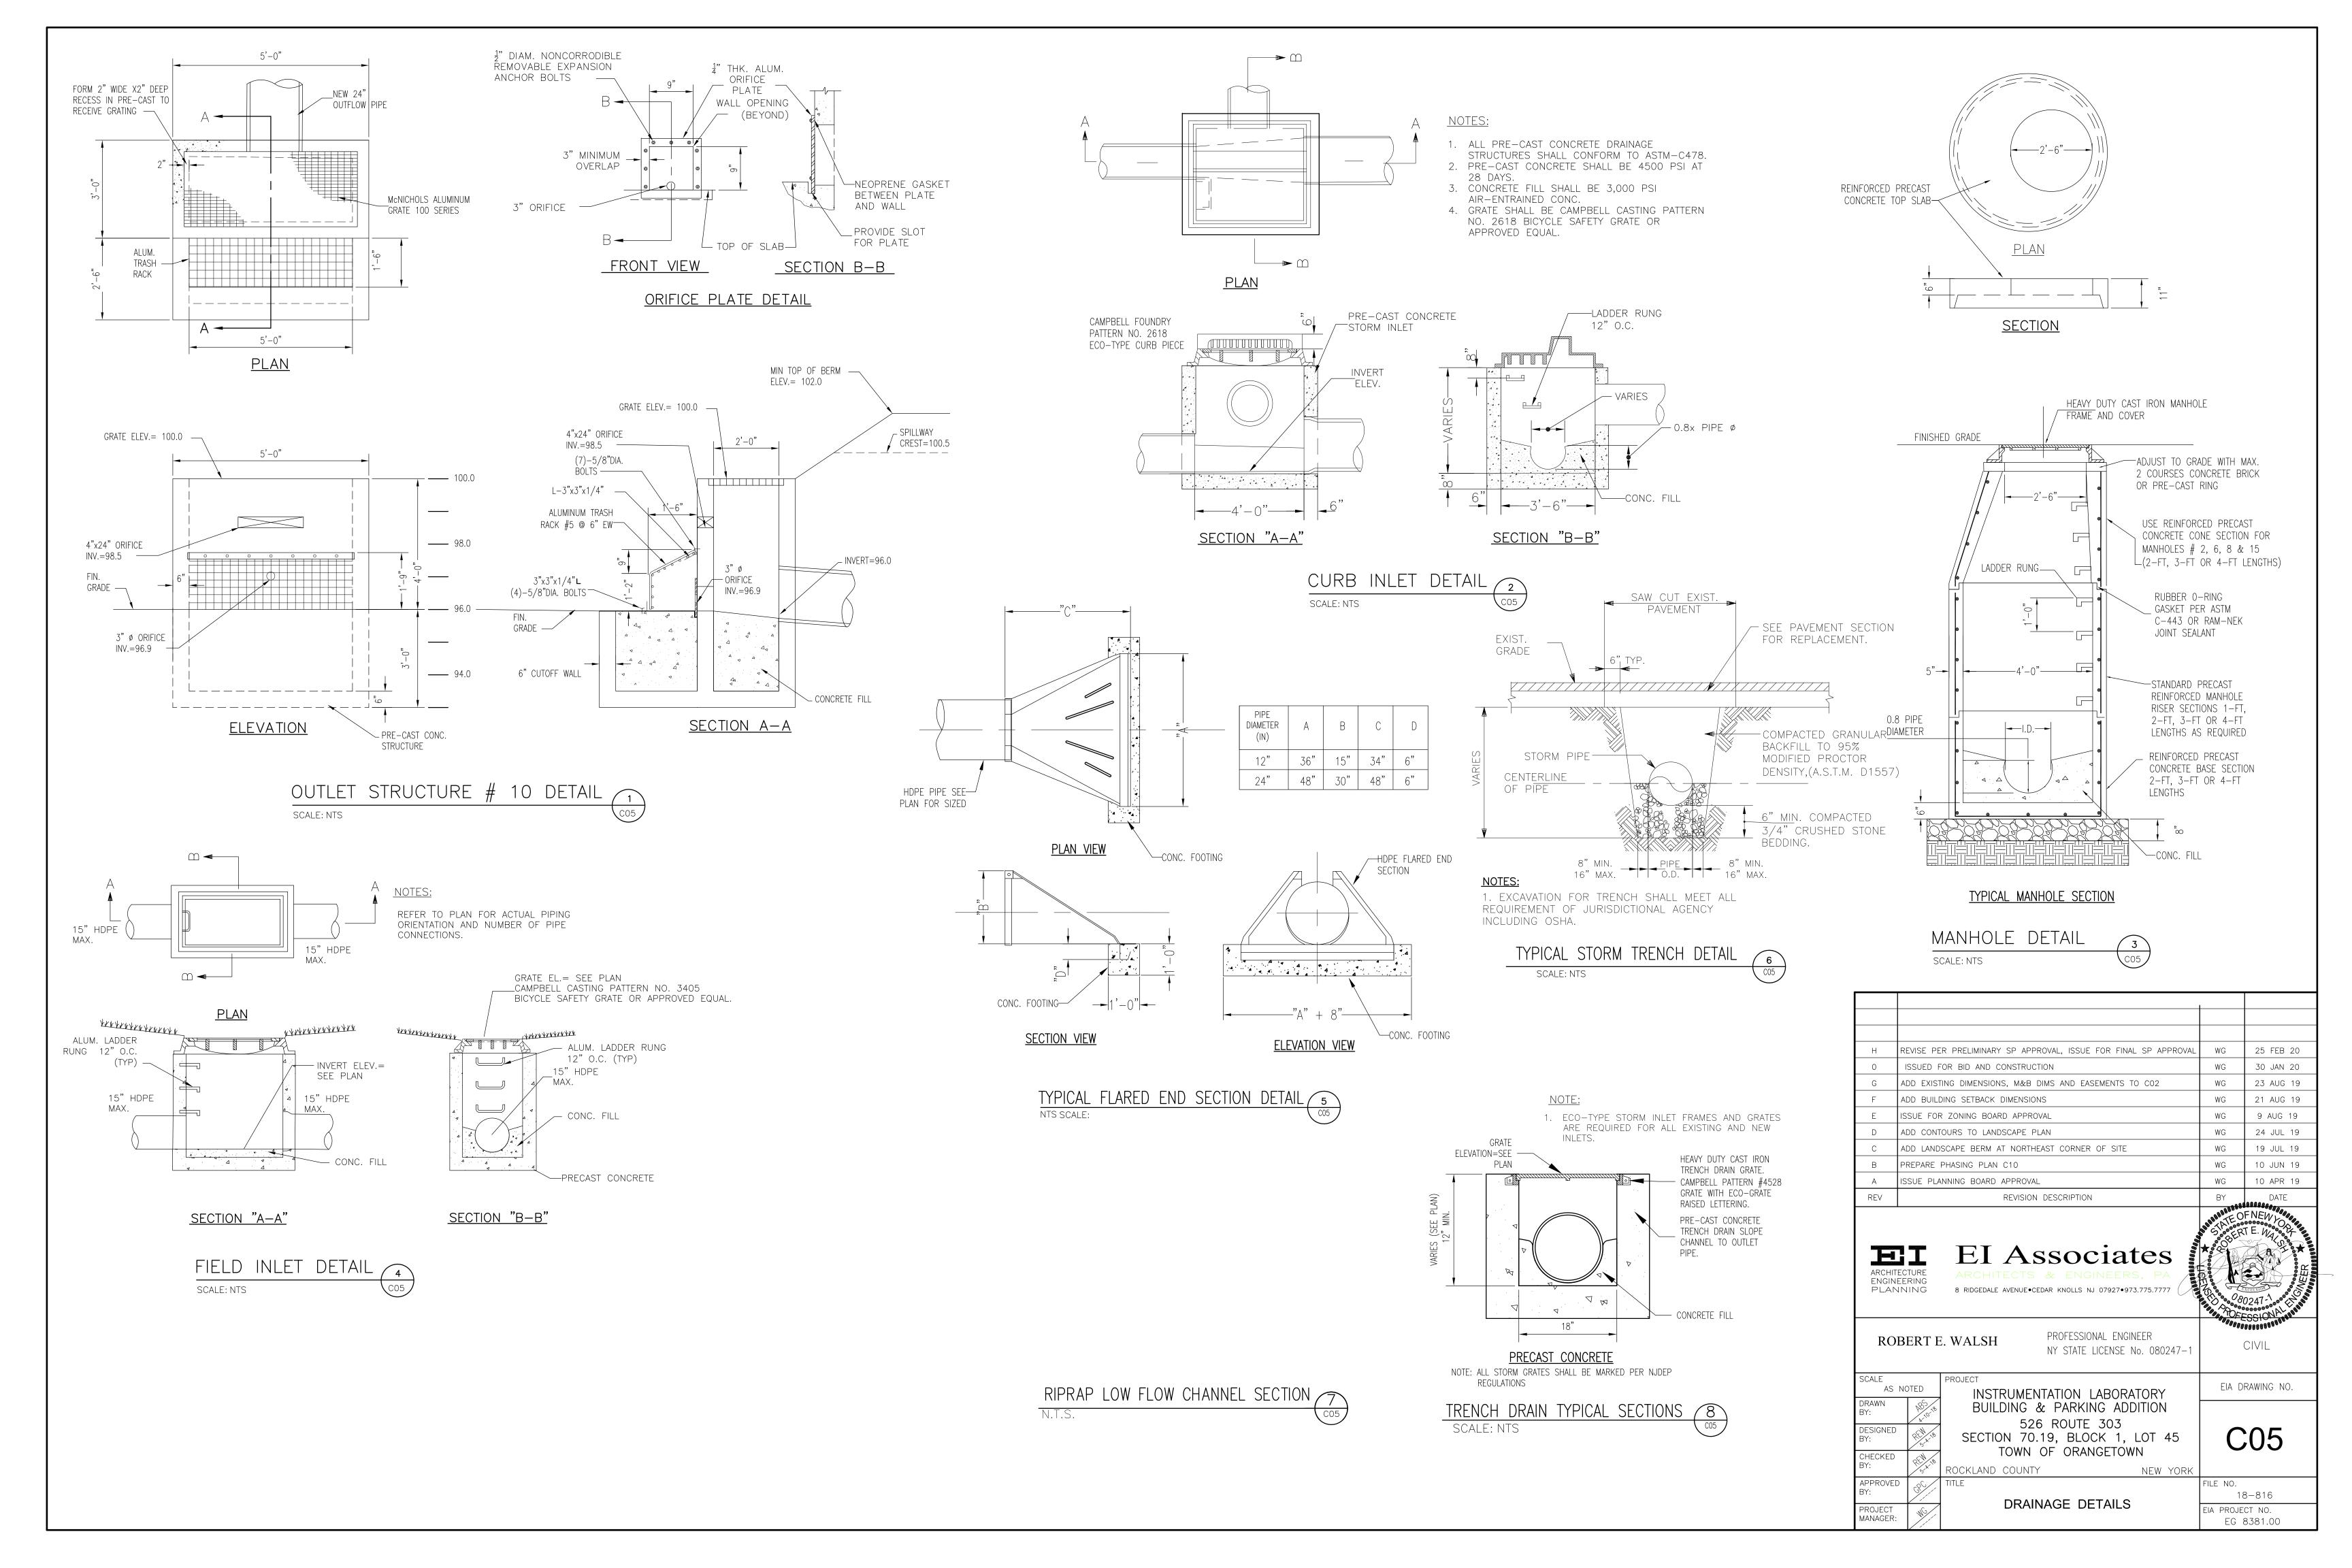

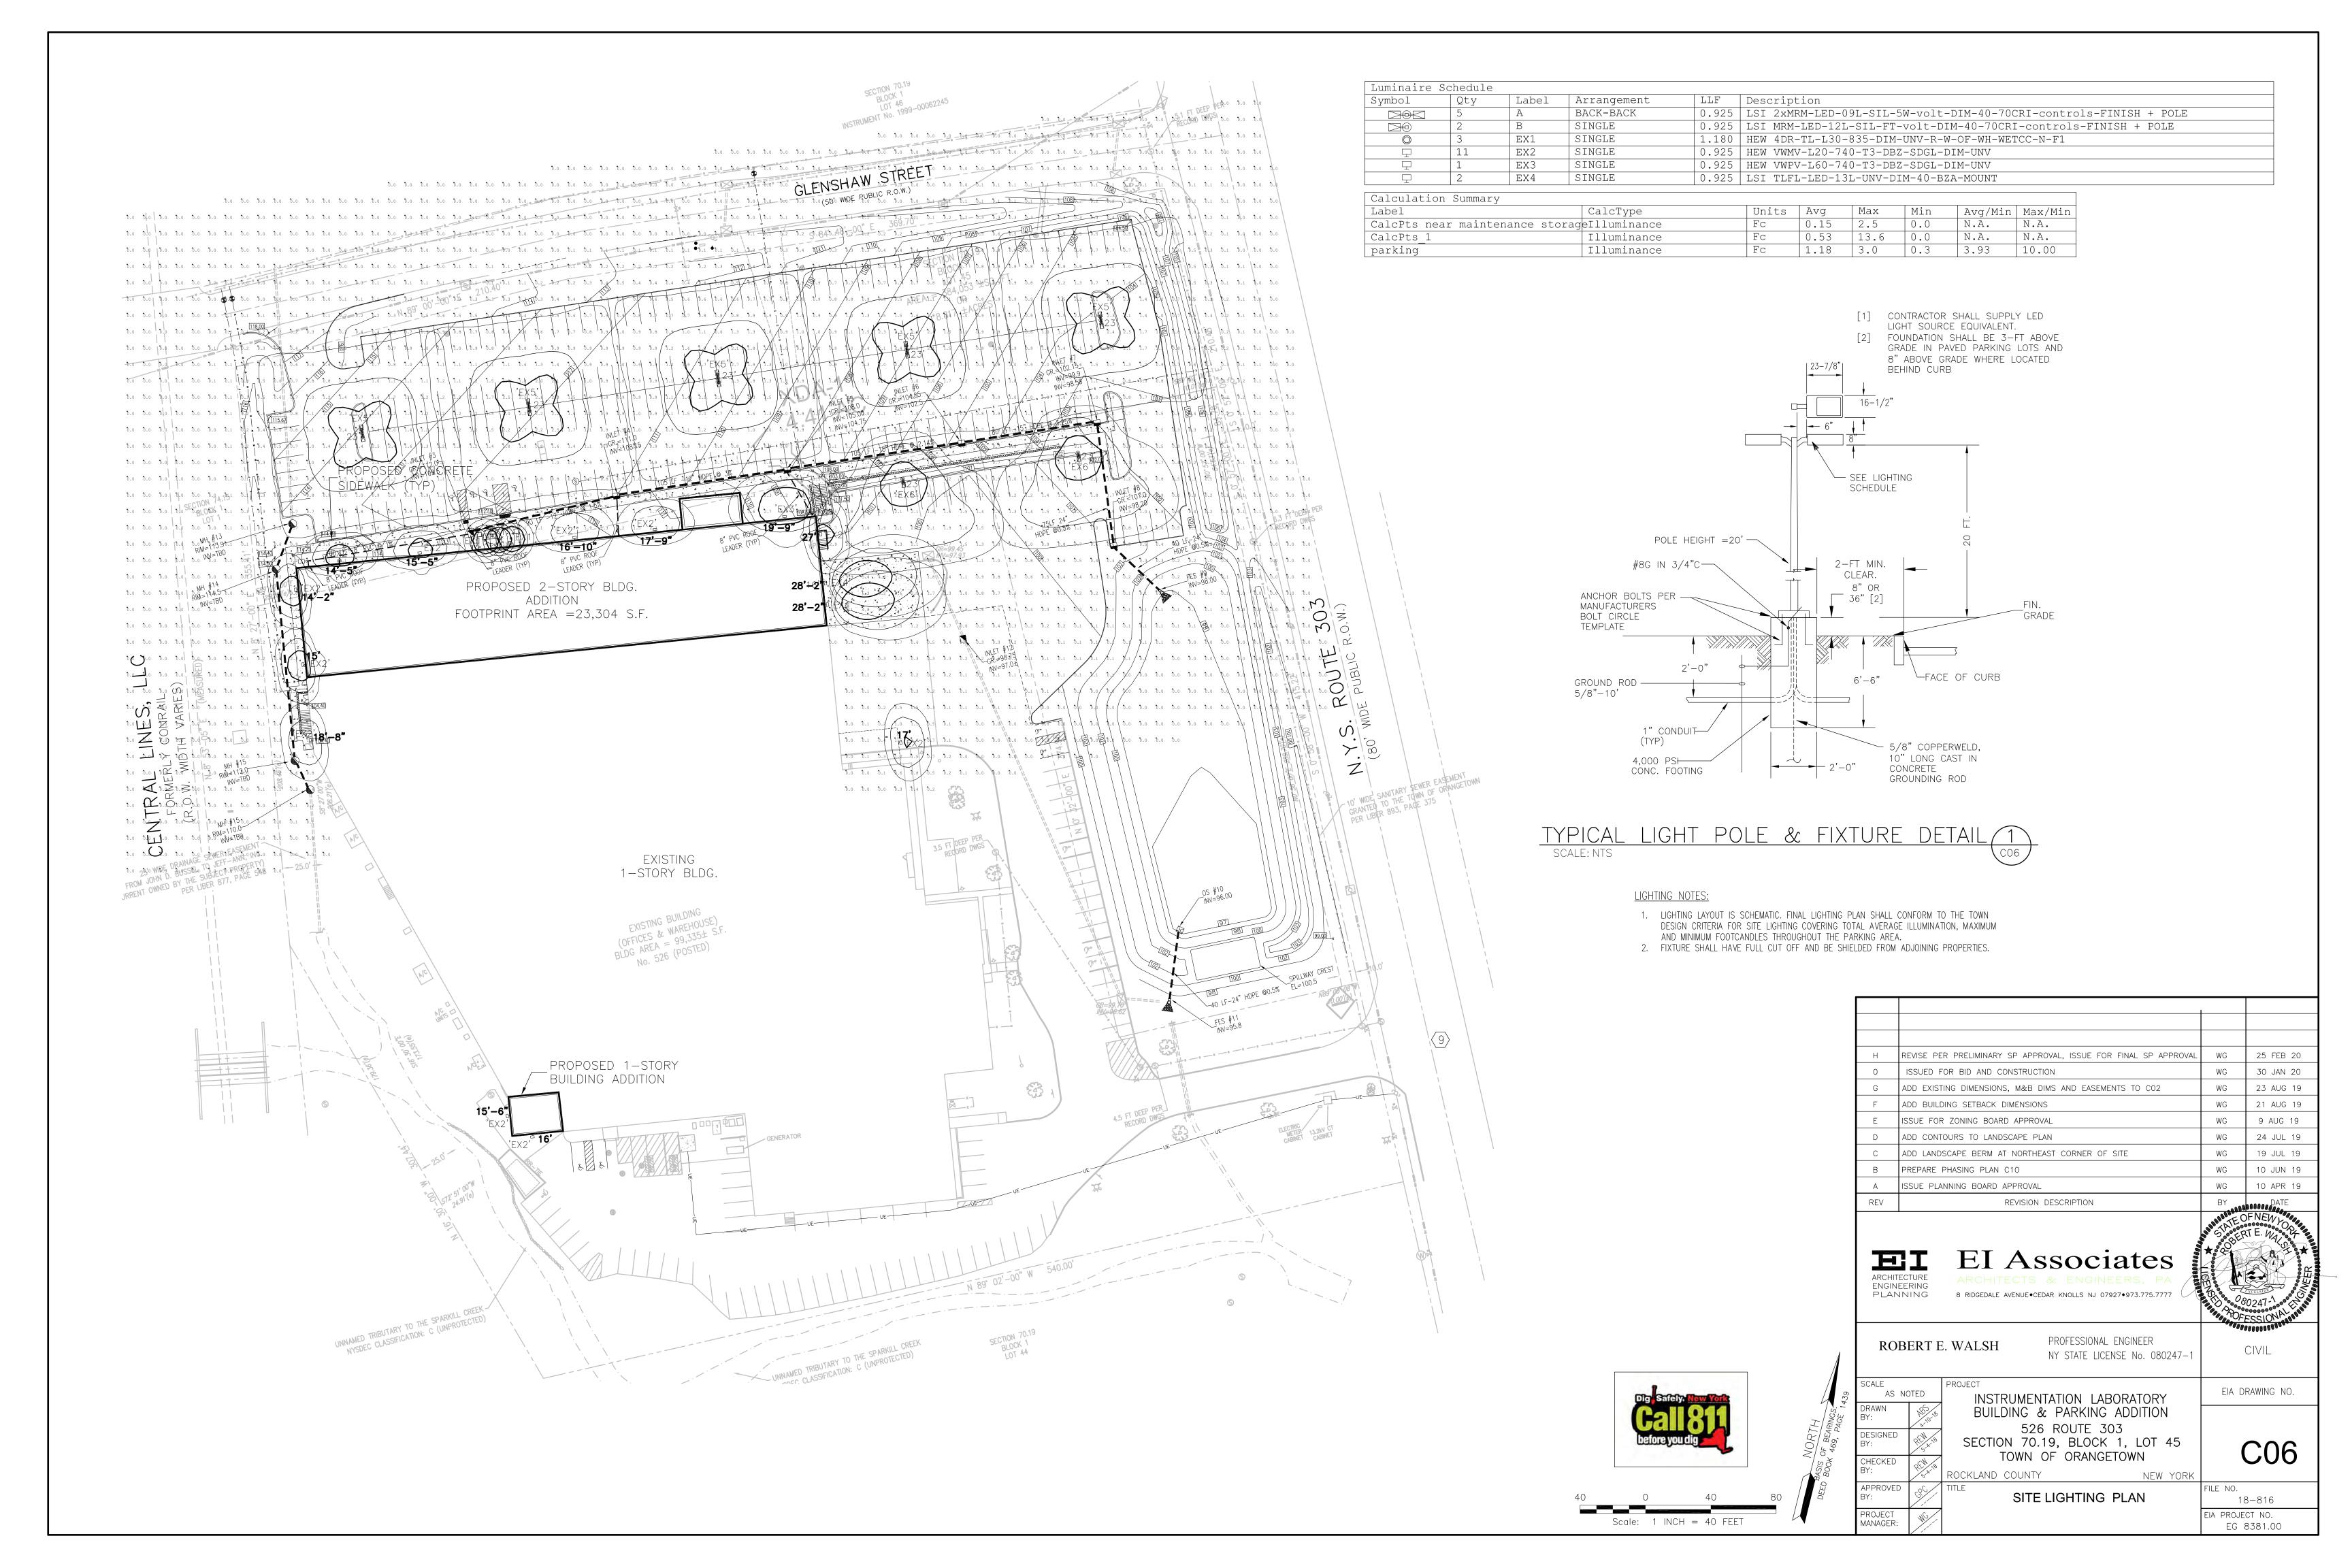

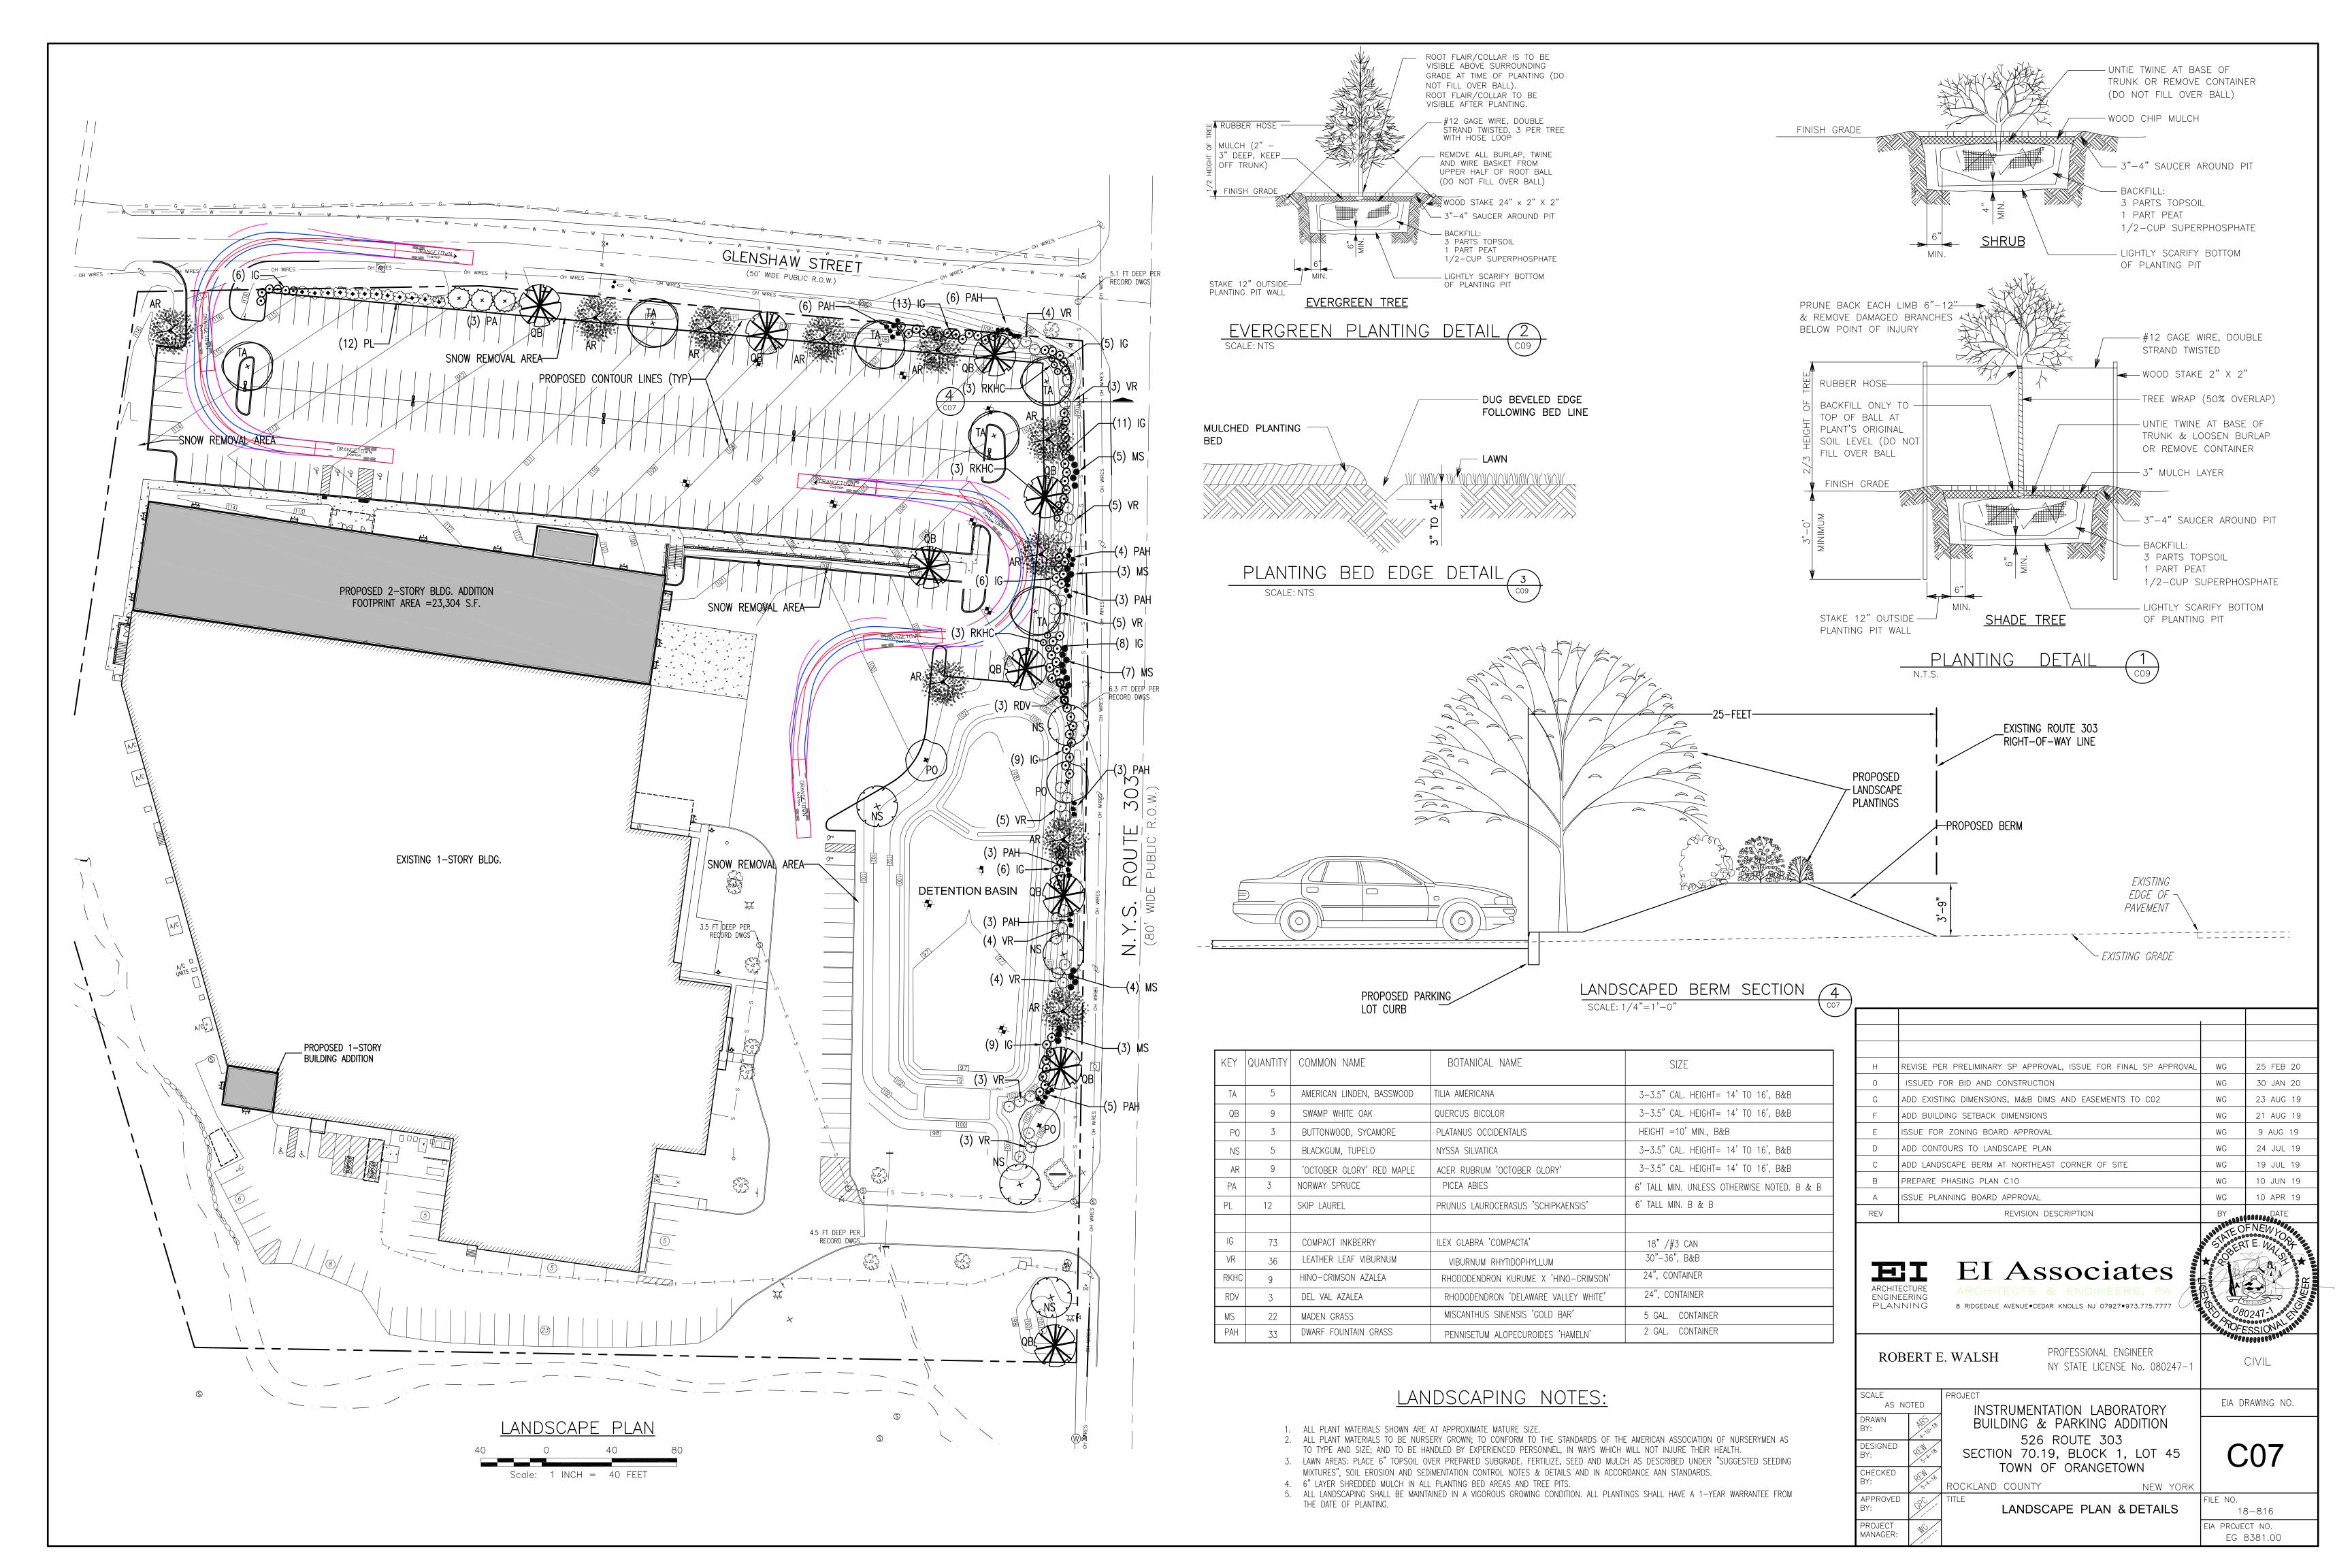

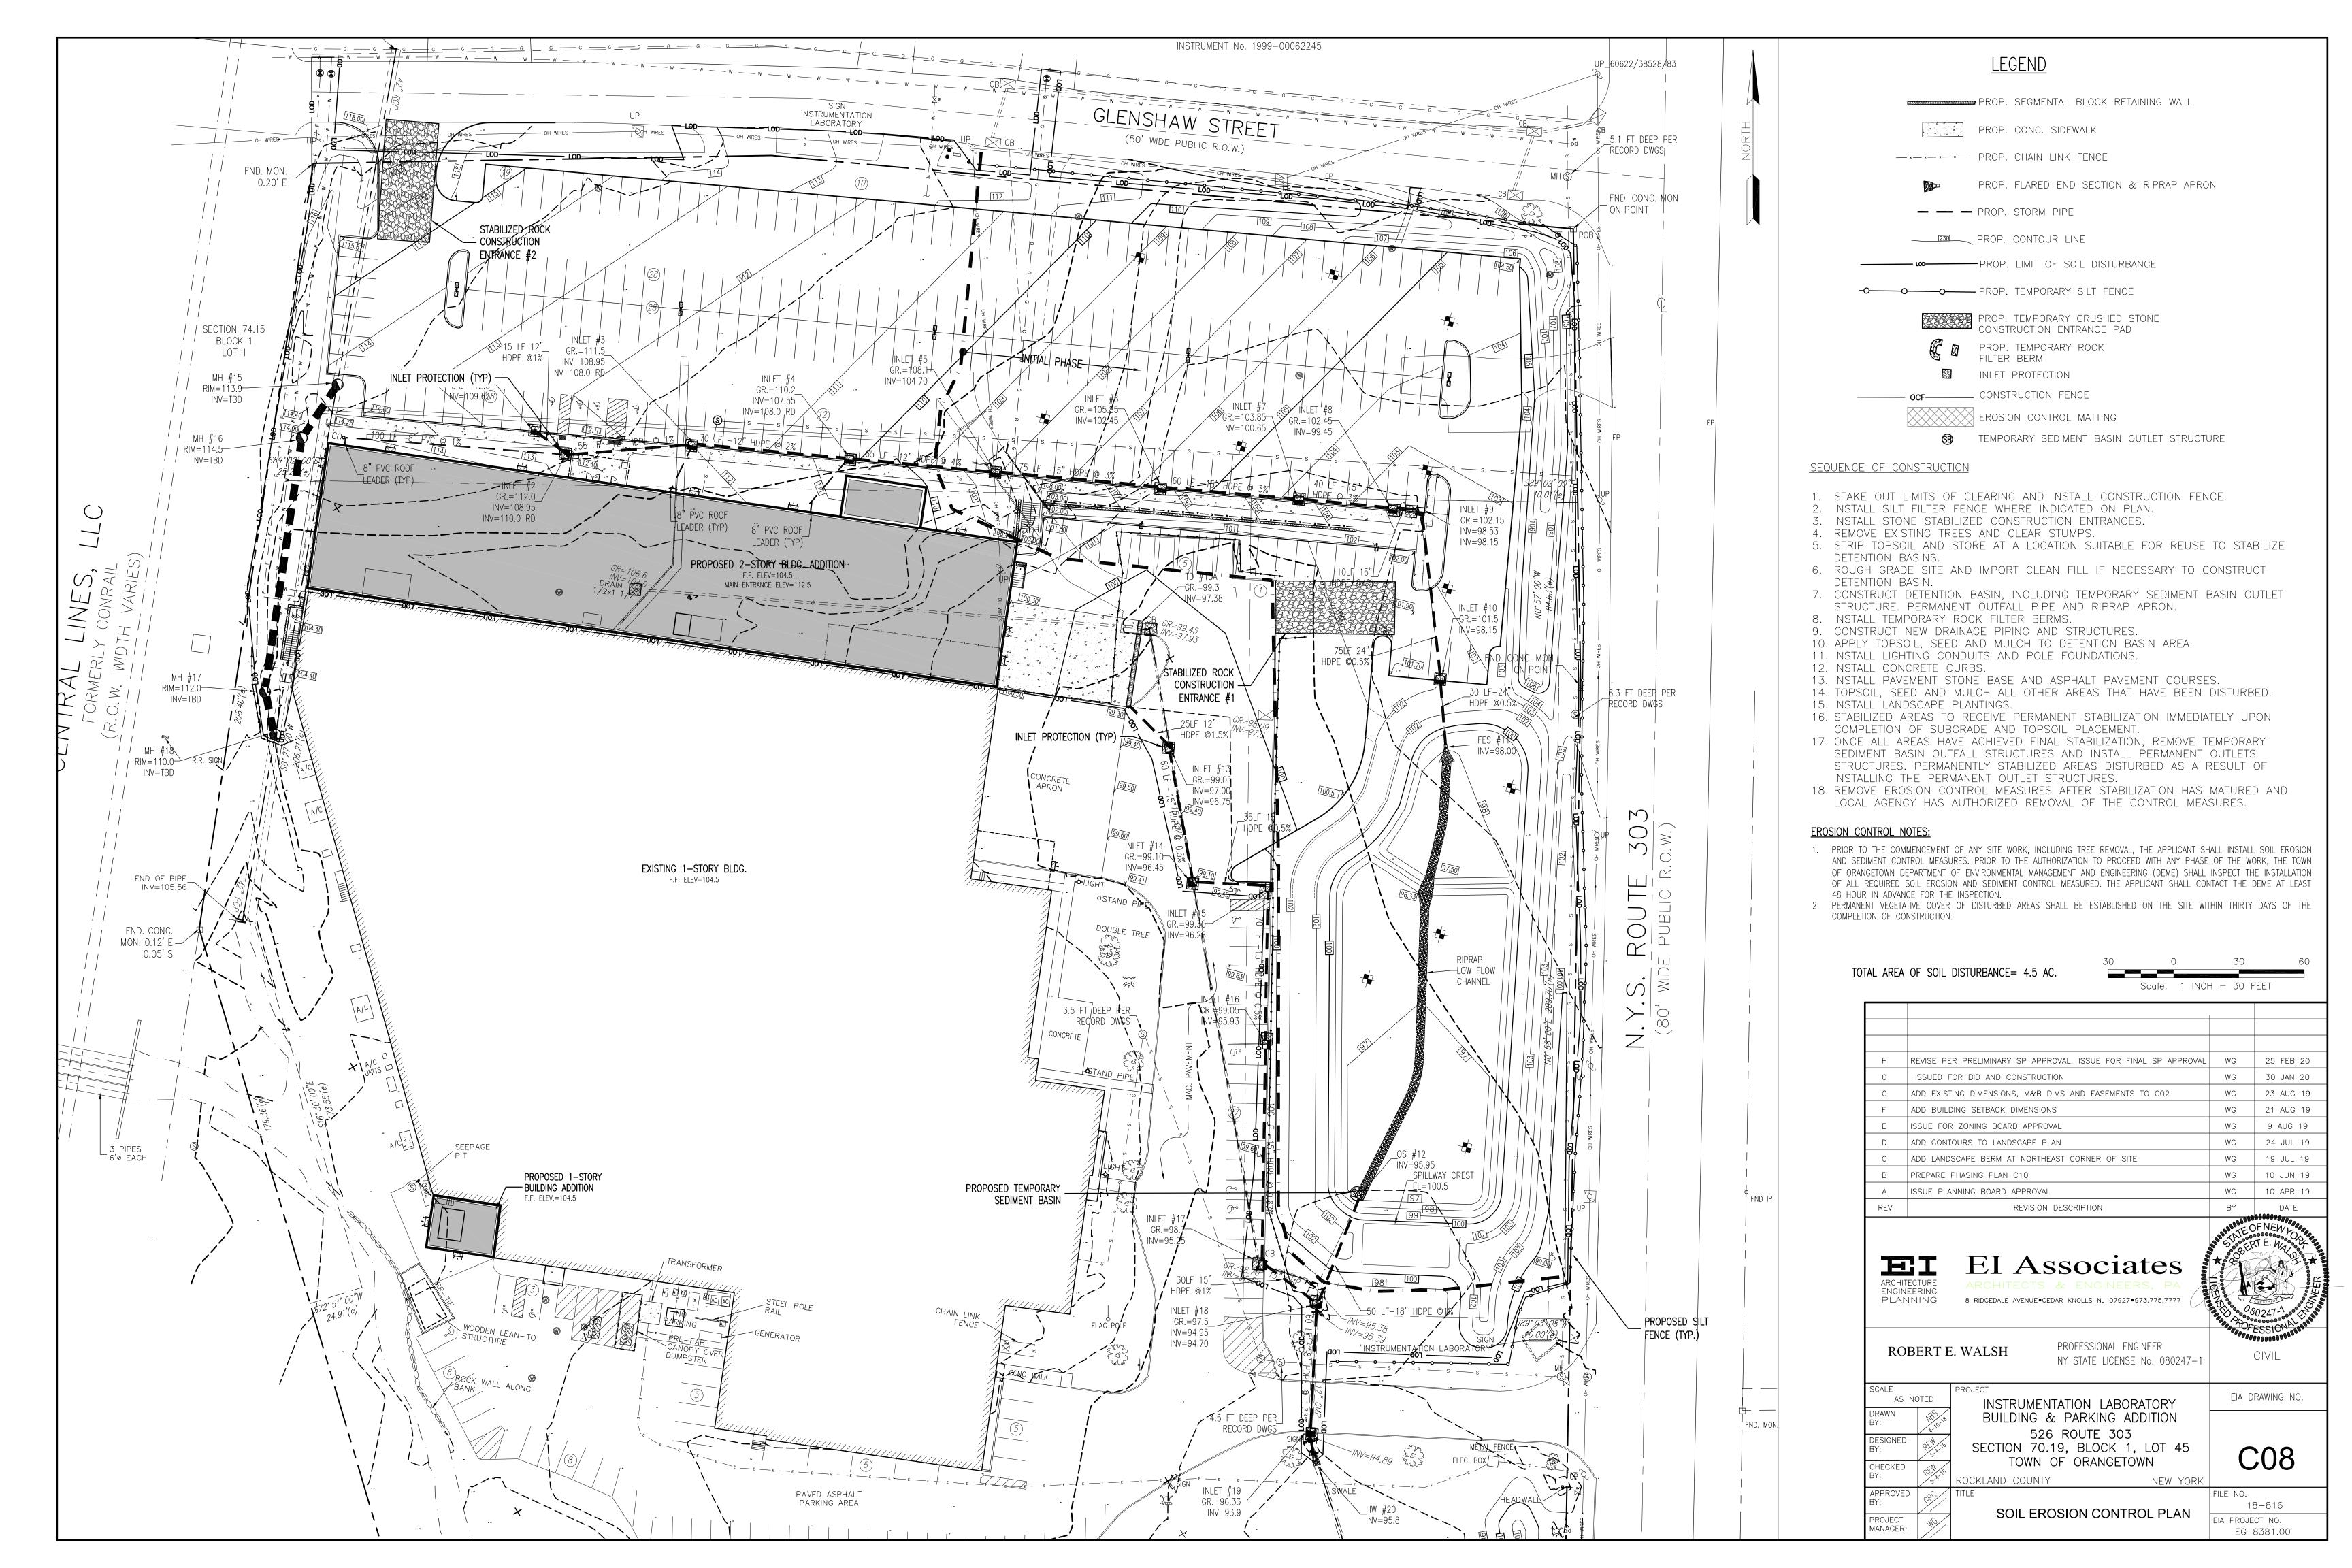

STANDARD EROSION CONTROL NOTES:

AN EROSION CONTROL SYSTEM WILL BE UTILIZED BY THE DEVELOPER TO MINIMIZE THE PRODUCTION OF SEDIMENT FROM THE SITE. METHODS TO BE UTILIZED WILL BE THOSE FOUND MOST EFFECTIVE FOR THE SITE AND SHALL INCLUDE ONE OR MORE OF THE FOLLOWING, AS APPLICABLE:

- 1. TEMPORARY SEDIMENTATION ENTRAPMENT AREAS SHALL BE PROVIDED AT KEY LOCATIONS TO INTERCEPT AND CLARIFY SILT LADEN RUNOFF FROM THE SITE. THESE MAY BE EXCAVATED OR MAY BE CREATED BY UTILIZING EARTHEN BERMS, RIP-RAP OR CRUSHED STONE DAMS, HAY BALES OR OTHER SUITABLE MATERIALS. DIVERSION SWALES, BERMS OR OTHER CHANNELIZATION SHALL BE CONSTRUCTED TO ENSURE THAT ALL SILT LADEN WATERS ARE DIRECTED INTO ENTRAPMENT AREAS, WHICH SHALL NOT BE PERMITTED TO FILL IN, BUT SHALL BE CLEANED PERIODICALLY DURING THE COURSE OF CONSTRUCTION. THE COLLECTED
- SILT SHALL BE DEPOSITED IN AREAS SAFE FROM FURTHER EROSION. 2. ALL DISTURBED AREAS, EXCEPT ROADWAYS, WHICH WILL REMAIN UNFINISHED FOR MORE THAT 30 DAYS SHALL BE TEMPORARILY SEEDED WITH 1/2 LB. OF RYE GRASS OR MULCHED WITH 100 LBS OF STRAW OR HAY PER 1,000 SQUARE FEET. ROADWAYS SHALL BE
- STABILIZED AS RAPIDLY AS PRACTICABLE BY THE INSTALLATION OF THE BASE COURSE 3. SILT THAT LEAVES THE SITE IN SPITE OF THE REQUIRED PRECAUTIONS SHALL BE COLLECTED AND REMOVED AS DIRECTED BY THE APPROPRIATE MUNICIPAL AUTHORITIES
- 4. AT THE COMPLETION OF THE PROJECT, ALL TEMPORARY SILTATION DEVICES SHALL BE REMOVED AND THE EFFECTED AREAS REGRADED, PLANTED OR TREATED IN ACCORDANCE WITH THE APPROVED SITE PLANS.

THE FOLLOWING MATERIALS AND APPLICATION RATES SHALL BE USED TO

MATERIALS	WATER DILUTION	TYPE_OF NOZZLE	APPLY GAL/ACRES
IONIC ASPHALT EMULSION	7:1	COARSE SPRAY	1200
LATEX EMULSION	12.5:1	FINE SPRAY	235
RESIN IN WATER	4:1	FINE SPRAY	300
POLYACRYLAMIDE (PAM)-SPRAY ON	PER MANUFACT.	PER MANUFACT.	PER MANUFACT.
POLYACRILAMIDE (PAM)-DRY SPREAD	SPEC.S	SPEC.S	SPEC.S
ACIDULATED SOY BEAN SOAP STICK	NONE	COARSE SPRAY	1200

EROSION & SEDIMENT CONTROL PLAN NOTES:

1. ALL SOIL EROSION AND SEDIMENT CONTROL PRACTICES SHALL BE INSTALLED IN ACCORDANCE WITH THE "NEW YORK STATE STANDARDS AND SPECIFICATIONS FOR EROSION AND SEDIMENT CONTROL" (NYS STANDARD SPECIFICATIONS), AND SHALL BE IN PLACE PRIOR TO ANY MAJOR SOIL DISTURBANCE, AND SHALL BE INSTALLED IN THE PROPER SEQUENCE AND MAINTAINED UNTIL PERMANENT STABILIZATION IS ESTABLISHED.

2. ANY DISTURBED AREA THAT WILL BE LEFT EXPOSED FOR MORE THAN THIRTY DAYS AND WILL NOT BE SUBJECT TO CONSTRUCTION TRAFFIC SHALL IMMEDIATELY RECEIVE A TEMPORARY SEEDING. IF THE SEASON PROHIBITS TEMPORARY SEEDING, THE DISTURBED AREA WILL BE MULCHED WITH STRAW OR HAY AND TACKED IN ACCORDANCE WITH THE NYS STANDARD SPECIFICATIONS. (SEE NOTE 18 BELOW)

3. PERMANENT VEGETATION IS TO BE ESTABLISHED ON EXPOSED AREAS WITHIN TEN (10) DAYS AFTER FINAL GRADING. MULCH IS TO BE USED FOR PROTECTION UNTIL VEGETATION IS ESTABLISHED. (SEE NOTE 19 BELOW)

4. IMMEDIATELY FOLLOWING INITIAL DISTURBANCE OR ROUGH GRADING, ALL CRITICAL AREAS (STEEP SLOPES, SANDY SOIL, WET CONDITIONS) SUBJECT TO EROSION WILL RECEIVE A TEMPORARY SEEDING IN ACCORDANCE WITH NOTE 18 BELOW.

5. PERMANENT SEEDING AND STABILIZATION TO BE IN ACCORDANCE WITH "STANDARDS FOR PERMANENT VEGETATIVE COVER FOR SOIL STABILIZATION COVER". SPECIFIED RATES AND LOCATIONS SHALL BE ON THE APPROVED SOIL EROSION AND SEDIMENT CONTROL PLAN.

6. THE SITE SHALL AT ALL TIMES BE GRADED AND MAINTAINED SO THAT ALL STORM WATER

RUNOFF IS DIVERTED TO SOIL EROSION AND SEDIMENT CONTROL FACILITIES.

7. ALL SEDIMENTATION STRUCTURES (SILT FENCE, INLET FILTERS, AND SEDIMENT BARRIERS) WILL BE INSPECTED AND MAINTAINED DAILY.

8. STOCKPILES SHALL NOT BE LOCATED WITHIN 50 FEET OF A FLOODPLAIN, SLOPE, DRAINAGE FACILITY, OR ROADWAY. ALL STOCKPILE BASES SHALL HAVE SILT FENCES PROPERLY ENTRENCHED AT THE TOE OF SLOPE.

9. A STABILIZED CONSTRUCTION ACCESS/ENTRANCE WILL BE INSTALLED. WHENEVER AN EARTHEN ROAD INTERSECTS WITH A PAVED ROAD. SEE STABILIZED CONSTRUCTION ACCESS DETAIL AND CHART FOR DIMENSIONS.

10. ALL NEW ROADWAYS WILL BE TREATED WITH SUITABLE SUBBASE UPON ESTABLISHMENT OF FINAL GRADE ELEVATIONS.

11. PAVED ROADWAYS MUST BE KEPT CLEAN AT ALL TIMES.

12. BEFORE DISCHARGE POINTS BECOME OPERATIONAL, ALL STORMWATER DRAINAGE OUTLETS WILL BE STABILIZED AS REQUIRED.

13. ALL DEWATERING OPERATIONS MUST BE DISCHARGED DIRECTLY INTO SEDIMENT FILTER AREAS. THE FILTER SHOULD BE COMPOSED OF A FABRIC OR APPROVED MATERIAL. SEE DEWATERING DETAIL IN STATE STANDARDS.

14. ALL SEDIMENT BASINS WILL BE CLEANED WHEN THE CAPACITY HAS BEEN REDUCED BY 50 %. A CLEAN OUT ELEVATION WILL BE IDENTIFIED ON THE PLAN AND A MARKER INSTALLED ON

MAINTENANCE AND UPKEEP OF THE DRAINAGE STRUCTURES, VEGETATIVE COVER, AND ANY OTHER EROSION CONTROL MEASURES.

15. DURING AND AFTER CONSTRUCTION, THE APPLICANT WILL BE RESPONSIBLE FOR THE

16. ALL TREES TO REMAIN ALONG THE OUTER EDGE OF THE LIMITS OF SOIL DISTURBANCE SHALL BE PROTECTED WITH TEMPORARY TREE PROTECTION FENCE.

17. TOPSOIL STOCKPILE PROTECTION:

A) APPLY GROUND LIMESTONE AT A RATE OF 90 LBS. PER 1000 S.F.

B) APPLY FERTILIZER (10-20-10) AT A RATE OF 11 LBS. PER 1000 S.F.

C) APPLY PERRENIAL RYEGRASS SEED AT A RATE OF 1 LBS. PER 1000 S.F. AND

ANNUAL RYEGRASS AT A RATE OF 1 LBS. PER 1000 S.F. D) MULCH STOCKPILE WITH STRAW OR HAY AT A RATE OF 90 LBS. PER 1000 S.F.

E) APPLY A LIQUID MULCH BINDER OR TACK TO STRAW OR HAY MULCH. F) PROPERLY ENTRENCH A SILT FENCE AT BOTTOM OF STOCKPILE.

18. TEMPORARY STABILIZATION SPECIFICATIONS:

A) APPLY GROUND LIMESTONE AT A RATE OF 90 LBS. PER 1000 S.F.

B) APPLY FERTILIZER (10-20-10) AT A RATE OF 11 LBS. PER 1000 S.F. C) APPLY PERRENIAL RYEGRASS SEED AT A RATE OF 1 LBS. PER 1000 S.F. AND

ANNUAL RYEGRASS AT A RATE OF 1 LBS. PER 1000 S.F.

D) MULCH STOCKPILE WITH STRAW OR HAY AT A RATE OF 90 LBS. PER 1000 S.F. E) APPLY A LIQUID MULCH BINDER OR TACK TO STRAW OR HAY MULCH.

19. PERMANENT STABILIZATION SPECIFICATIONS:

A) APPLY TOPSOIL TO A DEPTH OF 5 INCHES (UNSETTLED).

B) APPLY GROUND LIMESTONE AT A RATE OF 90 LBS. PER 1000 S.F. AND WORK


FOUR INCHES INTO SOIL.

C) APPLY FERTILIZER (10-20-10) AT A RATE OF 11 LBS. PER 1000 S.F.

D) APPLY HARD FESCUE SEED AT A RATE OF 2.7 LBS. PER 1000 S.F. AND CREEPING RED FESCUE AT A RATE OF 0.7 LBS. PER 1000 S.F. AND PERENNIAL RYEGRASS


SEED AT A RATE OF 0.25 LBS. PER 1000 S.F. E) MULCH STOCKPILE WITH STRAW OR HAY AT A RATE OF 90 LBS. PER 1000 S.F.

F) APPLY A LIQUID MULCH BINDER OR TACK TO STRAW OR HAY MULCH.

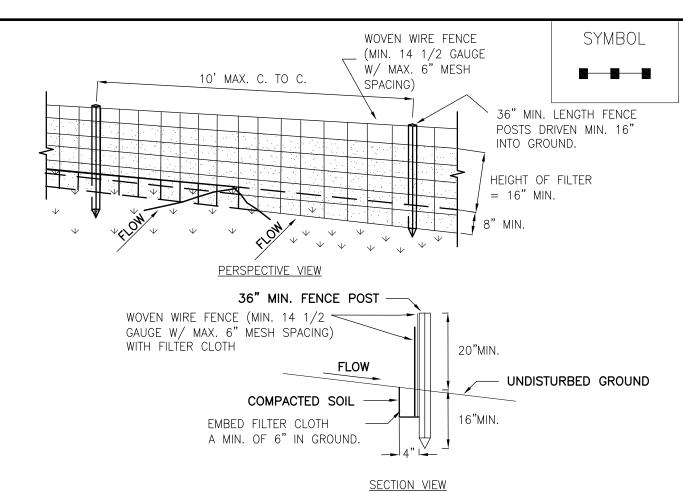

CONSTRUCTION SPECIFICATIONS

- 1. WOVEN WIRE FENCE TO BE FASTENED SECURELY TO FENCE POSTS WITH WIRE TIES OR STAPLES. POSTS SHALL BE STEEL EITHER "T" OR "U" TYPE OR HARDWOOD.
- 2. FILTER CLOTH TO BE TO BE FASTENED SECURELY TO WOVEN WIRE FENCE WITH TIES SPACED EVERY 24" AT TOP AND MID SECTION.
- FENCE SHALL BE WOVEN WIRE, 12 1/2 GAUGE, 6" MAXIMUM MESH OPENING. 3. WHEN TWO SECTIONS OF FILTER CLOTH ADJOIN EACH OTHER THEY SHALL BE OVER-LAPPED BY SIX INCHES AND FOLDED. FILTER CLOTH SHALL BE EITHER FILTER X, MIRAFI 100X, STABILINKA T140N, OR APPROVED EQUIVALENT.
- 4. PREFABRICATED UNITS SHALL BE GEOFAB, ENVIROFENCE, OR APPROVED EQUIVALENT.
- 5. MAINTENANCE SHALL BE PERFORMED AS NEEDED AND MATERIAL REMOVED WHEN

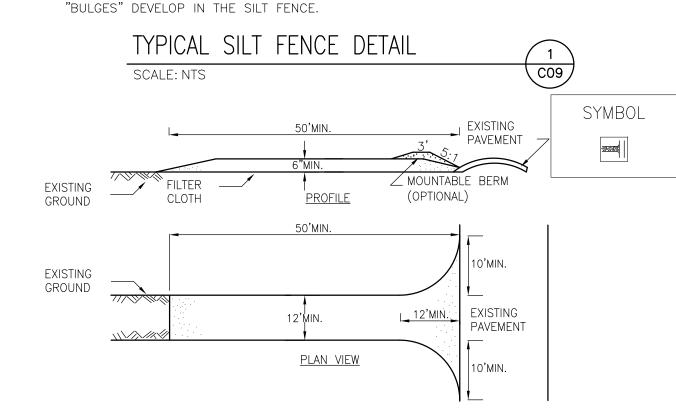

1. STONE SIZE - USE 2" STONE, OR RECLAIMED OR RECYCLED CONCRETE EQUIVALENT

2. LENGTH - NOT LESS THAN 50 FEET (EXCEPT ON A SINGLE RESIDENCE LOT WHERE

A 30 FOOT MINIMUM LENGTH WOULD APPLY). 3. THICKNESS - NOT LESS THAN SIX (6) INCHES.

4. WIDTH - TWELVE (12) FOOT MINIMUM, BUT NOT LESS THAN THE FULL WIDTH AT POINTS WHERE INGRESS OR EGRESS OCCURS. TWENTY-FOUR (24) FOOT IF SINGLE

5. FILTER CLOTH - WILL BE PLACED OVER THE ENTIRE AREA PRIOR TO PLACING OF STONE. FILTER CLOTH SHALL BE MIRAFI 100X OR APPROVED EQUAL.


6. SURFACE WATER - ALL SURFACE WATER FLOWING OR DIVERTED TOWARD CON-STRUCTION ENTRANCES SHALL BE PIPED ACROSS THE ENTRANCE. IF PIPING IS IMPRACTICAL, A MOUNTABLE BERM WITH 5:1 SLOPES WILL BE PERMITTED.

7. MAINTENANCE — THE ENTRANCE SHALL BE MAINTAINED IN A CONDITION WHICH WILL PREVENT TRACKING OR FLOWING OF SEDIMENT ONTO PUBLIC RIGHTS-OF-WAY, ALL SEDIMENT SPILLED, DROPPED, WASHED OR TRACTED ONTO PUBLIC RIGHTS-OF-WAY MUST BE REMOVED IMMEDIATELY.

8. WHEN WASHING IS REQUIRED, IT SHALL BE DONE ON A AREA STABILIZED WITH STONE AND WHICH DRAINS INTO AN APPROVED SEDIMENT TRAPPING DEVICE.

9. PERIODIC INSPECTION AND NEEDED MAINTENANCE SHALL BE PROVIDED AFTER EACH


STABILIZED ROCK CONSTRUCTION ENTRANCE DETAIL SCALE: NTS

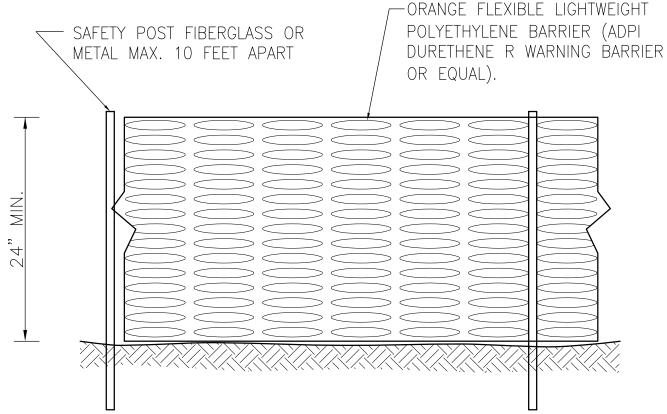



 FENCE SHALL SERVE AS PROTECTION OF EXISTING FORESTED WETLAND BUFFER 2. INSPECT BARRIER ON A DAILY BASIS AND IMMEDIATELY REPAIR ANY DAMAGED SECTIONS.

PLAN SYMBOL DENOTED AS: ——— OCF———— ORANGE CONSTRUCTION FENCE BARRIER DETAIL

SCALE: NTS

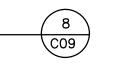

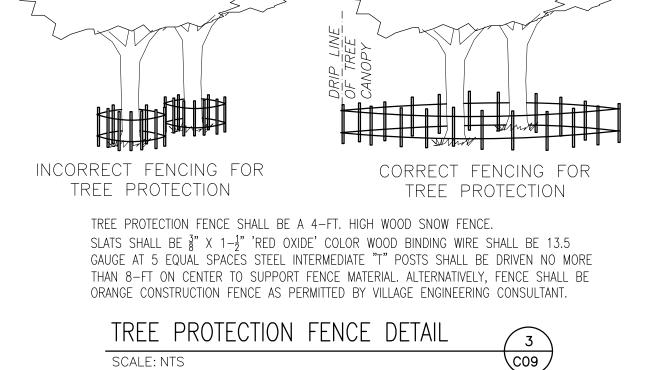

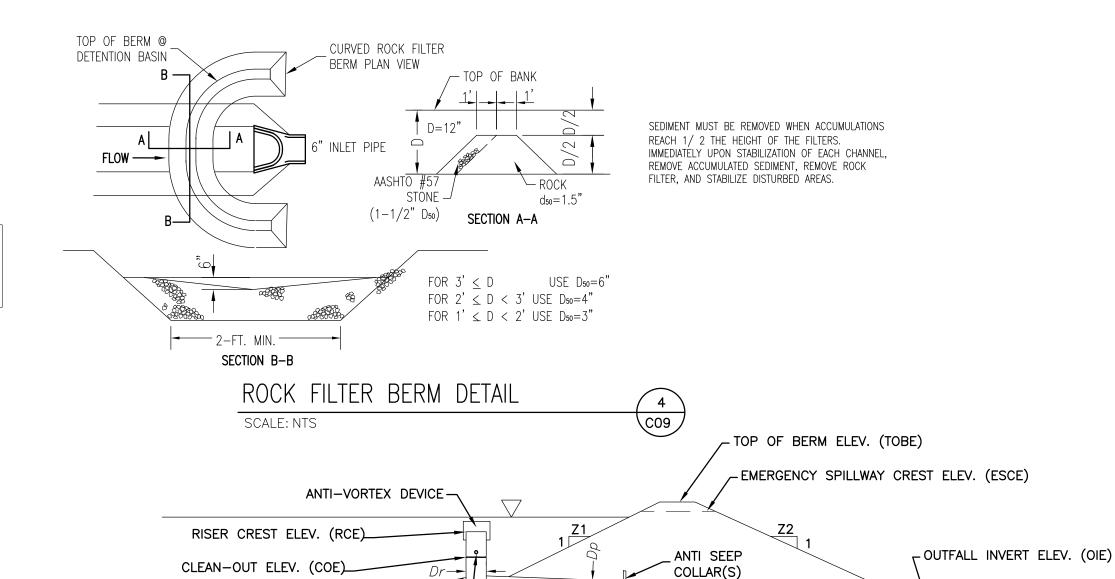

TEMP RISER —

CONCRETE BASE

SCALE: NTS

3/4" DIAMETER DEWATERING HOLE @ INV=97.0 ☐



——— LENGTH OF PIPE IN FEET (L)———

EMBANKMENT SECTION


► BARREL INVERT ELEV. (BIE)

2. SEDIMENT BASINS MUST BE PROTECTED FROM UNAUTHORIZED ACTS OF A THIRD


PARTY. 3. FILL MATERIAL FOR EMBANKMENTS SHALL BE FREE OF ROOTS, OR OTHER WOODY VEGETATION, ORGANIC MATERIAL. LARGE STONES, OR OTHER OBJECTIONABLE MATERIALS. THE EMBANKMENT SHALL BE COMPACTED IN MAXIMUM LIFTS OF 12 INCHES TO A MODIFIED PROCTOR DENSITY OF 85%.


	RISER & BARREL					EMBANKMENT/BERM							
	RISER BARREL			OUTLET	TOP	EMERGENCY	SLC	PES	CLEAN OUT				
BASIN NUMBER	DIA (IN)	ELEV (FT)	RISER	ELEV (FT)	DIA (IN)	BARREL	LENGTH (FT)	ELEV (FT)	ELEV (FT)	SPILLWAY ELEV. (FT)	INT (FT)	EXT (FT)	ELEV (FT)
	Dr	BIE	MAT'L	RCE	Dp	MAT'L	L	OIE	TOBE	ESCE	Z1	Z2	COE
1	24"	96.0	CMP	99.5	24"	HDPE	40.0	95.8	102.0	100.5	3	3	96.7
1	24"	96.0	CMP	99.5	24"	HDPE	40.0	95.8	102.0	100.5	3	3	



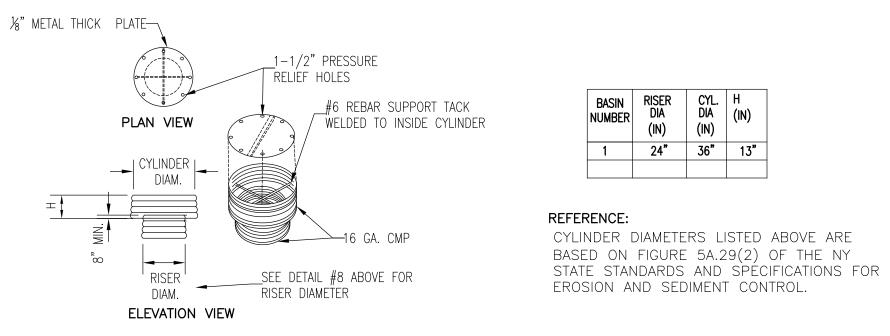

TEMPORARY CONCENTRIC TRASH RACK & ANTI-VORTEX DEVICE

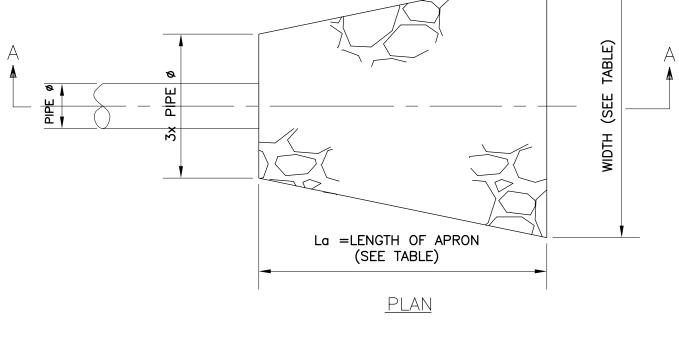

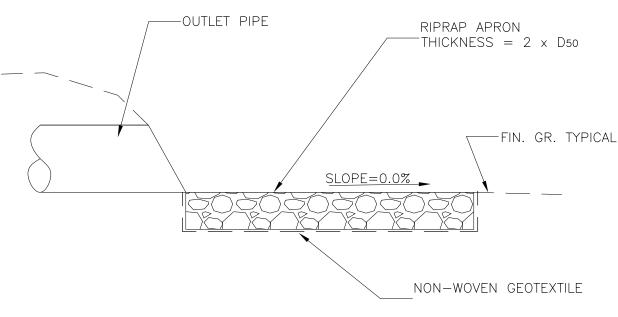




SECTION "A-A"

STRUCTURE NO.	PIPE DIAM. (FT.)	D50 (IN.)	APRON THICKNESS (IN.)	APRON WIDTH (FT.)	APRON LENGTH (FT.)
FES #11	2.0	6	12	13	10

Н	REVISE PER PRELIMINARY SP APPROVAL, ISSUE FOR FINAL SP APPROVAL	WG	25 FEB 20
0	ISSUED FOR BID AND CONSTRUCTION	WG	30 JAN 20
G	ADD EXISTING DIMENSIONS, M&B DIMS AND EASEMENTS TO CO2	WG	23 AUG 1
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В	PREPARE PHASING PLAN C10	WG	10 JUN 19
А	ISSUE PLANNING BOARD APPROVAL	WG	10 APR 19
REV	REVISION DESCRIPTION	BY	BOOO OATE

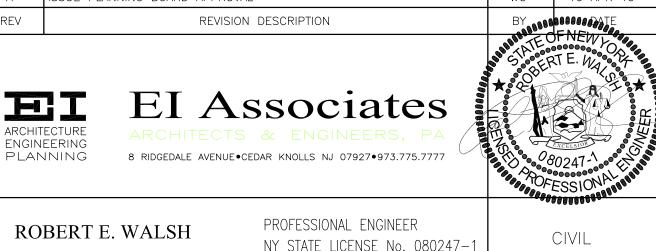

		W SIME EIGENSE	110. 000217				
CALE		PROJECT					
AS NOTED		INSTRUMENTATION LABORATORY					
RAWN ':	185,10	BUILDING & PARKING ADI	DITION				
	/ K `	526 ROUTE 303					
SIGNED :	REM 18	SECTION 70.19, BLOCK 1,					
HECKED	06/11/0	TOWN OF ORANGETOV	VIN				
' :	15/4/10	ROCKLAND COUNTY	NEW YORK				
PPROVED	~ ~	TITLE					

PROJECT

ANAGER:

EIA DRAWING NO. FILE NO.

18-816 **EROSION CONTROL** EIA PROJECT NO. DETAILS & NOTES EG 8381.00